
DOCKETED	
Docket Number:	20-SPPE-02
Project Title:	Lafayette Backup Generating Facility
TN #:	234294
Document Title:	Digital Realty Responses to Data Request Set 1 - LBGF (Part 2)
Description:	N/A
Filer:	Scott Galati
Organization:	DayZenLLC
Submitter Role:	Applicant Representative
Submission Date:	8/12/2020 11:50:24 AM
Docketed Date:	8/12/2020

CIVIL DRAWING SET

C0.0 through C6.0



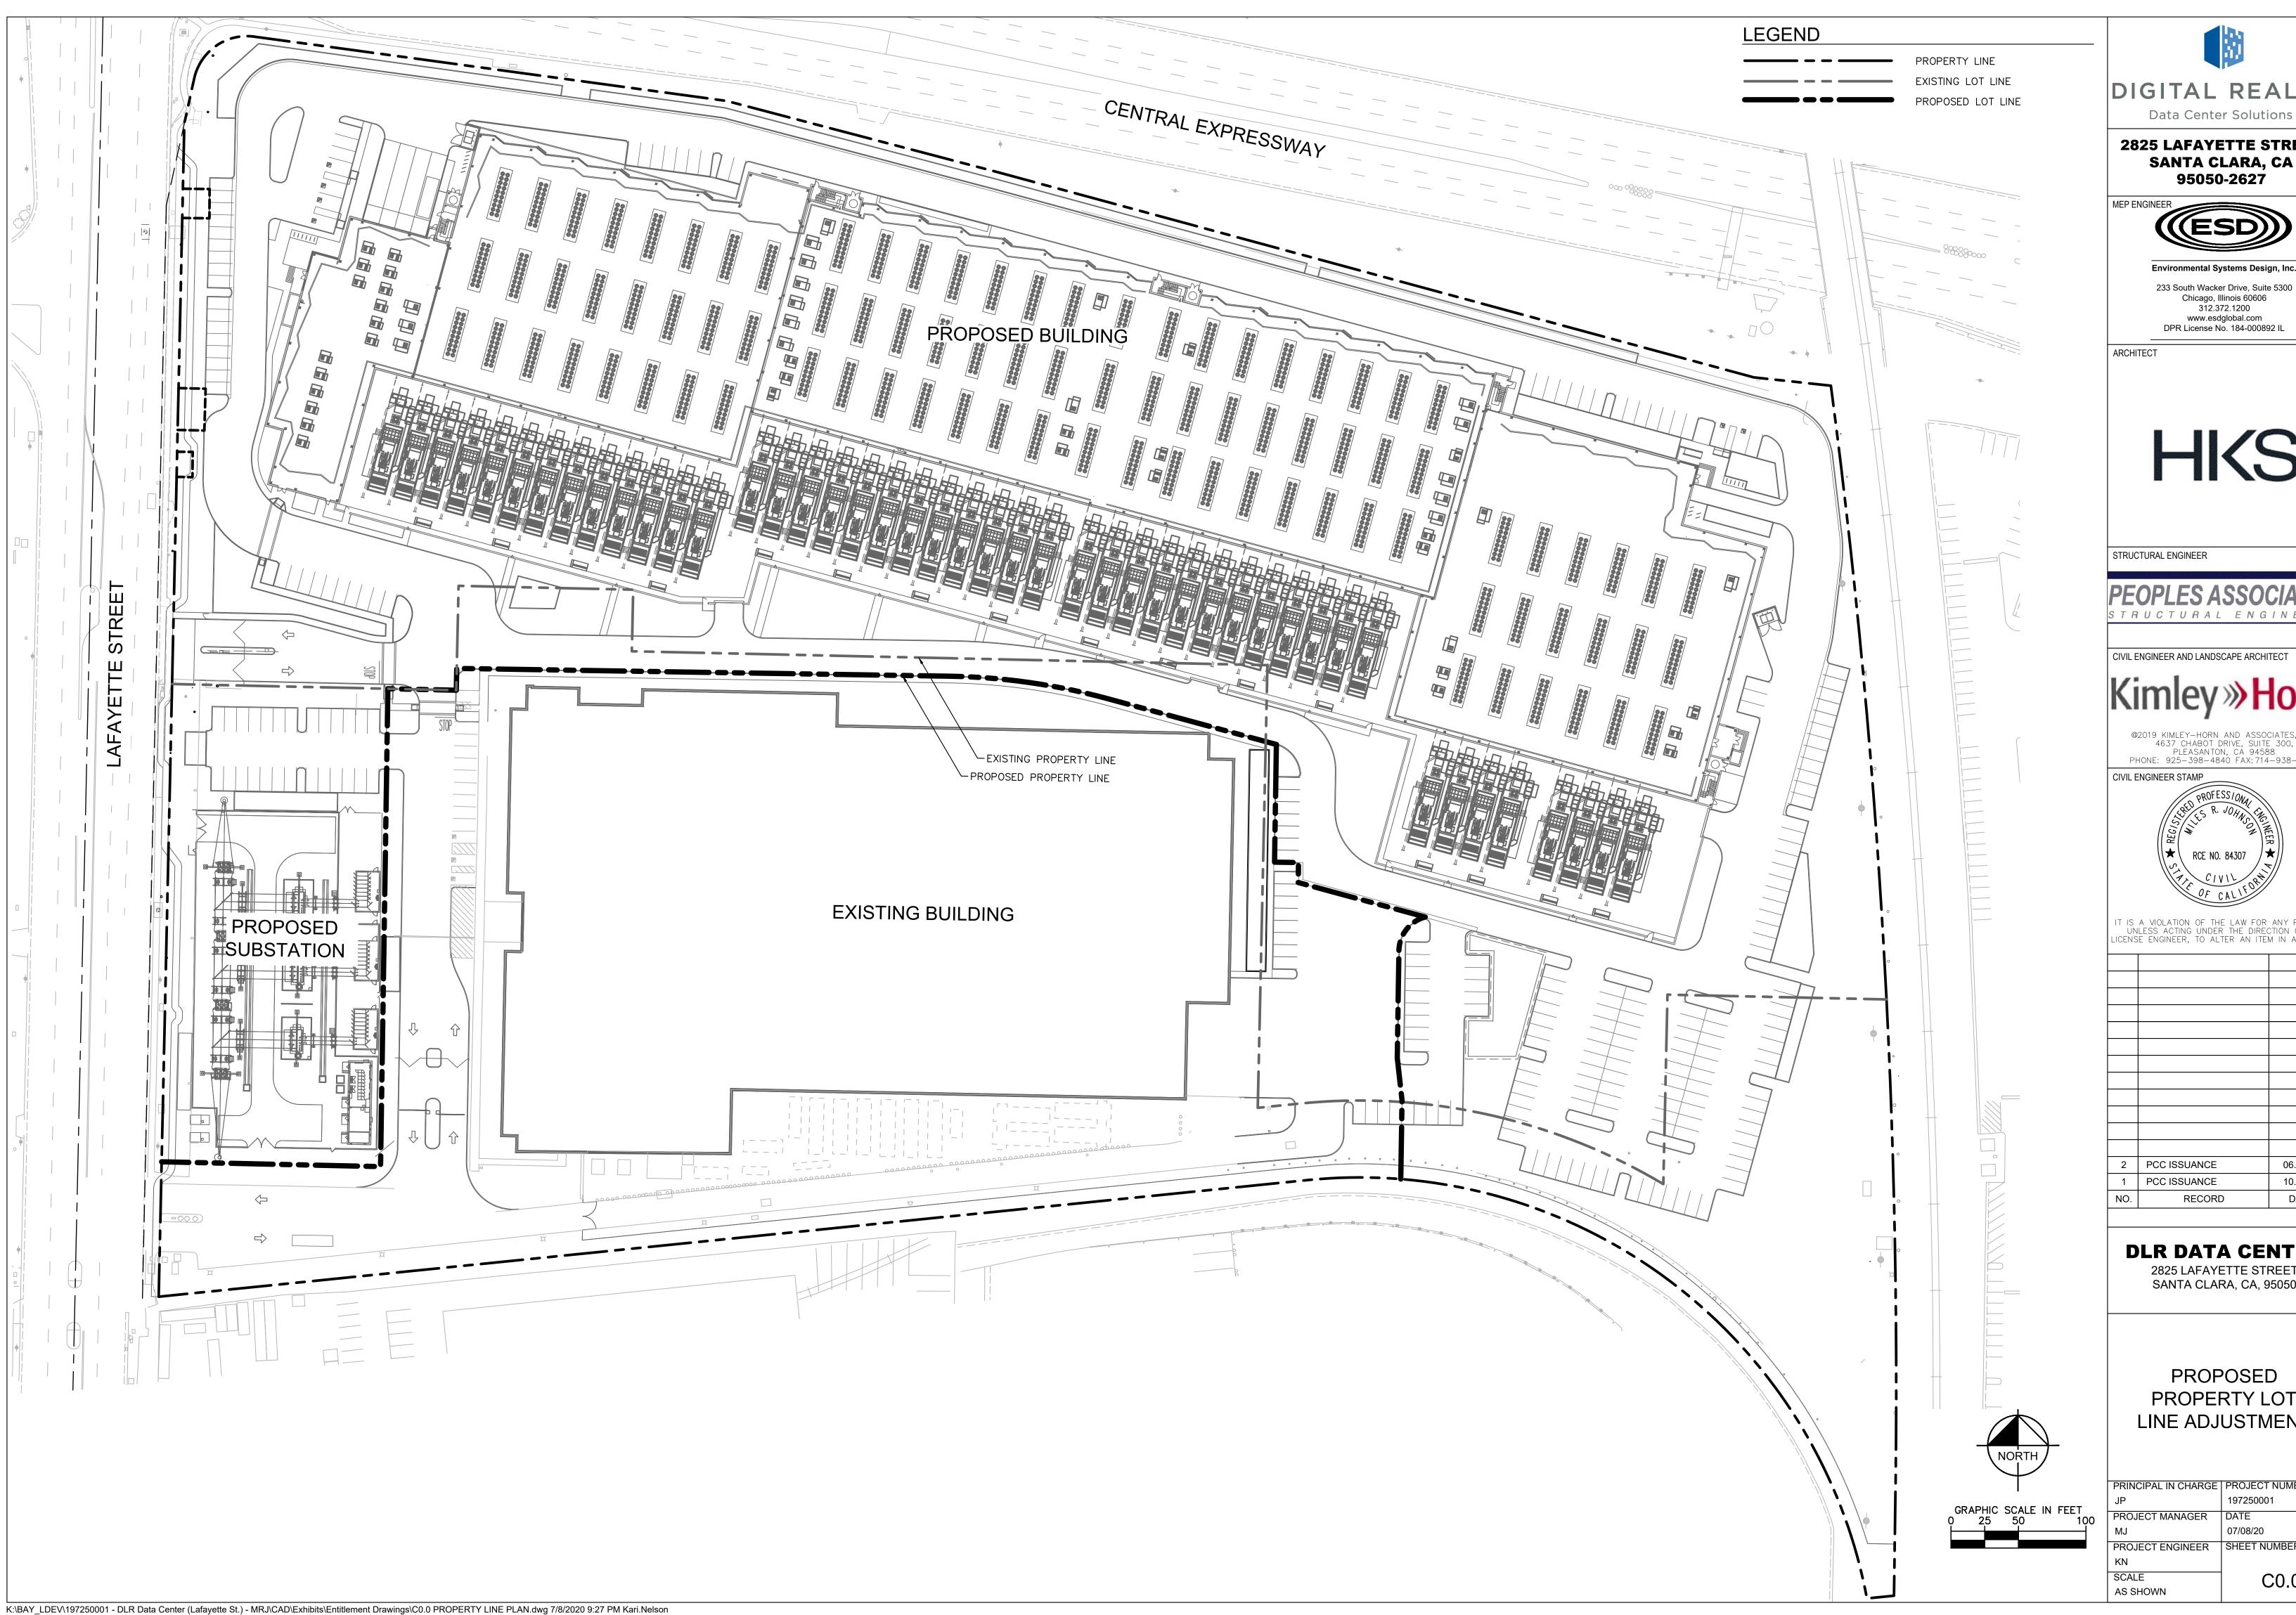

2825 LAFAYETTE STREET SANTA CLARA, CA

95050-2627



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STRUCTURAL ENGINEER

CIVIL ENGINEER AND LANDSCAPE ARCHITECT

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2	PCC ISSUANCE	06.19.20
1	PCC ISSUANCE	10.07.19
NO.	RECORD	DATE

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PROPOSED PROPERTY LOT LINE ADJUSTMENT

PRINCIPAL IN CHARGE | PROJECT NUMBER PROJECT MANAGER PROJECT ENGINEER SHEET NUMBER C0.0



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Kimley » Horr

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PLEASANTON, CA 94588
PHONE: 925-398-4840 FAX: 714-938-9488

CIVIL ENGINEER STAMP




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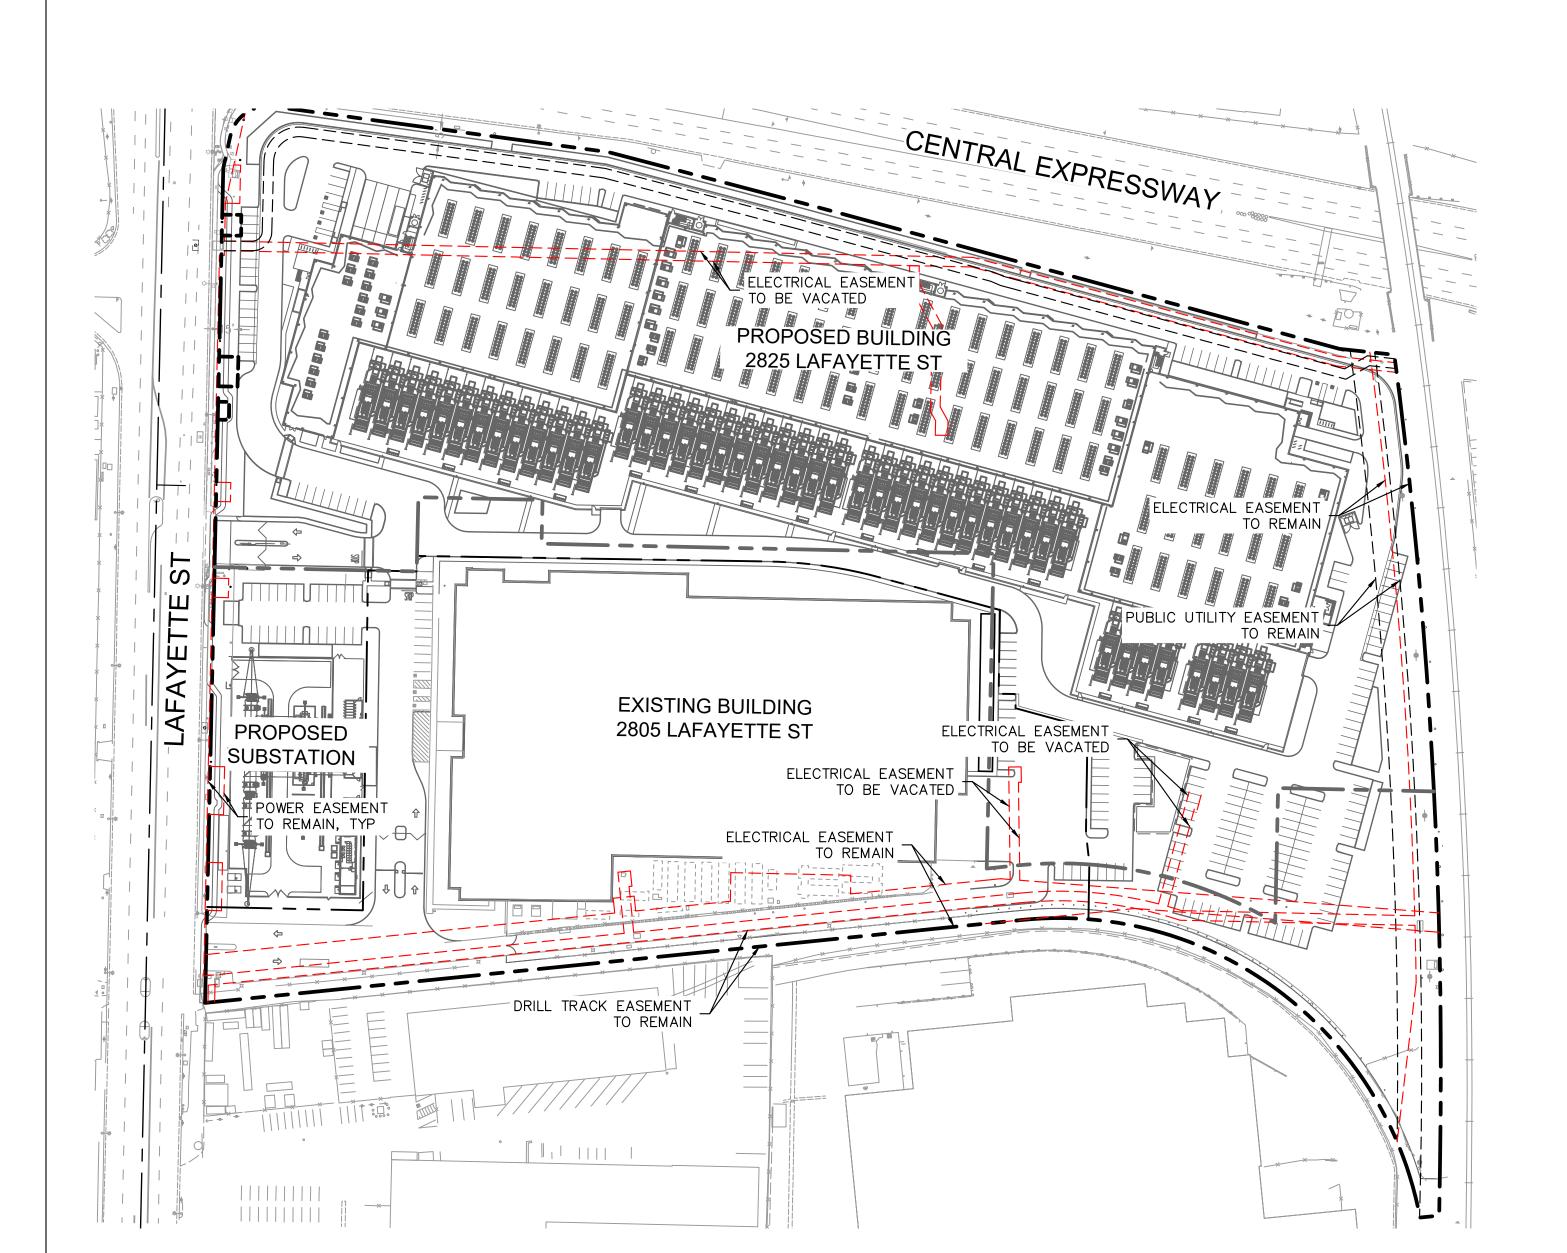
2	PCC ISSUANCE	06.19.20
1	PCC ISSUANCE	10.07.19
10.	RECORD	DATE


DLR DATA CENTER


2825 LAFAYETTE STREET SANTA CLARA, CA, 95050


EASEMENT PLAN



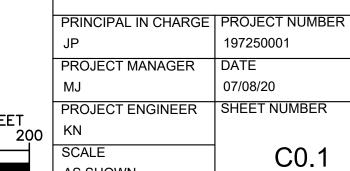

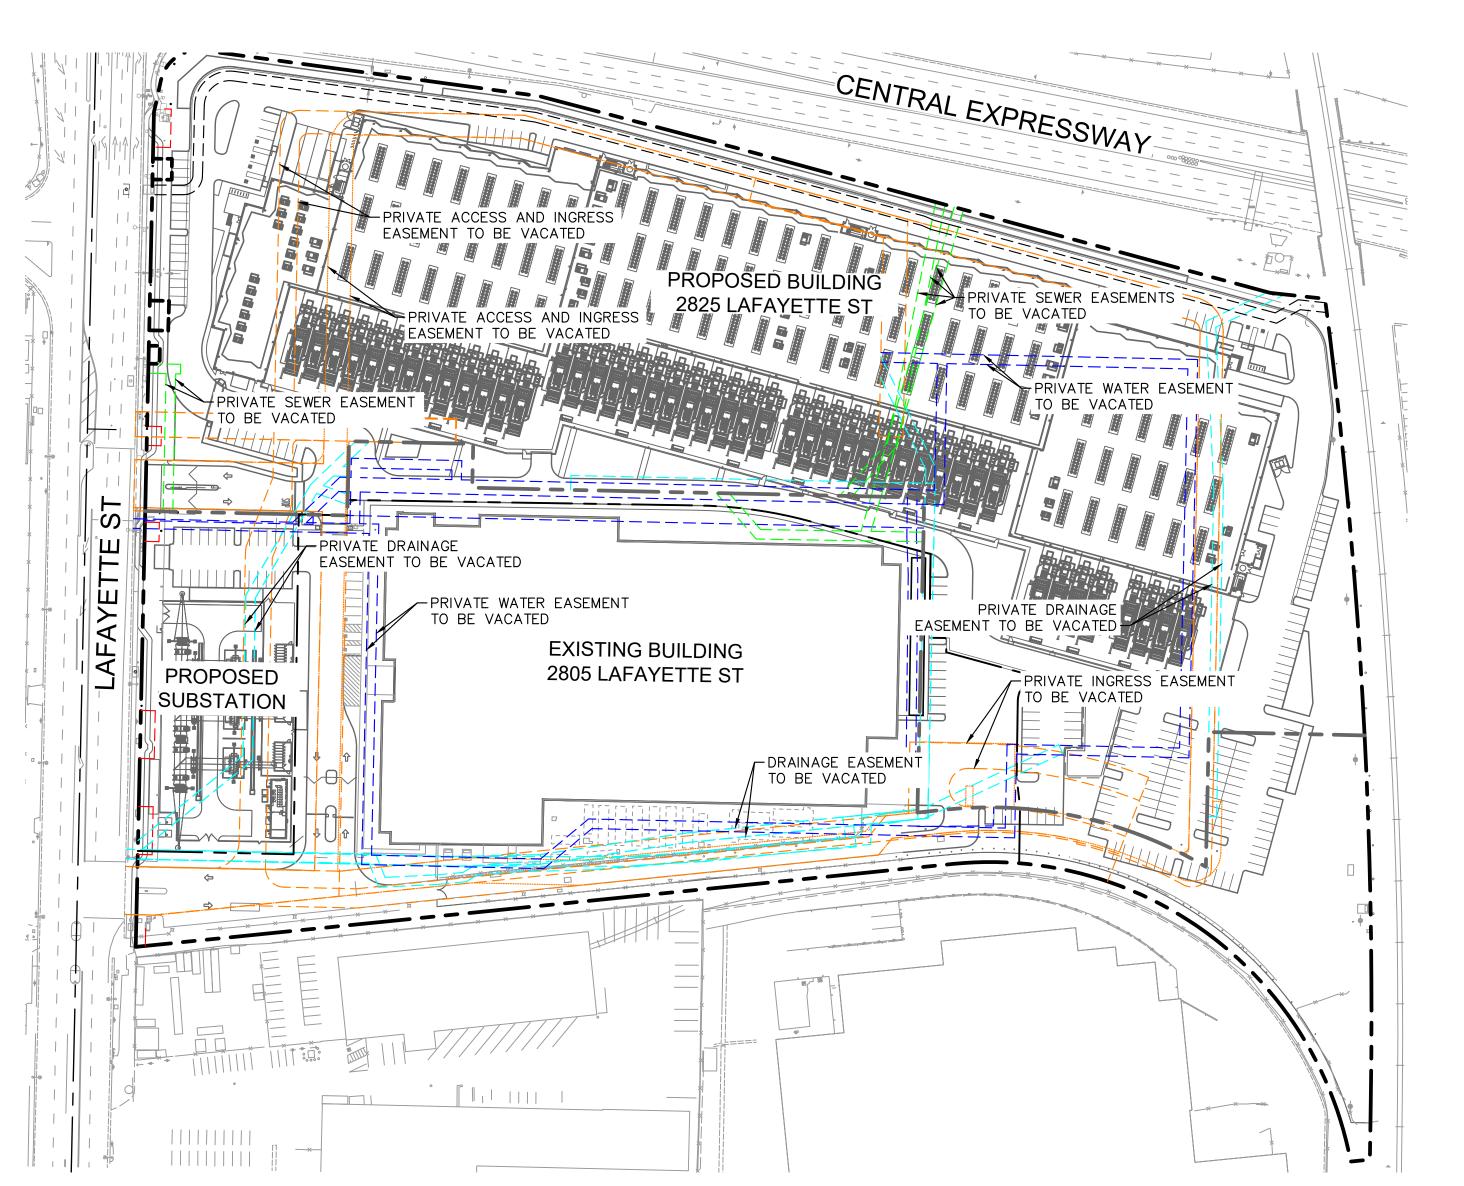

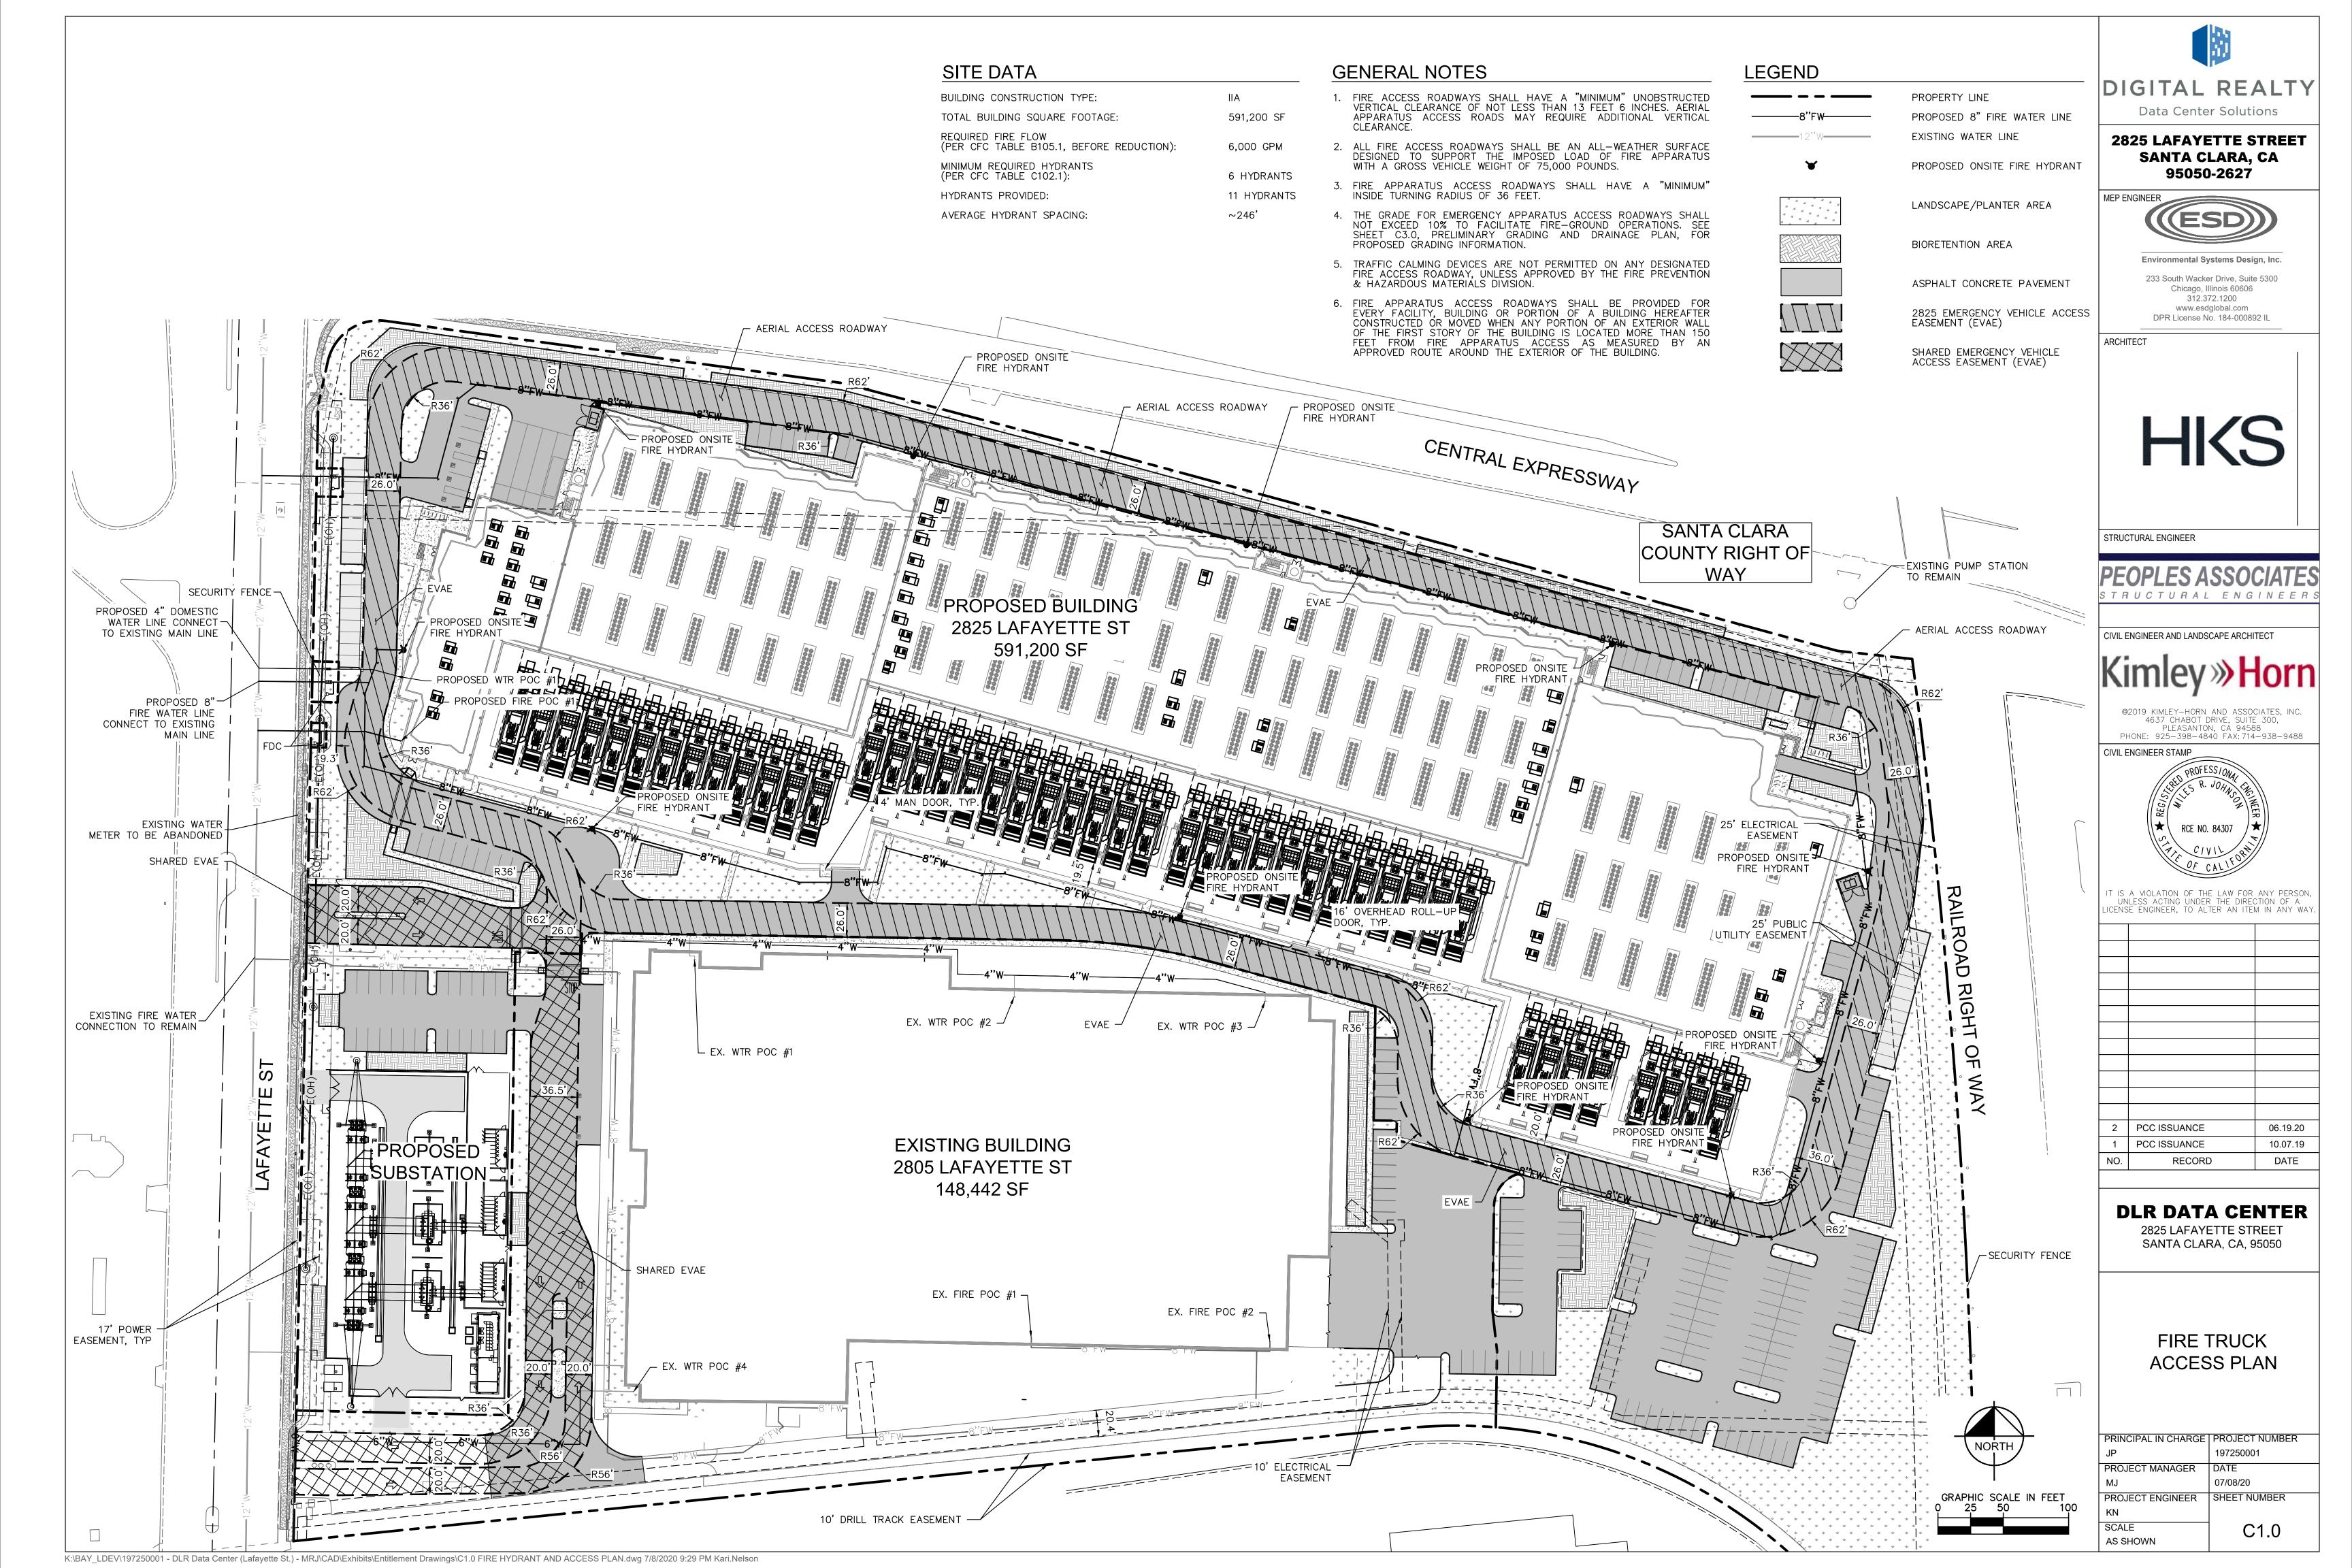

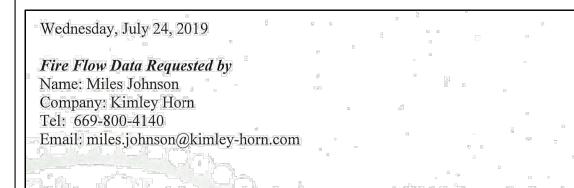


You have requested fire flow data for the area around 2825 Lafayette St. Results provided are from fire hydrant flow test #751. Flow data was obtained from hydrant #285, and pressure data was obtained from hydrant #1760, as shown on the attached water utility map. The flow hydrants are connected to a 12" water main.


Test Flow (GPM) was computed, per National Fire Protection Association 291, by the Hazen-Williams Equation and multiplied by a Hydrant Coefficient value of 0.83.


	Static	Residual	Opening	Te
Date of Fire Flow Test #751	Pressure	Pressure	Size	Flo
	PSI	PSI	Inches	GF
Wednesday, July 17, 2019	71	64	4	2,3


Fire Flow Graphical Analysis					
	= Manual Input				
	= Calculated Demand				
	Pressure Flow Rate				
Static	71	0			
Observed	64 2378				
Demand	68.0 1500				

Do Not Modify							
71	0	0					
64	1761943	3524					
Х	751223	1502					

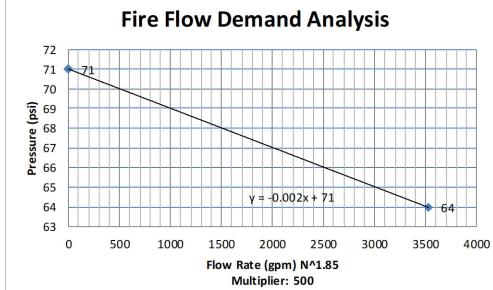

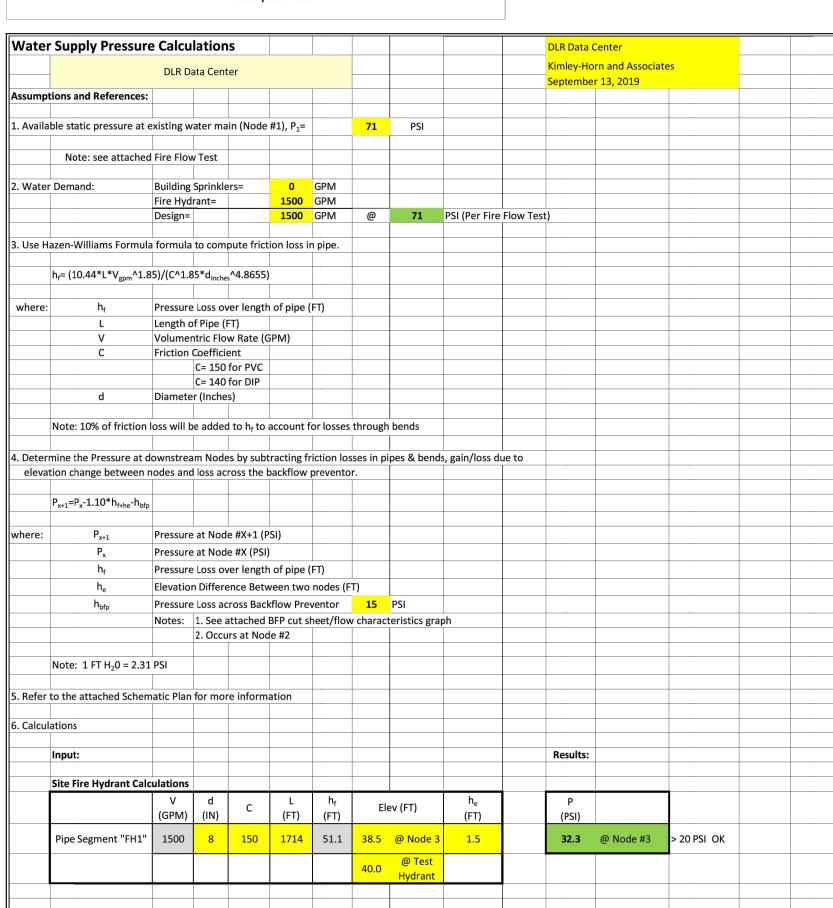

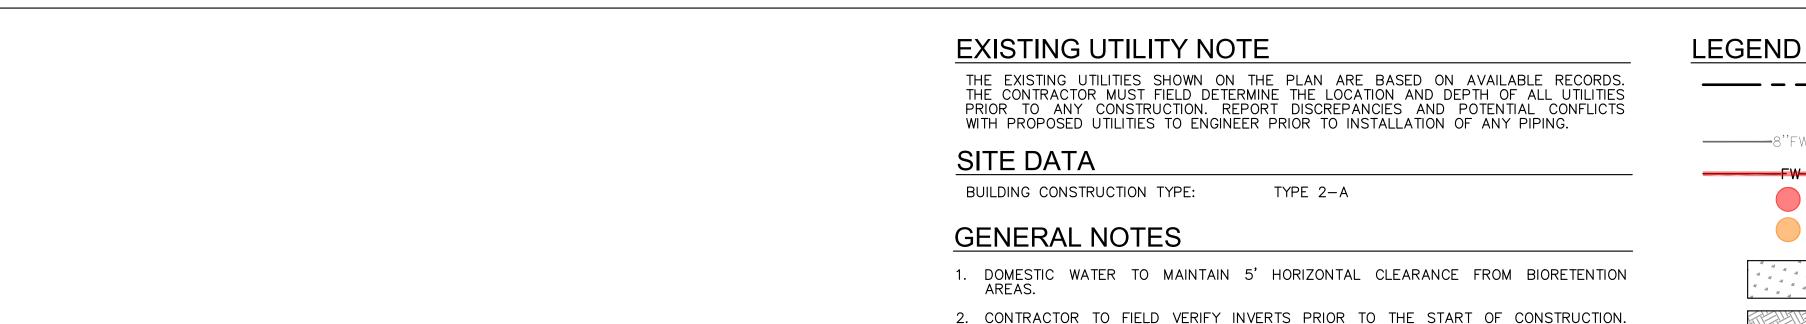

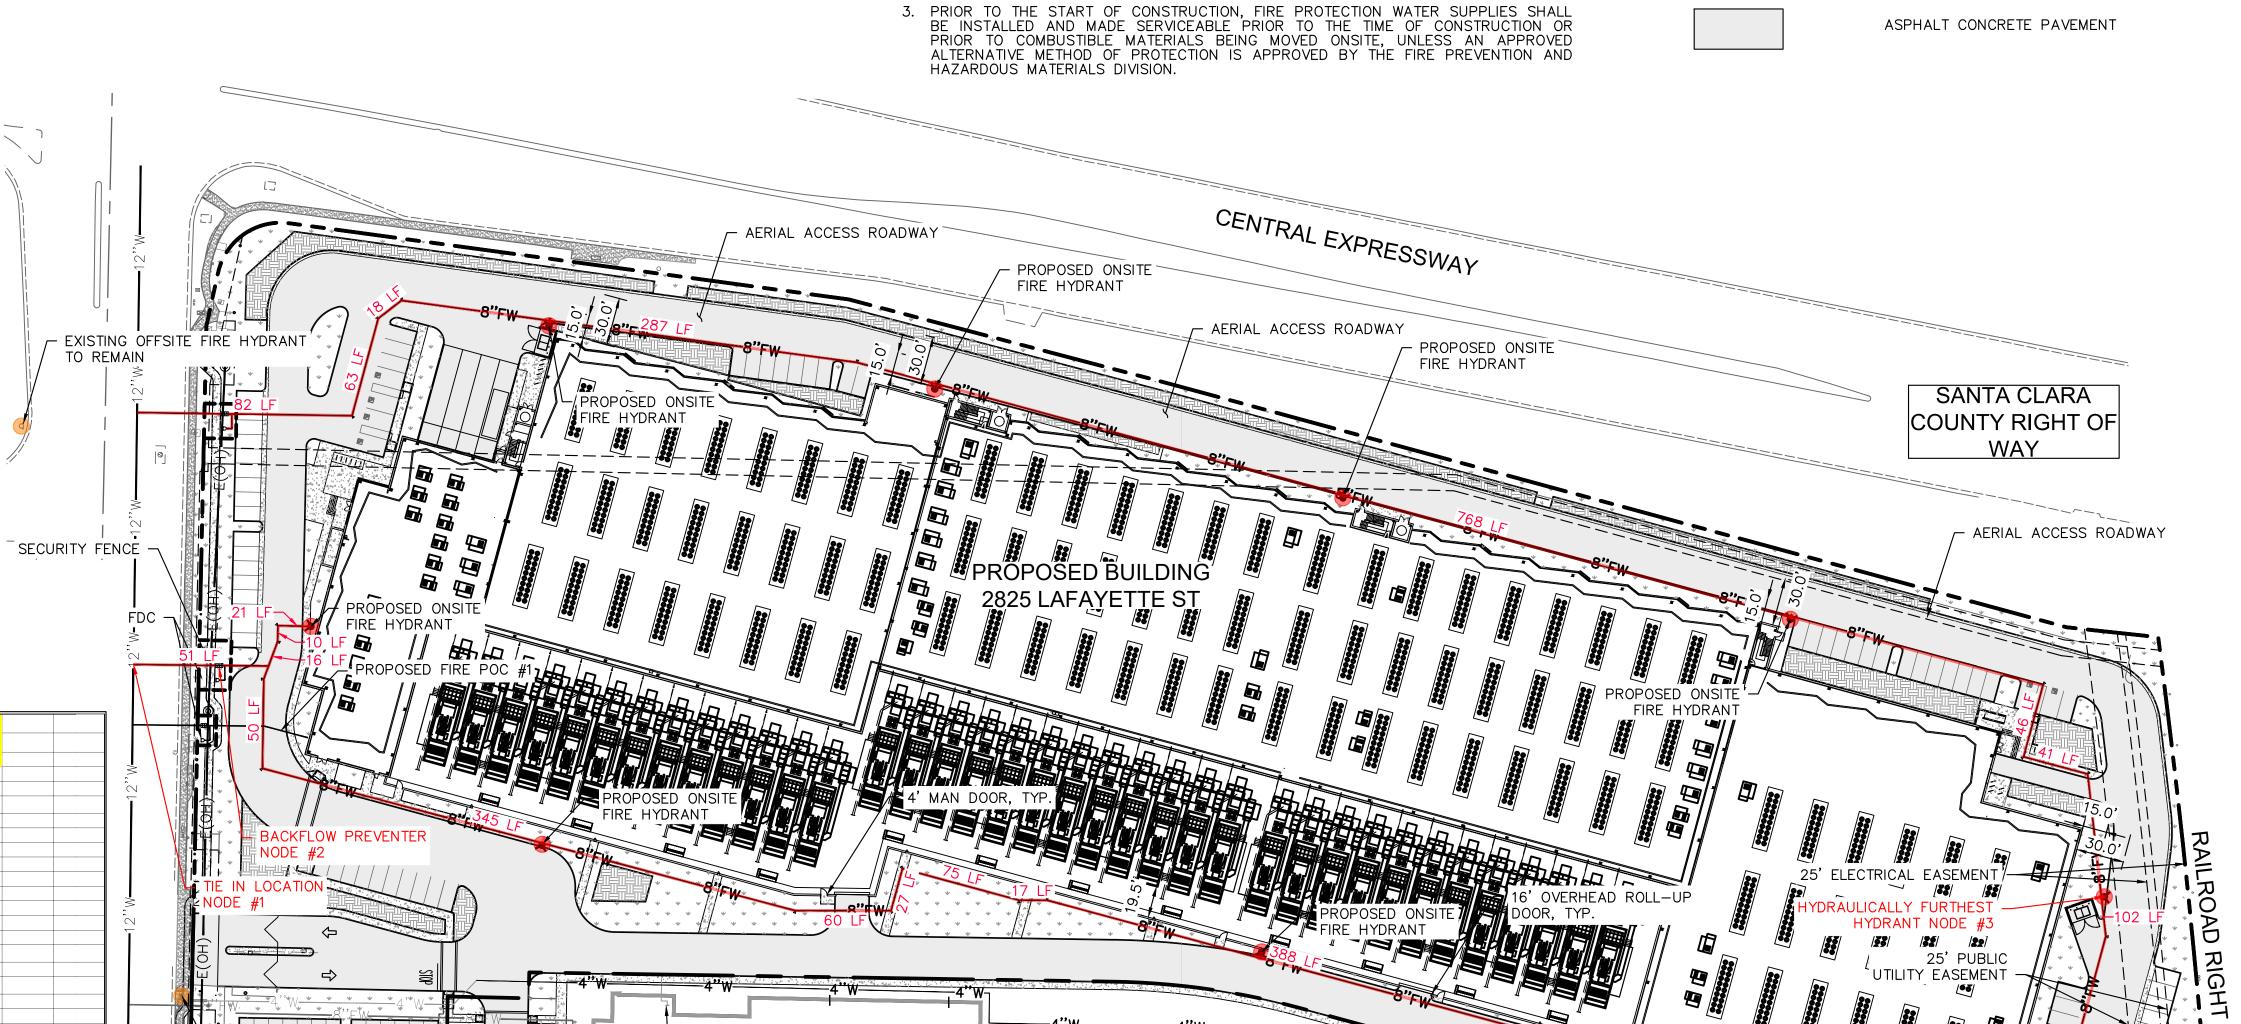

CONTRACTOR SHALL NOTIFY ENGINEER IMMEDIATELY IF ANY DISCREPANCIES ARE

EX. WIR POC #2

EX. WIR POC #3

EXISTING FIRE HYDRANT



PROPERTY LINE

LANDSCAPE/ PLANTER AREA

BIORETENTION AREA

EXISTING WATER LINE

EXISTING FIRE WATER LINE

PROPOSED FIRE HYDRANT

EXISTING FIRE HYDRANT

PROPOSED FIRE WATER LINE (SIZE PER PLAN)

2825 LAFAYETTE STREET SANTA CLARA, CA 95050-2627



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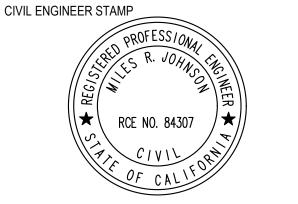
PEOPLES ASSOCIATES

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STRUCTURAL ENGINEER

Kimley » Horn

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NO.	RECORD	DATE

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2825 LAFAYETTE STREET SANTA CLARA, CA, 95050

FIRE DEPARTMENT
WATER SUPPLY
PLAN

PRINCIPAL IN CHARGE PROJECT NUMBER

JP 197250001

PROJECT MANAGER DATE

MJ 07/08/20

PROJECT ENGINEER SHEET NUMBER


KN C2.0


AS SHOWN


K:\BAY_LDEV\197250001 - DLR Data Center (Lafayette St.) - MRJ\CAD\Exhibits\Entitlement Drawings\C2.0 FIRE SUPPLY ASSESSMENT PLAN.dwg 7/8/2020 9:30 PM Kari.Nelson

EXISTING OFFSITE FIRE HYDRANT

TO REMAIN

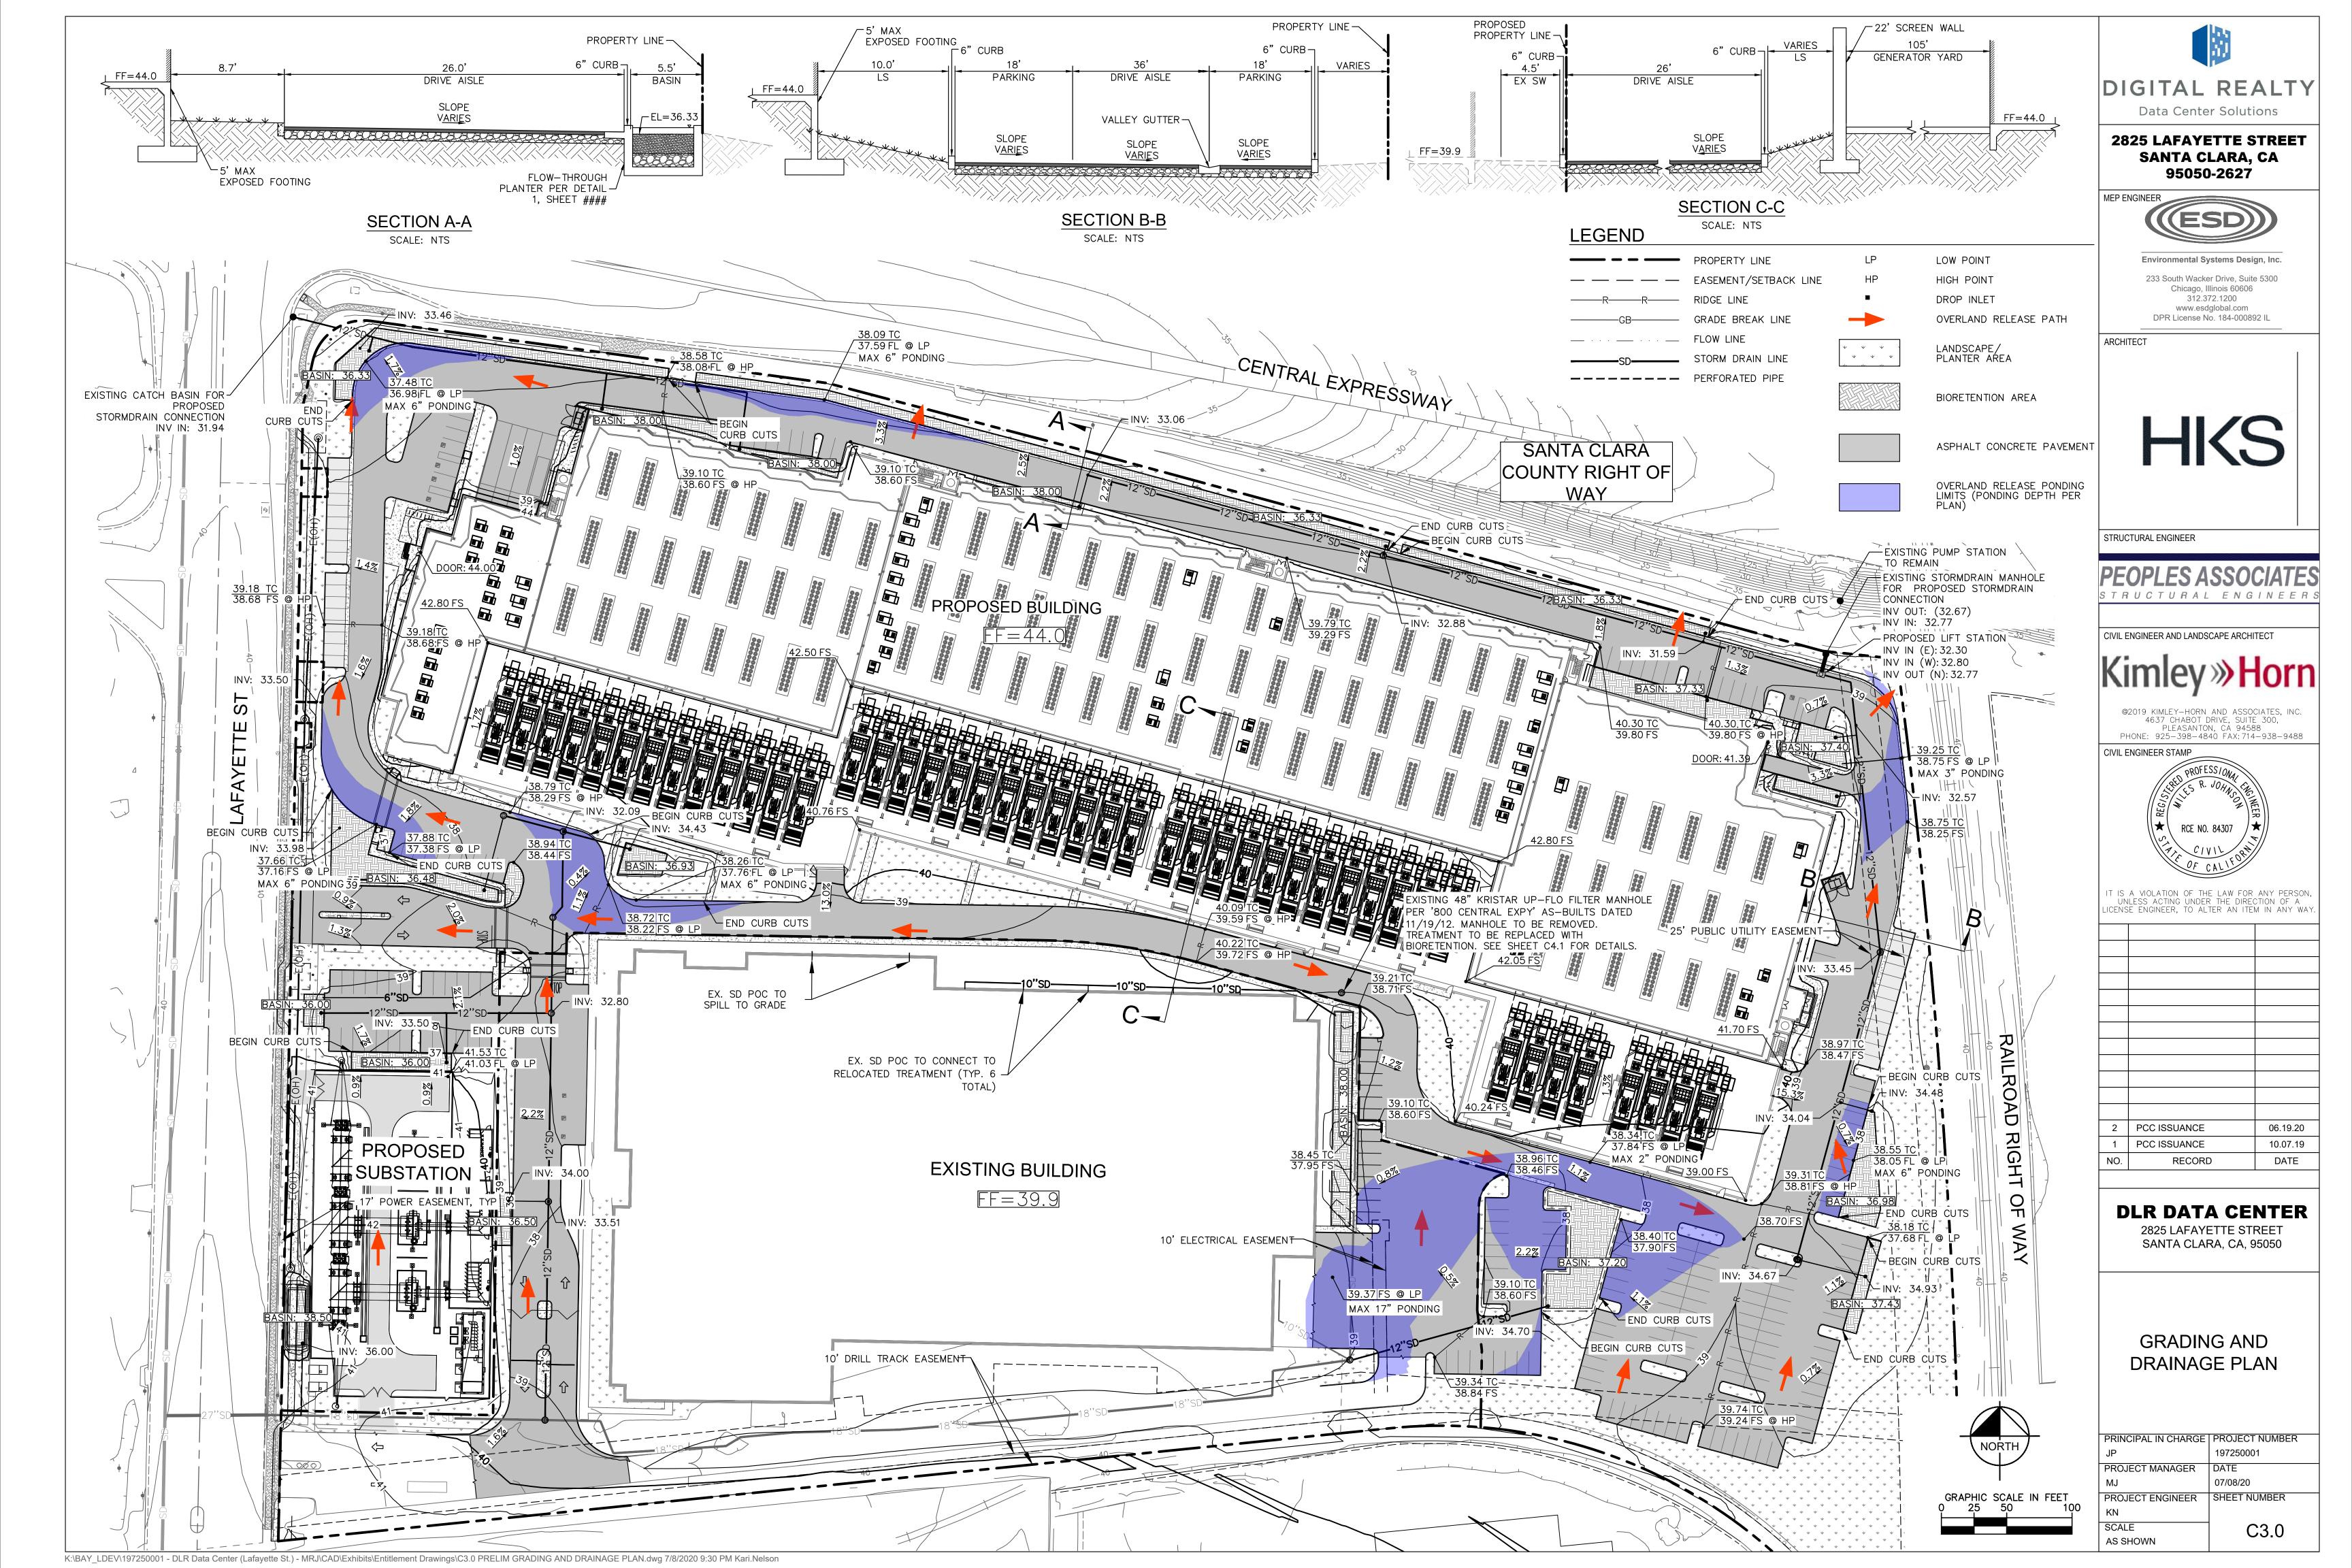

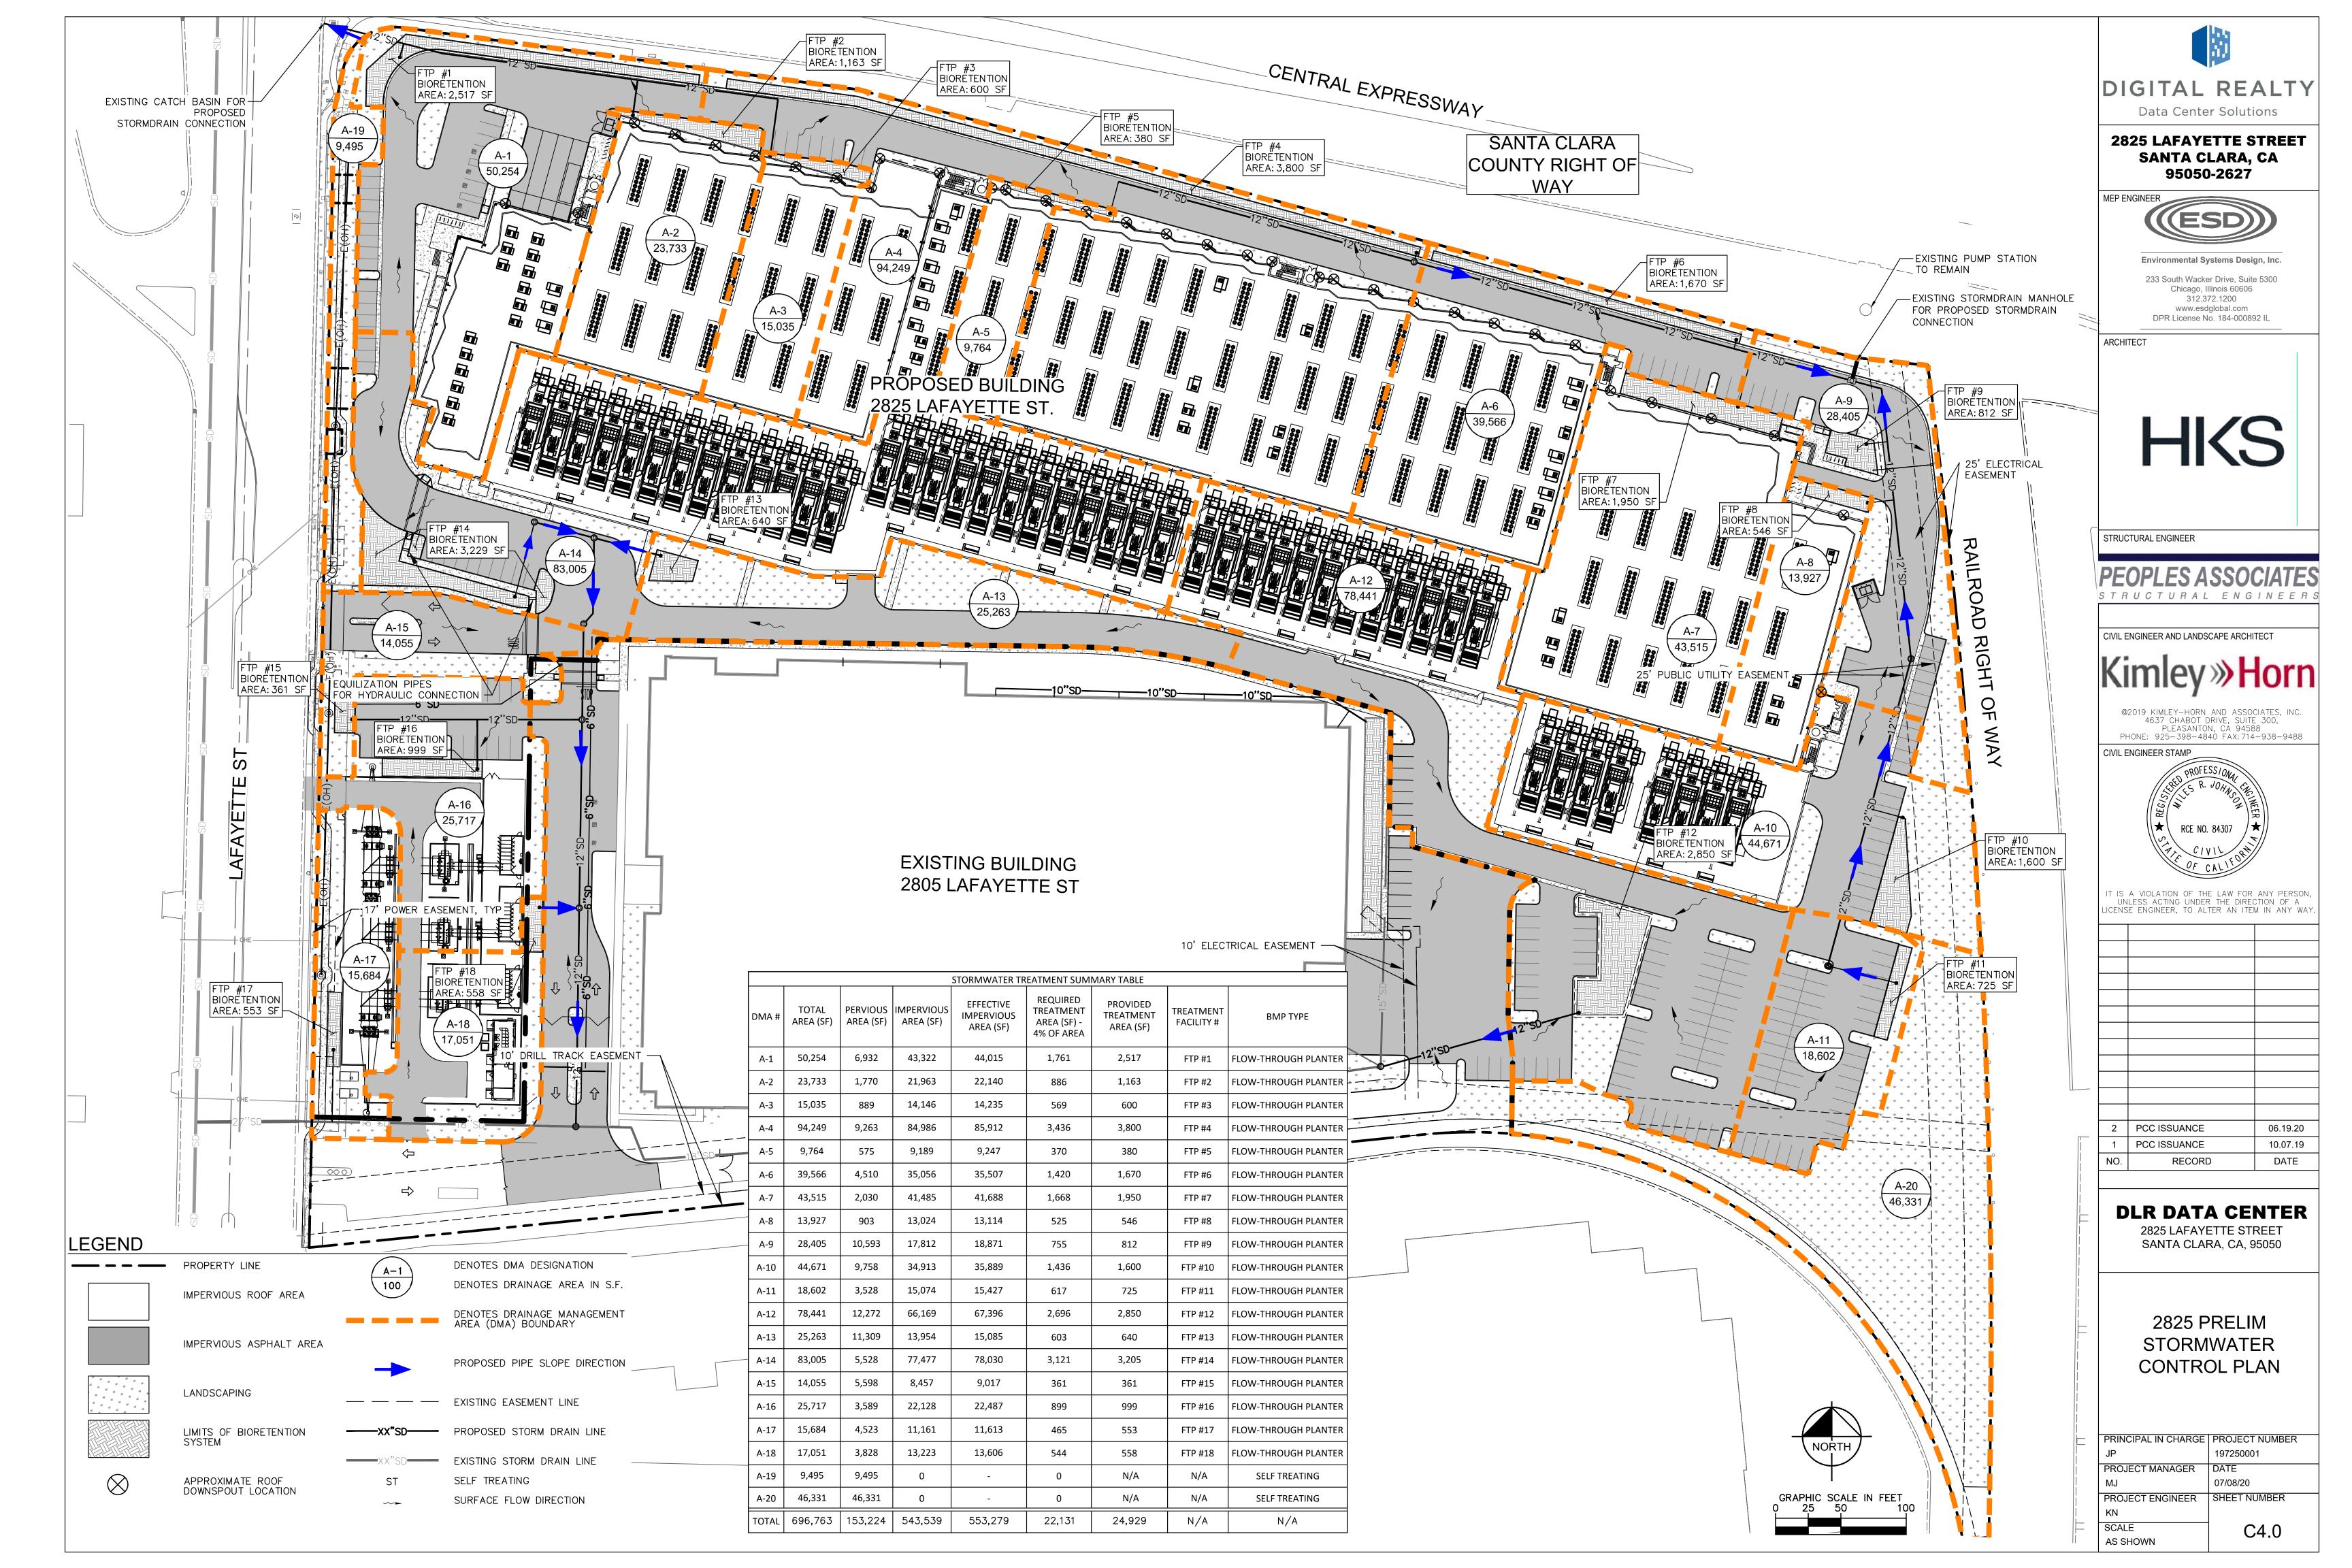

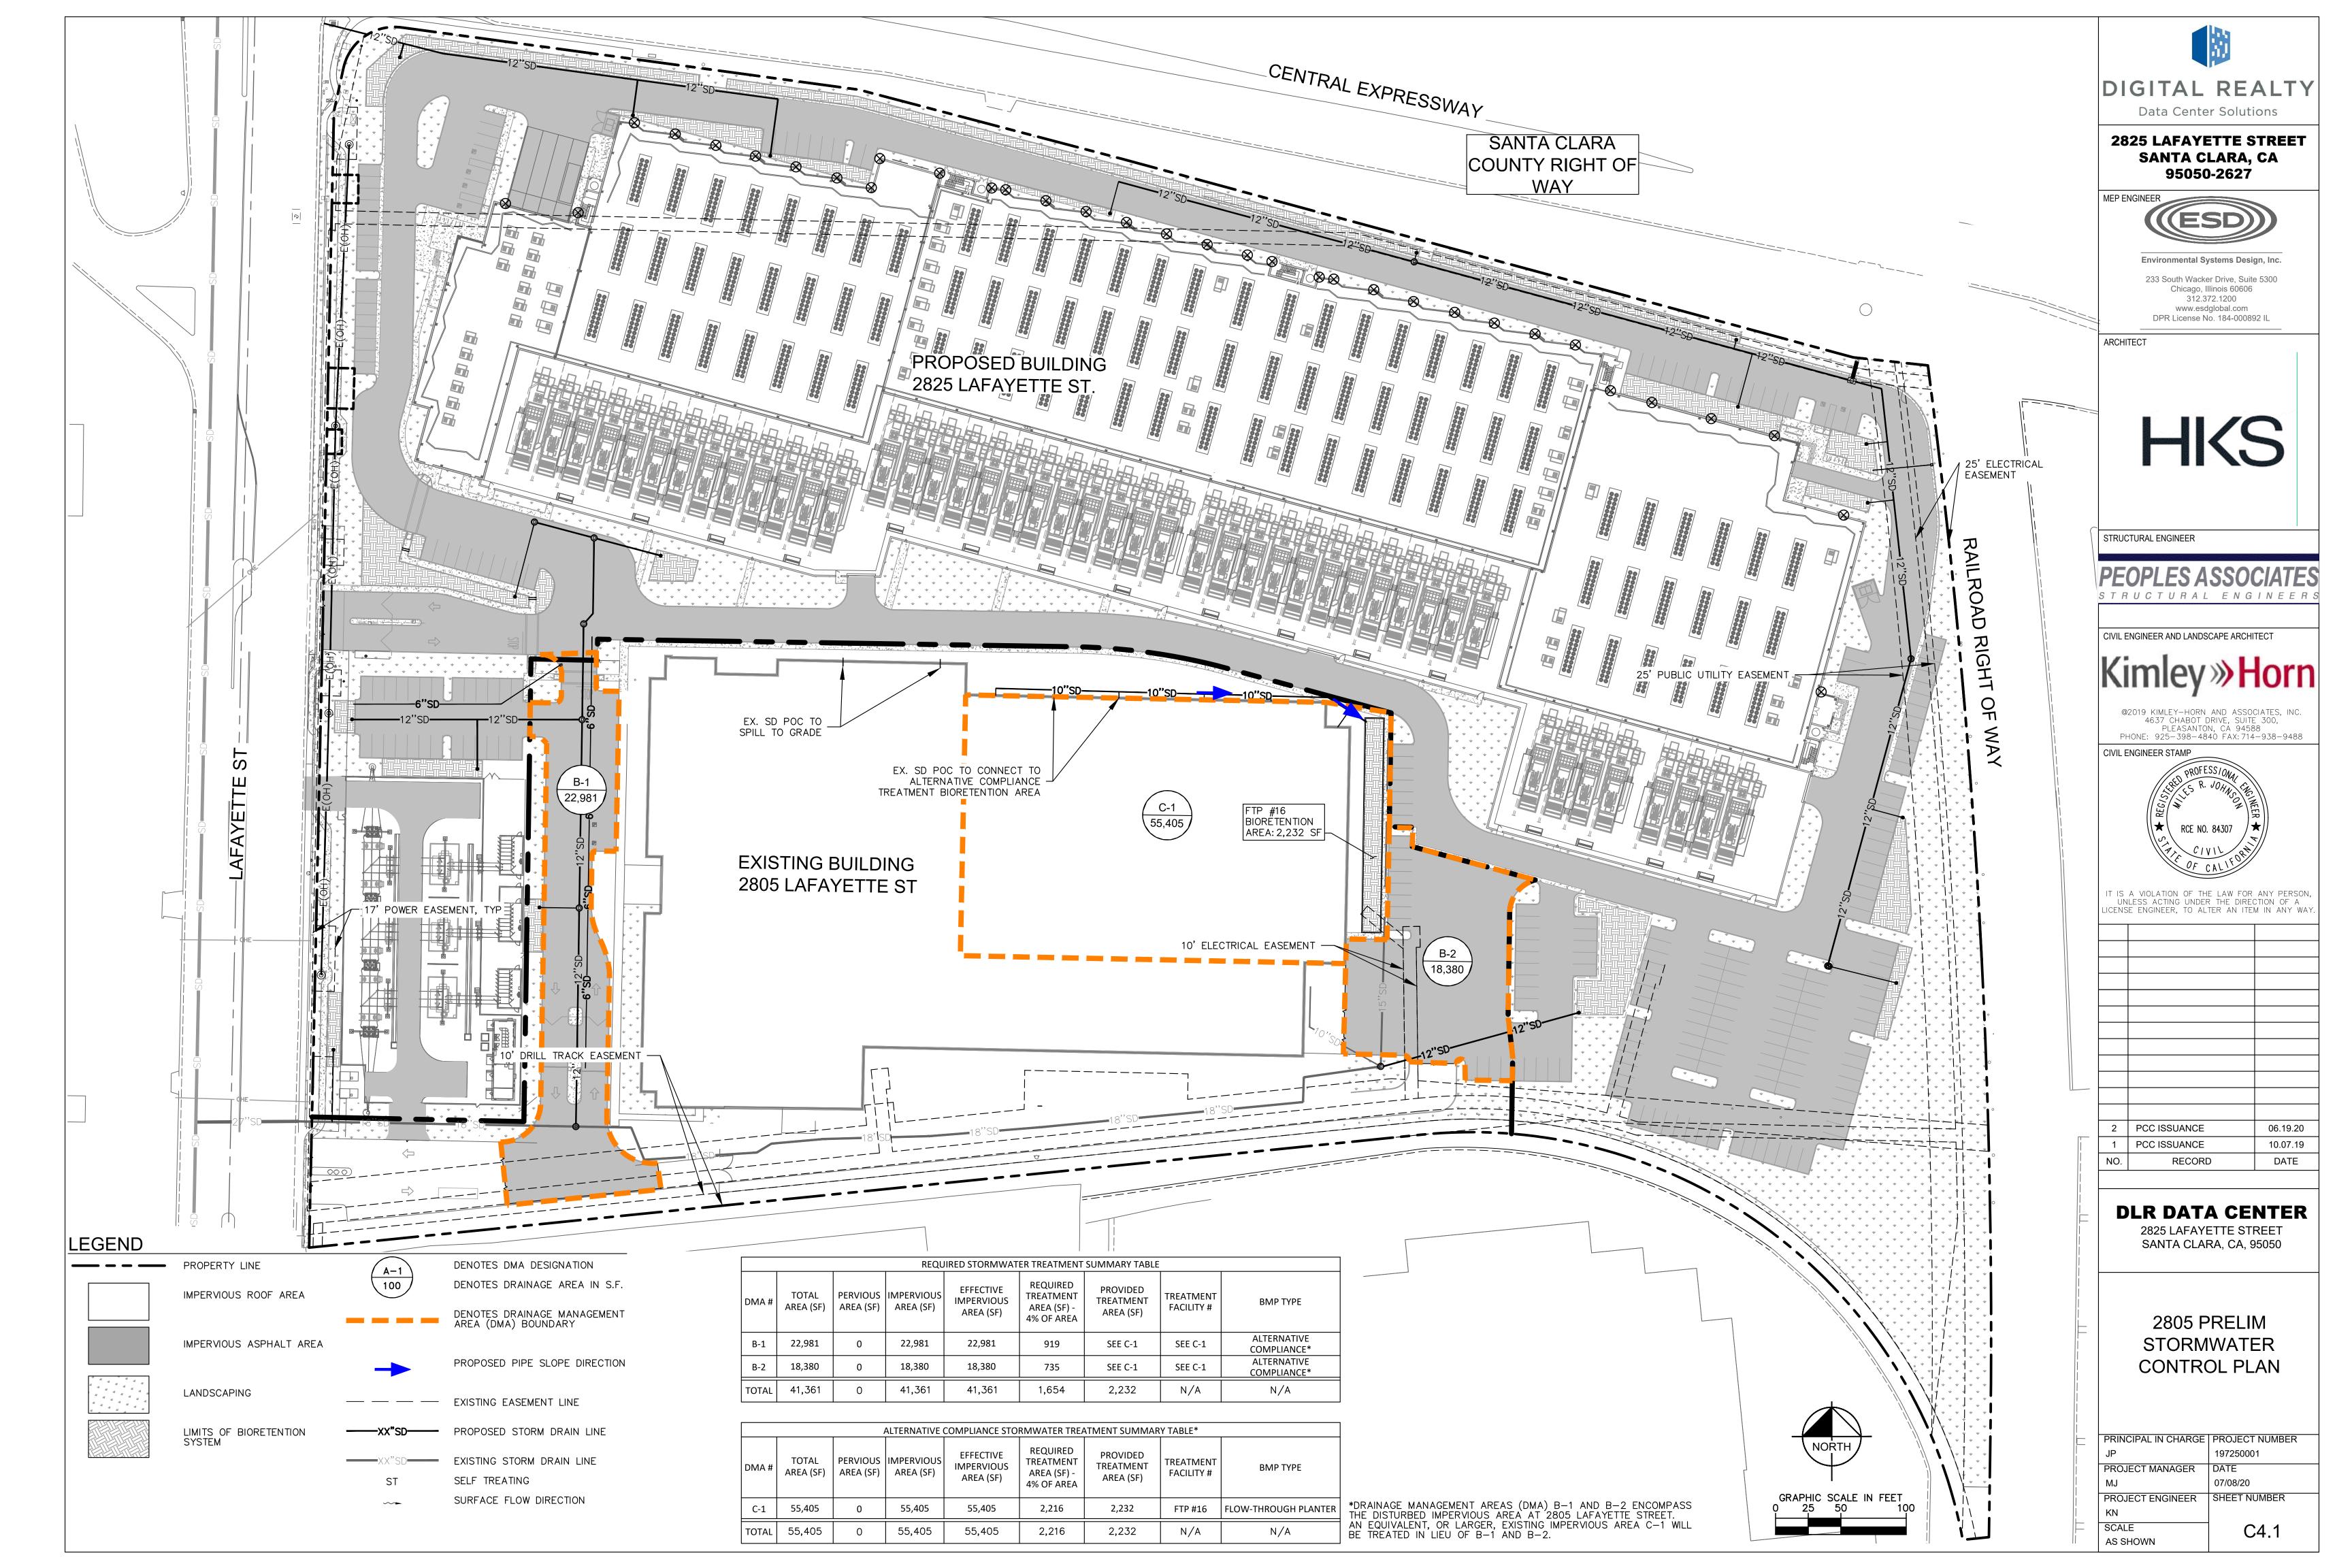

EARTHWORK


CUT: 4,000 CY FILL: 58,000 CY 54,000 CY (FILL)

THE ABOVE QUANTITIES ARE APPROXIMATE IN PLACE VOLUMES CALCULATED FROM THE EXISTING GROUND TO THE PROPOSED FINISHED GRADE. EXISTING GROUND IS DEFINED BY THE CONTOURS AND SPOT GRADES ON THE BASE SURVEY. PROPOSED FINISHED GRADE IS DEFINED AS THE FINAL GRADE AS INDICATED ON THE GRADING PLAN(S).

THE EARTHWORK QUANTITIES ABOVE ARE FOR PERMIT PURPOSES ONLY. THEY HAVE NOT BEEN FACTORED TO ACCOUNT FOR CHANGES IN VOLUME DUE TO BULKING, CLEARING AND GRUBBING, SHRINKAGE, OVER-EXCAVATION AND RE-COMPACTION, AND CONSTRUCTION METHODS. NOR DO THEY ACCOUNT FOR THE THICKNESS OF PAVEMENT SECTIONS, FOOTINGS, SLABS, REUSE OF PULVERIZED MATERIALS THAT WILL UNDERLIE NEW PAVEMENTS, ETC. THE CONTRACTOR SHALL RELY ON THEIR OWN EARTHWORK ESTIMATES FOR BIDDING PURPOSES.

HYDROMODIFICATION APPLICABILITY

PER THE HYDROMODIFICATION MANAGEMENT PLAN (HMP) APPLICABILITY MAP FOR THE CITY OF SANTA CLARA, THIS PROJECT IS IN THE AREA CONSIDERED "CATCHMENTS DRAINING TO HARDENED CHANNEL AND/OR TIDAL AREAS," THEREFORE HM IS NOT REQUIRED FOR THIS PROJECT.

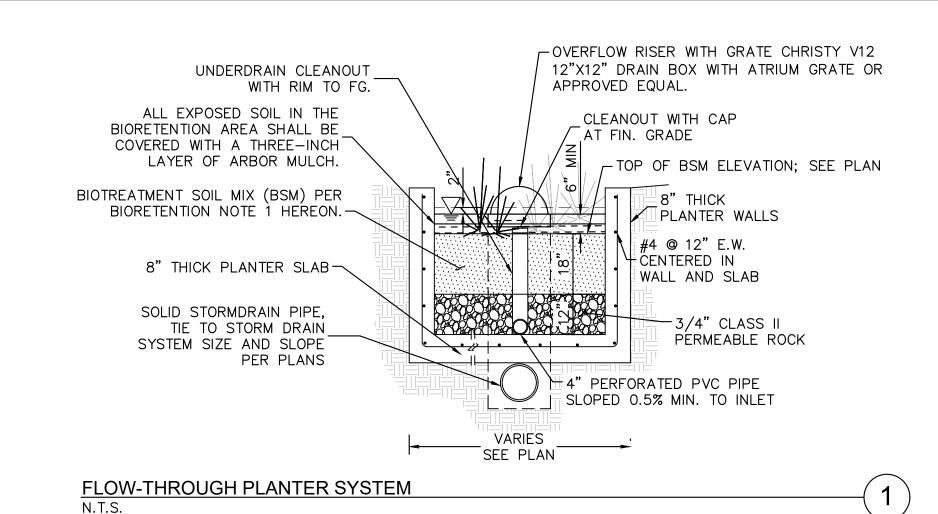

STORMWATER TREATMENT SUMMARY TABLE								
DMA #	TOTAL AREA (SF)	PERVIOUS AREA (SF)	IMPERVIOUS AREA (SF)	EFFECTIVE IMPERVIOUS AREA (SF)	REQUIRED TREATMENT AREA (SF) - 4% OF AREA	PROVIDED TREATMENT AREA (SF)	TREATMENT FACILITY #	ВМР ТҮРЕ
A-1	50,254	6,932	43,322	44,015	1,761	2,517	FTP #1	FLOW-THROUGH PLANTER
A-2	23,733	1,770	21,963	22,140	886	1,163	FTP #2	FLOW-THROUGH PLANTER
A-3	15,035	889	14,146	14,235	569	600	FTP #3	FLOW-THROUGH PLANTER
A-4	94,249	9,263	84,986	85,912	3,436	3,800	FTP #4	FLOW-THROUGH PLANTER
A-5	9,764	575	9,189	9,247	370	380	FTP #5	FLOW-THROUGH PLANTER
A-6	39,566	4,510	35,056	35,507	1,420	1,670	FTP #6	FLOW-THROUGH PLANTER
A-7	43,515	2,030	41,485	41,688	1,668	1,950	FTP #7	FLOW-THROUGH PLANTER
A-8	13,927	903	13,024	13,114	525	546	FTP #8	FLOW-THROUGH PLANTER
A-9	28,405	10,593	17,812	18,871	755	812	FTP #9	FLOW-THROUGH PLANTER
A-10	44,671	9,758	34,913	35,889	1,436	1,600	FTP #10	FLOW-THROUGH PLANTER
A-11	18,602	3,528	15,074	15,427	617	725	FTP #11	FLOW-THROUGH PLANTER
A-12	78,441	12,272	66,169	67,396	2,696	2,850	FTP #12	FLOW-THROUGH PLANTER
A-13	25,263	11,309	13,954	15,085	603	640	FTP #13	FLOW-THROUGH PLANTER
A-14	83,005	5,528	77,477	78,030	3,121	3,205	FTP #14	FLOW-THROUGH PLANTER
A-15	14,055	5,598	8,457	9,017	361	361	FTP #15	FLOW-THROUGH PLANTER
A-16	25,717	3,589	22,128	22,487	899	999	FTP #16	FLOW-THROUGH PLANTER
A-17	15,684	4,523	11,161	11,613	465	553	FTP #17	FLOW-THROUGH PLANTER
A-18	17,051	3,828	13,223	13,606	544	558	FTP #18	FLOW-THROUGH PLANTER
A-19	9,495	9,495	0	-	0	N/A	N/A	SELF TREATING
A-20	46,331	46,331	0	-	0	N/A	N/A	SELF TREATING
TOTAL	696,763	153,224	543,539	553,279	22,131	24,929	N/A	N/A
							•	•

	STORMWATER TREATMENT SUMMARY TABLE							
DMA#	TOTAL AREA (SF)	PERVIOUS AREA (SF)	IMPERVIOUS AREA (SF)	EFFECTIVE IMPERVIOUS AREA (SF)	REQUIRED TREATMENT AREA (SF) - 4% OF AREA	PROVIDED TREATMENT AREA (SF)	TREATMENT FACILITY #	BMP TYPE
B-1	22,981	0	22,981	22,981	919	SEE C-1	SEE C-1	ALTERNATIVE COMPLIANCE
B-2	18,380	0	18,380	18,380	735	SEE C-1	SEE C-1	ALTERNATIVE COMPLIANCE
TOTAL	41,361	0	41,361	41,361	1,654	2,232	N/A	N/A

	STORMWATER TREATMENT SUMMARY TABLE							
DMA#	TOTAL AREA (SF)	PERVIOUS AREA (SF)	IMPERVIOUS AREA (SF)	EFFECTIVE IMPERVIOUS AREA (SF)	REQUIRED TREATMENT AREA (SF) - 4% OF AREA	PROVIDED TREATMENT AREA (SF)	TREATMENT FACILITY #	ВМР ТҮРЕ
C-1	55,405	0	55,405	55,405	2,216	2,232	FTP #16	FLOW-THROUGH PLANTER
TOTAL	55,405	0	55,405	55,405	2,216	2,232	N/A	N/A



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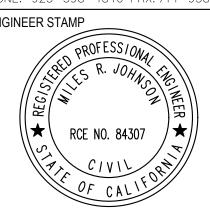


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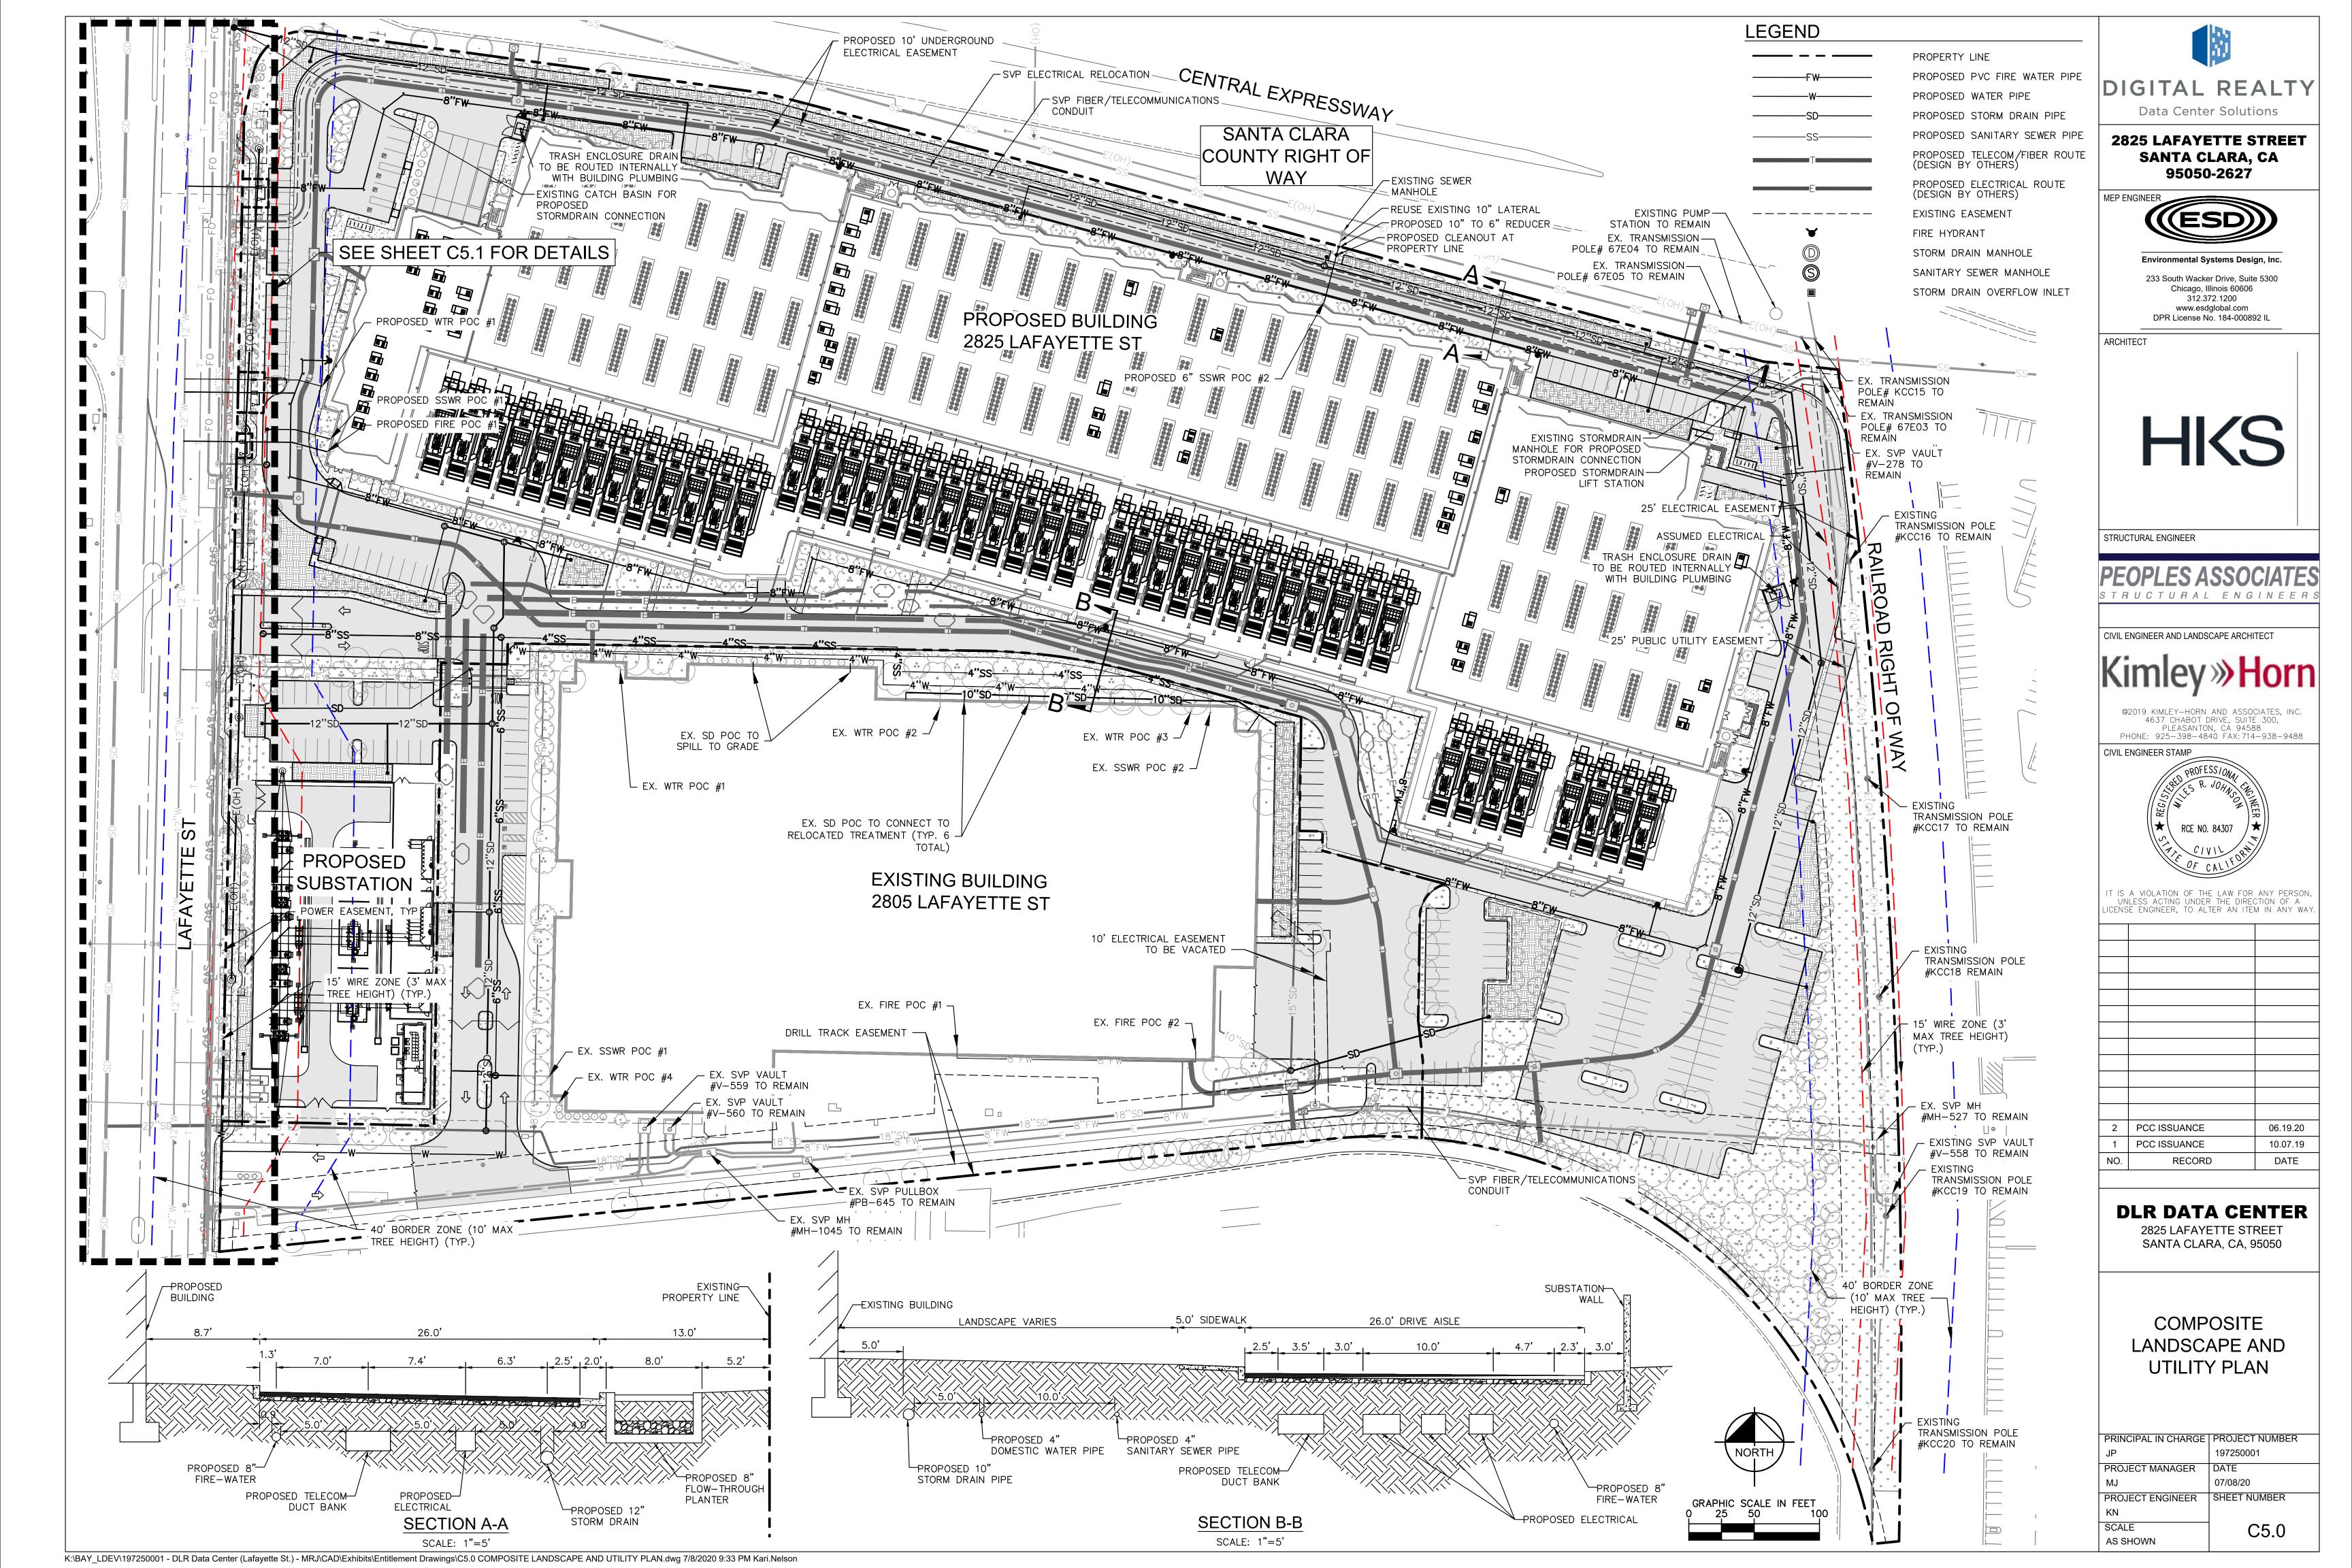
2	PCC ISSUANCE	06.19.20
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NO.	RECORD	DATE


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STORMWATER DETAILS

PRINCIPAL IN CHARGE	PROJECT NUMBER
JP	197250001
PROJECT MANAGER	DATE
MJ	07/08/20
PROJECT ENGINEER	SHEET NUMBER
KN	
SCALE	C4.2
AS SHOWN	J 1.2





GENERAL UTILITY NOTES

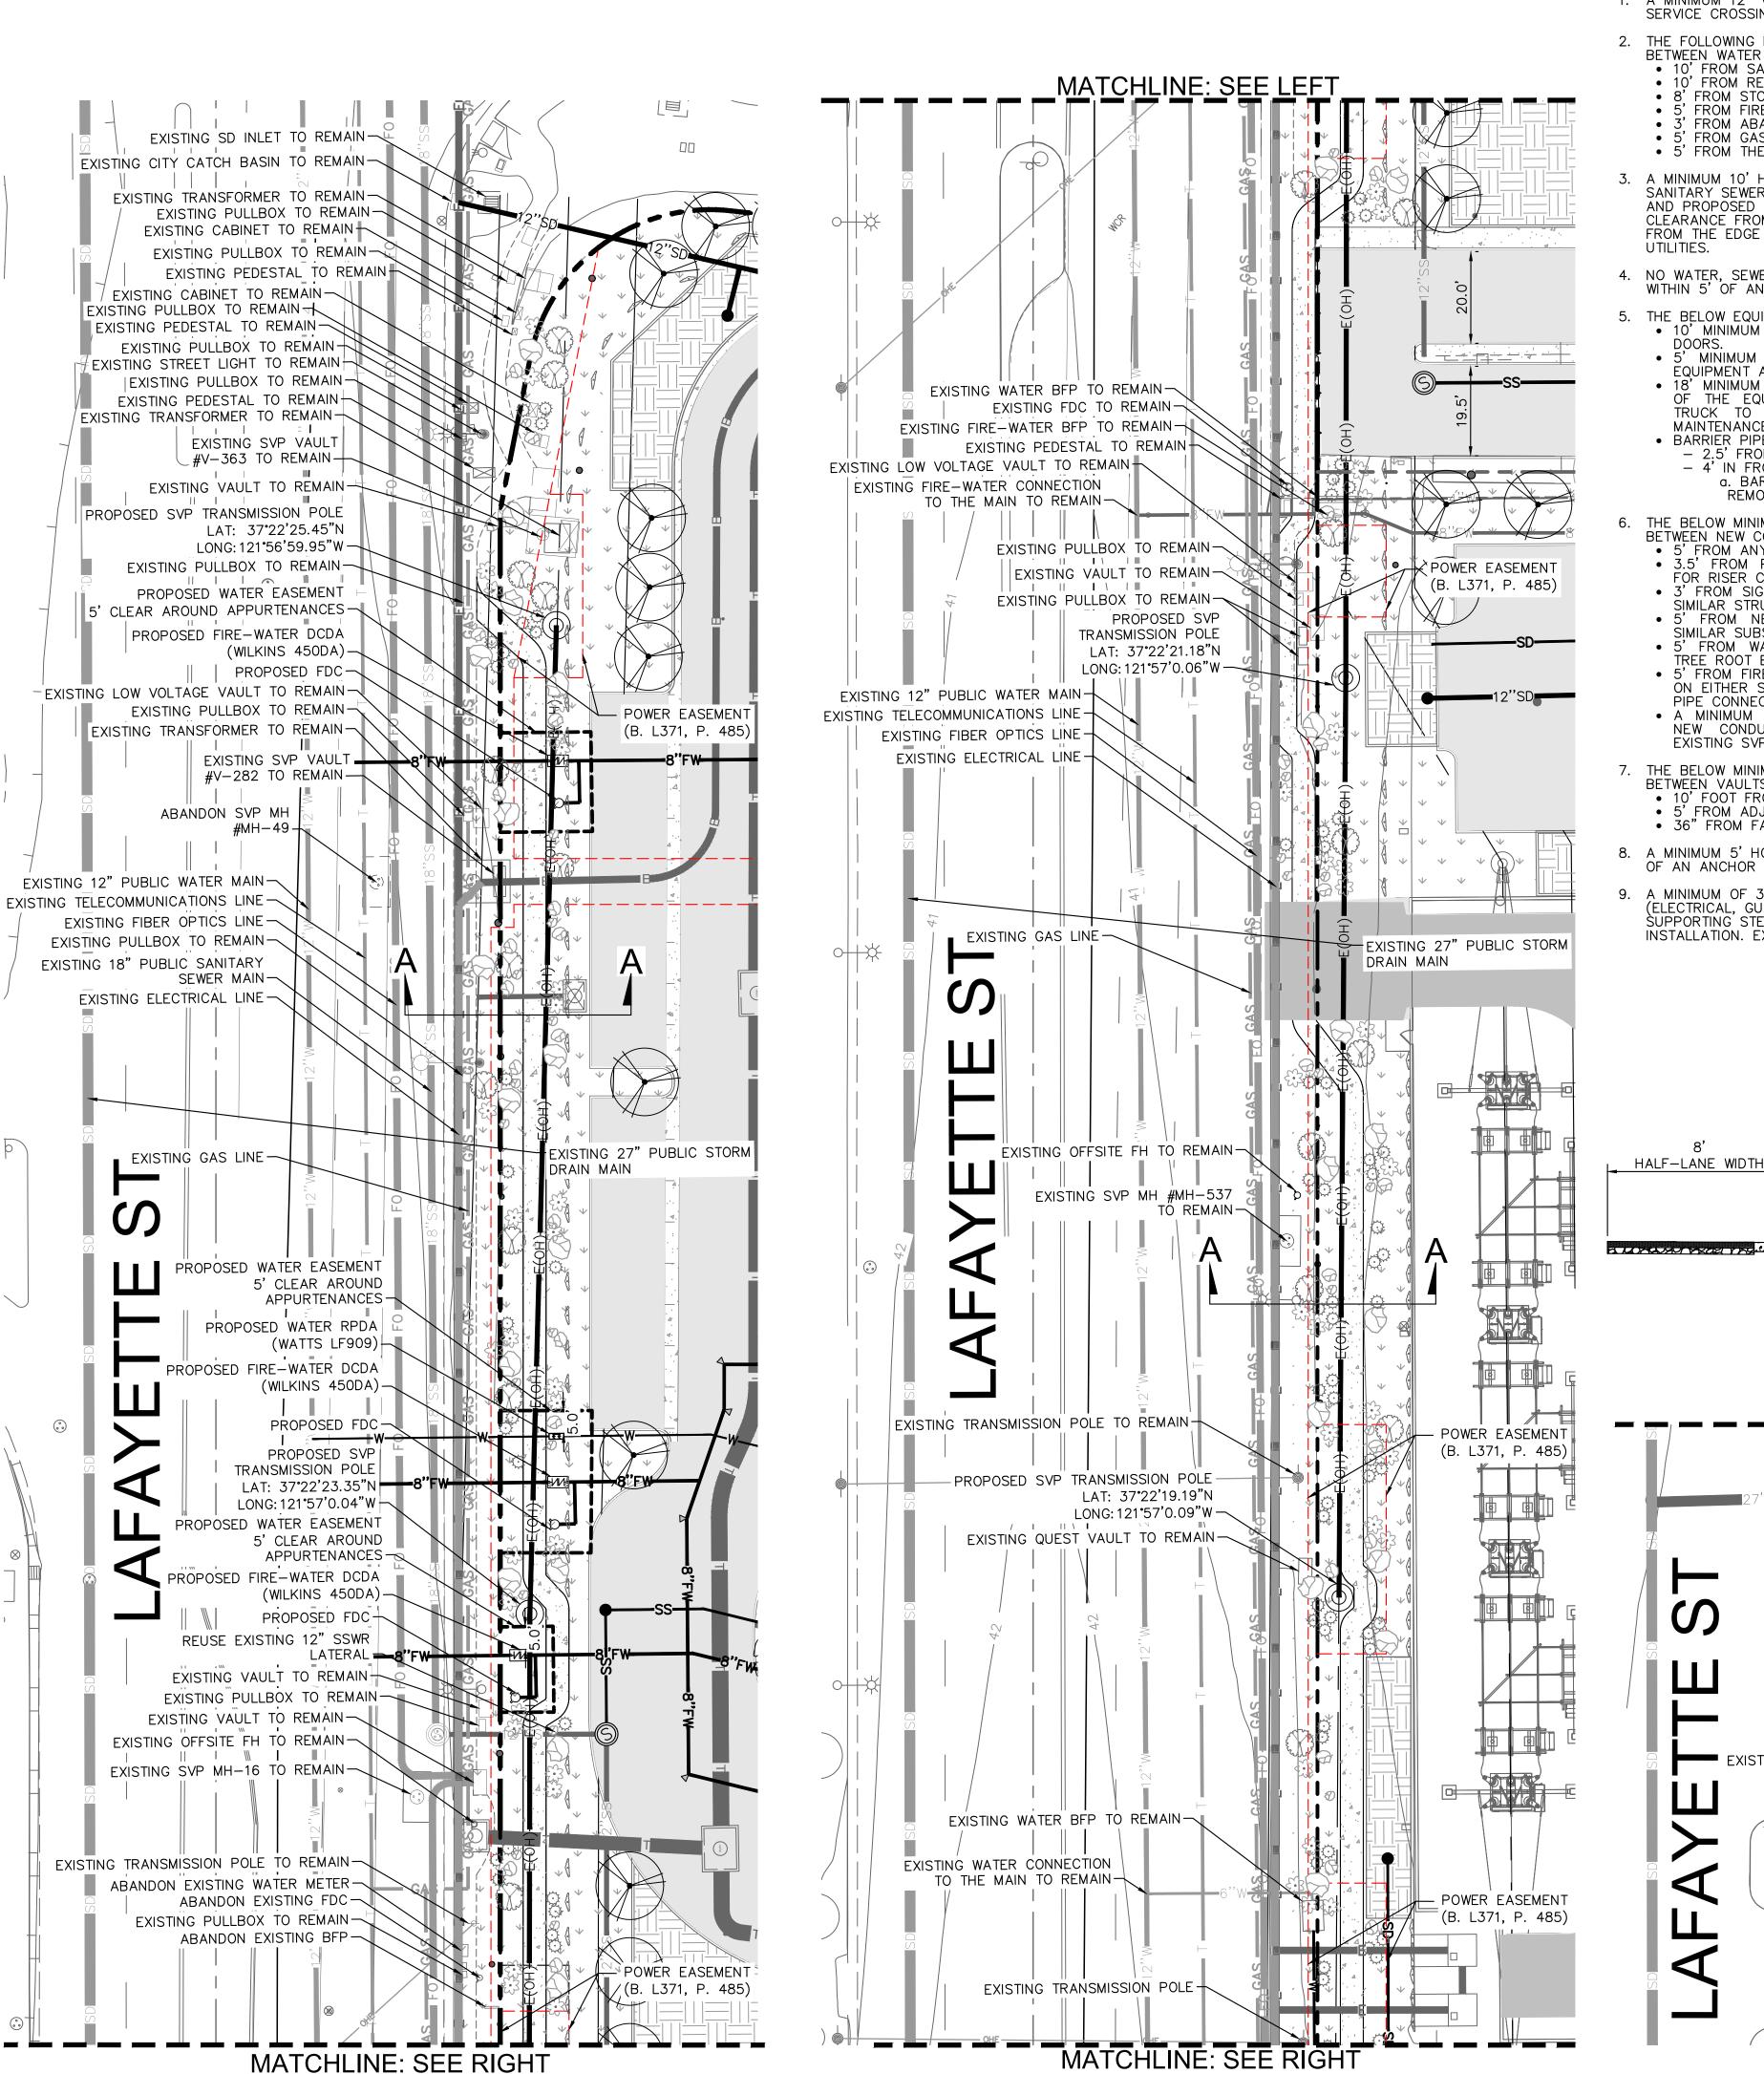- 1. A MINIMUM 12" VERTICAL CLEARANCE MUST BE MAINTAINED AT WATER SERVICE CROSSINGS WITH OTHER UTILITIES.
- 2. THE FOLLOWING MINIMUM HORIZONTAL CLEARANCES MUST BE MAINTAINED
 - BETWEEN WATER SERVICES AND OTHER UTILITIES: • 10' FROM SANITARY SEWER UTILITIES
 - 10' FROM RECYCLED WATER UTILITIES • 8' FROM STORM DRAIN UTILITIES
 - 5' FROM FIRE AND OTHER WATER UTILITIES • 3' FROM ABANDONED WATER SERVICES
 - 5' FROM GAS UTILITIES • 5' FROM THE EDGE OF THE PROPOSED OF EXISTING DRIVEWAY
 - A MINIMUM 10' HORIZONTAL CLEARANCE MUST BE MAINTAINED BETWEEN SANITARY SEWER, WATER AND RECYCLED WATER UTILITIES FROM EXISTING AND PROPOSED TREES. IF TREE ROOT BARRIERS ARE INSTALLED, THE CLEARANCE FROM THE TREE REDUCES TO 5'. THE CLEARANCE MUST BE FROM THE EDGE OF THE TREE ROOT BARRIER TO THE EDGE OF THE NAMED
- NO WATER, SEWER, OR RECYCLED WATER FACILITIES SHALL BE LOCATED WITHIN 5' OF ANY STORM WATER TREATMENT SYSTEM.
- THE BELOW EQUIPMENT CLEARANCES SHALL BE MAINTAINED:
- 10' MINIMUM CLEARANCE IS REQUIRED IN FRONT OF EQUIPMENT ACCESS • 5' MINIMUM CLEARANCE FROM PAD IS REQUIRED ON SIDES WITHOUT EQUIPMENT ACCESS DOORS. 18' MINIMUM WIDTH SHALL BE PROVIDED AND MAINTAINED ON ONE SIDE OF THE EQUIPMENT PAD TO ALLOW AN ELECTRIC DEPARTMENT LINE TRUCK TO DRIVE UP NEXT TO THE PAD FOR INSTALLATION AND
- MAINTENANCE OF EQUIPMENT.
- BARRIER PIPES ARE REQUIRED ONLY ON SIDES ACCESSIBLE TO VEHICLES: 2.5' FROM SIDE OF EQUIPMENT SIDES. - 4' IN FRONT OF ACCESS DOORS. a. BARRIER PIPES IN FRONT OF ACCESS DOORS SHALL BE
- THE BELOW MINIMUM HORIZONTAL CLEARANCES MUST BE MAINTAINED BETWEEN NEW CONDUITS OR PIPING SYSTEMS AND THE FOLLOWING:
- 5' FROM ANY EXISTING OR PROPOSED SVP CONDUIT SYSTEM • 3.5' FROM POLES AND OPEN TRENCH INSTALLATION. EXCEPTIONS ARE FOR RISER CONDUIT • 3' FROM SIGN POSTS, BARRIER PIPES OR BOLLARDS, FENCE POSTS AND
- SIMILAR STRUCTURES • 5' FROM NEW SPLICE BOXES, PULL BOXES, MANHOLES, VAULTS OR SIMILAR SUBSURFACE FACILITIES
- 5' FROM WALLS, FOOTINGS, RETAINING WALLS, LANDSCAPE PLANTERS, TREE ROOT BARRIERS OR OTHER SUBSURFACE WALL OR STRUCTURE
 5' FROM FIRE HYDRANT THRUST BLOCK. THE THRUST BLOCK EXTENDS 5' ON EITHER SIDE OF THE FIRE HYDRANT IN LINE WITH THE RADIAL WATER PIPE CONNECTED TO THE HYDRANT.

 • A MINIMUM 12" VERTICAL CLEARANCE MUST BE MAINTAINED BETWEEN NEW CONDUIT AND PIPE SYSTEMS INSTALLED PERPENDICULAR TO
- EXISTING SVP CONDUITS FOR OPEN TRENCH INSTALLATIONS. THE BELOW MINIMUM HORIZONTAL CLEARANCES MUST BE MAINTAINED BETWEEN VAULTS/MANHOLES AND THE FOLLOWING:
- 10' FOOT FRÓM ADJACENT VAULTS OR MANHOLES • 5' FROM ADJACENT CONDUITS • 36" FROM FACE OF CURB OR BOLLARDS REQUIRED

HALF-LANE WIDTH

- A MINIMUM 5' HORIZONTAL CLEARANCE IS REQUIRED BETWEEN THE CENTER OF AN ANCHOR LINE AND ANY EXCAVATION AREA.
- A MINIMUM OF 3.5' HORIZONTAL CLEARANCE IS REQUIRED FROM POLES (ELECTRICAL, GUY STUB POLES, SERVICE CLEARANCE POLES, SELF SUPPORTING STEEL POLES AND LIGHTING POLES) AND OPEN TRENCH INSTALLATION. EXCEPTIONS ARE FOR RISER CONDUIT.

PROPERTY LINE -

15' LANDSCAPE

BUFFER (VARIES)

SECTION A-A

SCALE: NTS

LOCATIONS VARY ALONG LAFAYETTE STREET

MATCHLINE: SEE LEFT

EXISTING ELECTRICAL

VOLTAGE VAULT TO REMAIN

EXISTING PULLBOX TO REMAIN-

EXISTING PULLBOX TO REMAIN-

EXISTING SVP VAULT #V-283 TO REMAIN →

EXISTING TRANSFORMER TO REMAIN-

CABINET TO REMAIN

EXISTING LOW

- 10. EXISTING SVP VAULTS AND CONDUIT ARE SHOWN PER CITY OF SANTA CLARA ELECTRICAL UNDERGROUND MAP DRAWING UG75. EXACT AS BUILT LOCATIONS TO BE FIELD VERIFIED BY THE CONTRACTOR AT THE TIME OF CONSTRUCTION.
- 11. THE PROPERTY SHALL BE FENCED OFF DURING DEMOLITION AND CONSTRUCTION.
- 12. TREES MUST MEET THE CLEARANCE REQUIREMENTS LISTED IN SVP STANDARDS OH 1230 FOR OVERHEAD LINES AND SD 1235 FOR TREE PLANTING REQUIREMENTS NEAR UG ELECTRIC FACILITIES.
- 13. CONTRACTOR TO CONDUCT CCTV SCAN OF EXISTING SANITARY SEWER LATERAL TO CONFIRM EXISTING LATERAL IS IN GOOD CONDITION FOR REUSE. LATERAL TO BE REPLACED IF DETERMINED TO NOT BE IN GOOD CONDITION.
- 14. PLANS SHALL CONFORM TO THE FOLLOWING SVP STANDARDS: a. INSTALLATION OF UNDERGROUND SUBSTRUCTURES BY DEVELOPERS b. UG1250 - ENCROACHMENT PERMIT CLEARANCES FROM ELECTRIC FACILITIES
- . UG0339 REMOTE SWITCH PAD d. OH1230 - TREE CLEARANCES FROM OVERHEAD ELECTRIC LINES e. SD1235 - TREE PLANTING REQUIREMENTS NEAR UNDERGROUND ELECTRIC
- 15. CONTRACTOR TO VERIFY THE DISPOSITION OF ALL EXISTING LATERALS FOR REUSE. CONTRACTOR TO NOTIFY THE ENGINEER IF ANY LATERAL IS DEEMED TO BE IN POOR CONDITION. IN THIS CASE, CONTRACTOR TO ABANDON

SERVICE TO THE MAIN PER SEWER AND WATER UTILITY STANDARDS.

LEGEND


XX"S

10' LANDSCAPE

SIDEWALK

FO FO

——— GAS ———

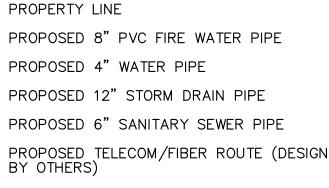

PROPOSED ELECTRICAL ROUTE (DESIGN BY

EXISTING WATER PIPE EXISTING STORM DRAIN PIPE EXISTING SANITARY SEWER PIPE EXISTING TELECOM/FIBER ROUTE EXISTING ELECTRICAL ROUTE EXISTING FIBER OPTICS ROUTE EXISTING GAS PIPE EXISTING EASEMENT FIRE HYDRANT STORM DRAIN MANHOLE

SANITARY SEWER MANHOLE STORM DRAIN OVERFLOW INLET

EXISTING TREE/TO BE REMOVED

EXISTING TREE/TO REMAIN PROTECT IN PLACE

PROPOSED TREE



DIGITAL REALTY

Data Center Solutions

2825 LAFAYETTE STREET

SANTA CLARA, CA

Environmental Systems Design, Inc. 233 South Wacker Drive, Suite 5300

Chicago, Illinois 60606

312.372.1200

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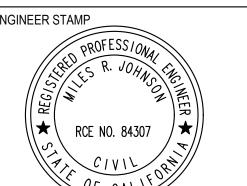
PEOPLES ASSOCIATES

STRUCTURAL ENGINEER

CIVIL ENGINEER AND LANDSCAPE ARCHITECT

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PHONE: 925-398-4840 FAX: 714-938-9488 **CIVIL ENGINEER STAMP**



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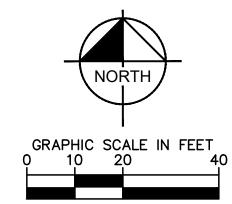
DLR DATA CENTER

2825 LAFAYETTE STREET SANTA CLARA, CA, 95050


LAFAYETTE ST FRONTAGE PLAN

PRINCIPAL IN CHARGE | PROJECT NUMBER 197250001 PROJECT MANAGER 07/08/20 PROJECT ENGINEER SHEET NUMBER SCALE C5.1

AS SHOWN



K:\BAY LDEV\197250001 - DLR Data Center (Lafayette St.) - MRJ\CAD\Exhibits\Entitlement Drawings\C5.1 FRONTAGE ROAD PLAN.dwg 7/8/2020 9:34 PM Kari.Nelson

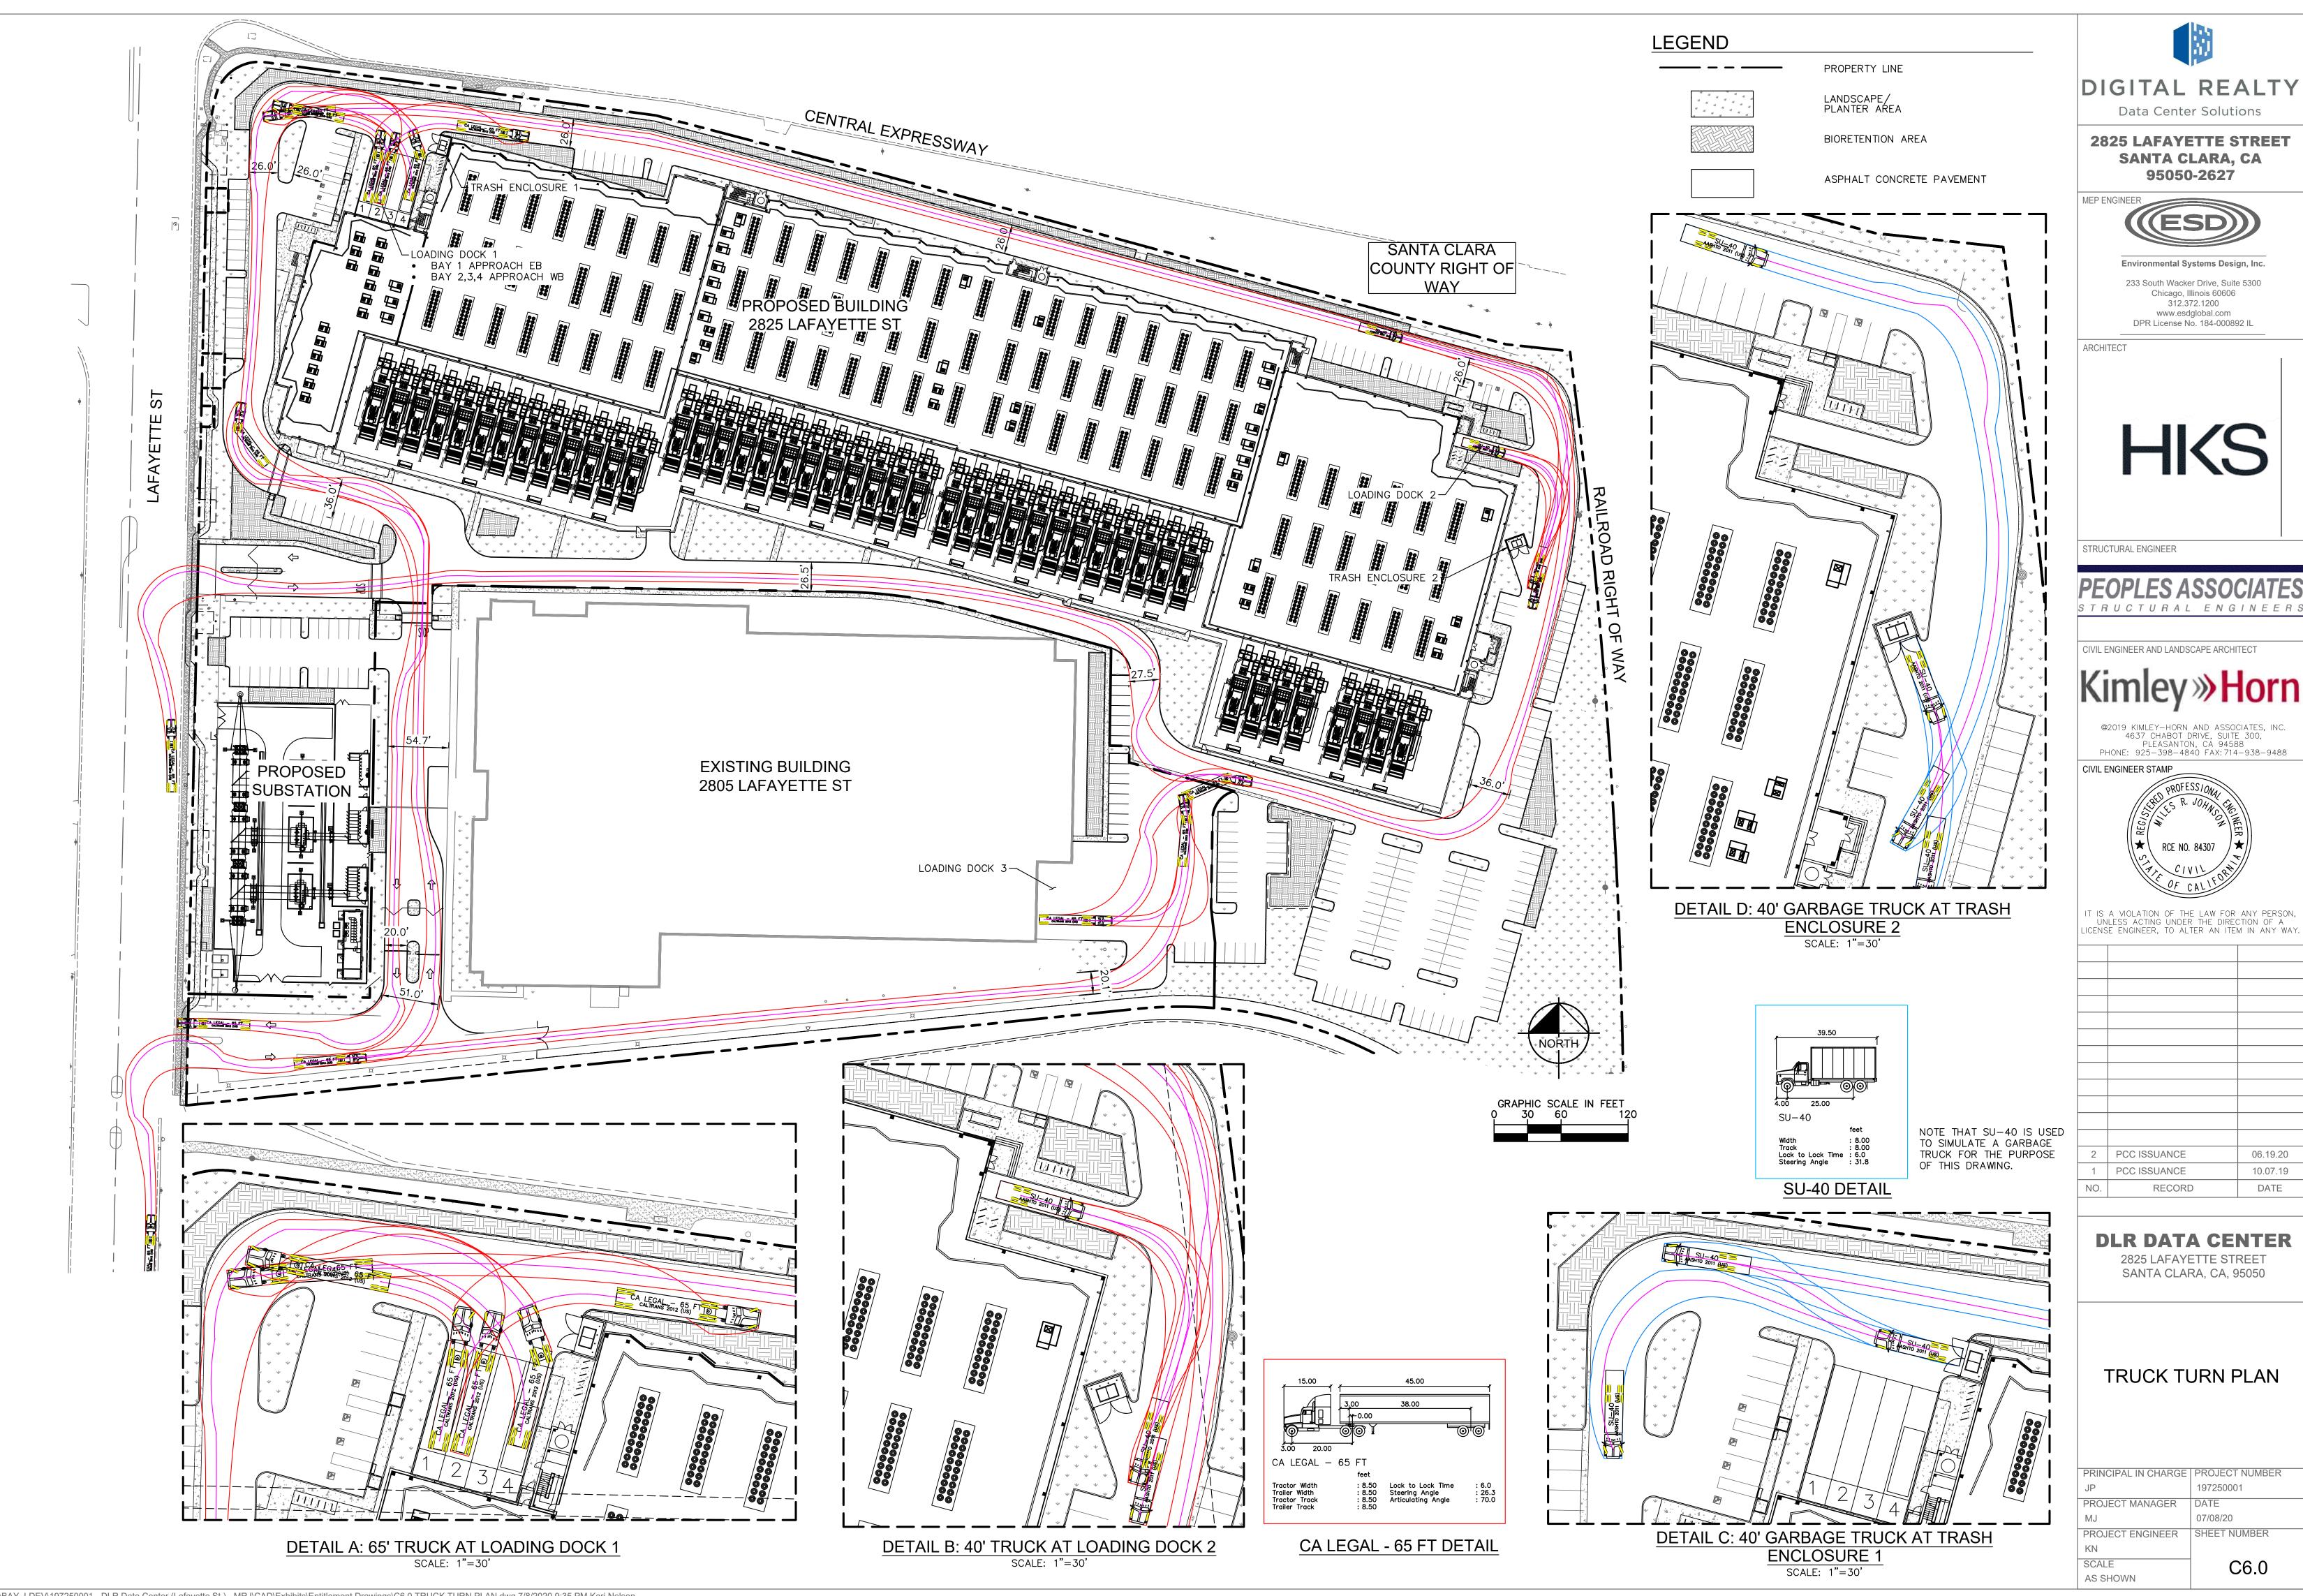

K:\BAY_LDEV\197250001 - DLR Data Center (Lafayette St.) - MRJ\CAD\Exhibits\Entitlement Drawings\C6.0 TRUCK TURN PLAN.dwg 7/8/2020 9:35 PM Kari.Nelson