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resources & energy

DOCKET

09-AFC-8

DATE FEB 02 2010

RECD. FEB 04 2010

Letter of Transmittal

Date: February 1, 2010

To: California Energy Commission
Attention: Docket No. 09-AFC-8
1516 Ninth Street, MS-4
Sacramento, CA 95814-5512

From: Michele Scott
WorleyParsons
2330 East Bidwell, Suite 150
Folsom, CA 95630
(916) 817-3940

Dear Sir or Madam,

Pursuant to the provisions of Title 20, California Code of Regulation, WorleyParsons, consultant to Genesis Solar, LLC, hereby submits the Genesis Solar Energy Project Draft Channel Maintenance Plan. The Genesis Solar Energy Project is a 250 megawatt solar electric generating facility to be located between the community of Desert Center and the city of Blythe in eastern Riverside County, California.

This report is submitted as a supplementary report and accompanying data to the Genesis Solar Energy Project Application for Certification and Genesis Solar Energy Project Application for Certification Data Requests, Sets 1A and 1B. A hard copy and electronic copy (CD) are included herein.

Please feel free to contact me with any questions or concerns at (916) 817-3940.

Sincerely,

WorleyParsons

Michele Scott
Senior Compliance Manager



**BEFORE THE ENERGY RESOURCES CONSERVATION AND DEVELOPMENT
COMMISSION OF THE STATE OF CALIFORNIA
1516 NINTH STREET, SACRAMENTO, CA 95814
1-800-822-6228 – WWW.ENERGY.CA.GOV**

**APPLICATION FOR CERTIFICATION FOR THE
*GENESIS SOLAR ENERGY PROJECT***

Docket No. 09-AFC-8

**PROOF OF SERVICE
(Revised 1/04/10)**

APPLICANT

Ryan O’Keefe, Vice President
Genesis Solar LLC
700 Universe Boulevard
Juno Beach, Florida 33408
Ryan.okeefe@nexteraenergy.com

Scott Busa/Project Director
Meg Russel/Project Manager
Duane McCloud/Lead Engineer
NextEra Energy
700 Universe Boulevard
Juno Beach, FL 33408
Scott.Busa@nexteraenergy.com
Meg.Russell@nexteraenergy.com
Duane.mccloud@nexteraenergy.com

Mike Pappalardo
Permitting Manager
3368 Videra Drive
Eugene, OR 97405
mike.pappalardo@nexteraenergy.com

Diane Fellman/Director
West Region
Regulatory Affairs
234 Van Ness Avenue
San Francisco, CA 94102
Diane.fellman@nexteraenergy.com

APPLICANT’S CONSULTANTS

Tricia Bernhardt/Project Manager
Tetra Tech, EC
143 Union Boulevard, Ste 1010
Lakewood, CO 80228
Tricia.bernhardt@tteci.com

Christo Nitoff, Project Engineer
Worley Parsons
2330 East Bidwell Street, Ste.150
Folsom, CA 95630
Christo.Nitoff@Worleyparsons.com

COUNSEL FOR APPLICANT

Scott Galati
Galati & Blek, LLP
455 Capitol Mall, Ste. 350
Sacramento, CA 95814
sgalati@gb-llp.com

INTERESTED AGENCIES

California-ISO
e-recipient@caiso.com
Allison Shaffer, Project Manager
Bureau of Land Management
Palm Springs South Coast
Field Office
1201 Bird Center Drive
Palm Springs, CA 92262
Allison_Shaffer@blm.gov

INTERVENORS

Tanya A. Gulesserian,**Loulena*
A. Miles, Marc D. Joseph
Adams Broadwell Joesph &
Cardoza
601 Gateway Boulevard,
Ste 1000
South San Francisco, CA 94080
tgulesserian@adamsbroadwell.com
lmiles@adamsbroadwell.com

Michael E. Boyd, President
Californians for Renewable
Energy, Inc. (CARE)
5439 Soquel Drive
Soquel, CA 95073-2659
michaelboyd@sbcglobal.net

Other

Alfredo Figueroa
424 North Carlton
Blythe, CA 92225
LaCunaDeAtzlan@aol.com

ENERGY COMMISSION

JULIA LEVIN
Commissioner and Presiding
Member
jlevin@energy.state.ca.us

JAMES D. BOYD
Vice Chair and Presiding Member
jboyd@energy.state.ca.us

Kenneth Celli
Hearing Officer
kcelli@energy.state.ca.us

Mike Monasmith
Siting Project Manager
mmonasmi@energy.state.ca.us

Caryn Holmes
Staff Counsel
cholmes@energy.state.ca.us

Robin Mayer
Staff Counsel
rmayer@energy.state.ca.us

Public Adviser’s Office
publicadviser@energy.state.ca.us

*indicates change

DECLARATION OF SERVICE

I, Michele Scott, declare that on February 1, 2010, I served and filed copies of the attached Genesis Solar Energy Project Draft Channel Maintenance Plan, dated January, 2010. This document is being submitted by the applicant, Genesis Solar LLC. The original document, filed with the Docket Unit, is accompanied by a copy of the most recent Proof of Service list, located on the web page for this project at: [http://www.energy.ca.gov/sitingcases/genesis_solar].

The documents have been sent to both the other parties in this proceeding (as shown on the Proof of Service list) and to the Commission's Docket Unit, in the following manner:

(Check all that Apply)

FOR SERVICE TO ALL OTHER PARTIES:

sent electronically to all email addresses on the Proof of Service list;

by personal delivery or by depositing in the United States mail at Sacramento, California with first-class postage thereon fully prepaid and addressed as provided on the Proof of Service list above to those addresses **NOT** marked "email preferred."

AND

FOR FILING WITH THE ENERGY COMMISSION:

sending an original paper copy and one electronic copy, mailed and emailed respectively, to the address below (*preferred method*);

OR

depositing in the mail an original and 8 paper copies, as follows:

CALIFORNIA ENERGY COMMISSION

Attn: Docket No. 09-AFC-8
1516 Ninth Street, MS-4
Sacramento, CA 95814-5512
docket@energy.state.ca.us

I declare under penalty of perjury that the foregoing is true and correct.

Original Signed By:
Michele Scott

GENESIS SOLAR ENERGY PROJECT

DRAFT CHANNEL MAINTENANCE PLAN

Submitted to:

California Energy Commission

Submitted by:

Genesis Solar, LLC

With technical assistance from:

WorleyParsons Group, Inc.

January 2010

DRAFT CHANNEL MAINTENANCE PLAN
GENESIS SOLAR ENERGY PROJECT

Prepared By:

Janine Forrest Date

Reviewed By:

Bob Anders, California Registered Professional Engineer, as an employee of WorleyParsons, with expertise in hydrology, has reviewed the report with the title “Draft Channel Maintenance Plan”.

Bob Anders, PE, Date

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1. INTRODUCTION

This report presents a Draft Channel Maintenance Plan for the proposed Genesis Solar Energy Project (“Project”), located in the Colorado Desert between the communities of Blythe, CA (approximately 24 miles east) and Desert Center, CA (approximately 27 miles west) (refer **Figure 1**).

Genesis Solar, LLC, is proposing to construct, own and operate the Project on an approximate 1,800-acre site near Ford Dry Lake in Riverside County, California (refer **Figure 1**). The Project is a concentrated solar power (CSP) electric generating facility that will use a proven parabolic trough solar thermal technology. The troughs will concentrate the sun’s heat on tubes carrying a petroleum-based Heat Transfer Fluid (HTF) that will be used for steam production. The steam in turn will be used to power a steam turbine generator.

As part of the Genesis Solar Energy Project, it is proposed to divert the off-site watershed using diversion channels/berms. (refer **Figure 2**).

- Flows from the sub-basin 1 (north-western) will be diverted through a channel on the west side of the west 125 MW module;
- Flows from sub-basin 2 (north) will be diverted through a channel between the two 125 MW modules; and
- Flows from sub-basin 3 (north-eastern) will be diverted through a channel along the east side of the east 125 MW module.

Maintenance of the channels will be accomplished as part of the ongoing operations and maintenance of the plant and its facilities. Subcontracted specialists will be engaged as needed to perform specific maintenance activities, and the below channel maintenance program will be implemented.

1.1 PURPOSE AND OBJECTIVES

The purpose of the diversion channels are to prevent interaction with off-site stormwater and onsite stormwater which will allow:

- Allow natural groundwater recharge of the off-site stormwater with no contact with the changed flow conditions of the on-site water;
- Protect the Site infrastructure from flash flood events, which have the potential to damage the solar parabolic troughs;
- Control treatment of the on-site flows from the solar collector array (location of heat transfer fluid within the solar parabolic troughs);
- Protect the Site from upstream sediment loading;

- Control on-site flows in detention basin to ensure there is no increase in post developed flow discharging from the site, minimizing the impact on downstream ephemeral drainage features;
- Maximize the developable area within the solar field;
- Maintain a passageway, particularly through the center channel (channel B/C) for animals that may move from north to south; and
- Develop an environment that is not inviting to fossorial animals (burrowing or living underground), to deter them from burrowing within the channel.

Therefore the objective of the draft channel maintenance plan:

- Maintain channel capacity, so the runoff from upstream watershed (approximately 90,000 acre) is conveyed within the channel in a 100 year, 24 hour storm event; and
- Maintain an environment within and around the channel that is not inviting to fossorial animals while maintaining the passageway if they do access the channel.

2. CHANNEL CONDITIONS

2.1 HYDROLOGY

The channels are design to contain the 100 year, 24 hour storm event within the channel. As shown in **Figure 2**, there are five channels on site which have the following estimated flows during the 100 year storm event:

	STORMWATER FLOW RATE (CFS)
Channel A	1,156.37
Channel B	4,086.17
Channel C	2,006.55
Channel B/C	6,092.72
Channel D	2,600.43
Channel E	253.75
Channel D/E	2,854.18

Typical cross sections of the channels are provided in **Appendix A**. All runoff diversion channels will be designed with a soil/cement mix or similar surface to prevent erosion by providing adequate protection against development of an uncontrolled low-flow thalweg or designed with a low flow channel to control any flow thalweg. The channels are designed with appropriate depth to width ratios and slope erosion control to prevent undercutting and head cutting within the channel.

2.2 BIOLOGY

The slopes will be a maximum of 2H to 1V and the exposed slope protection surface will not be uneven (i.e. no exposed rip rap, gabions, etc) and therefore will not be a hazard to desert tortoises. There will be no vegetation within the channel to deter animal access however box culverts and drop structures, if used, are designed to allow the movement of animals if they do access the channels. The soil/cement mix or similar surface material of the diversion channels will limit fossorial animals ability to borrow.

3. SUCCESS CRITERIA

The following is the success criteria of the channel draft maintenance plan:

- 100 year, 24 hour storm event run off is contained with the channel and daylighted at the outlet, transitioning back into surface sheet flow;
- Berm prevents upstream stormwater run off from entering the Project site;
- No vegetation or debris in the base of the channel;
- Soil-cement lined areas of the base and slopes in good condition (no signs of erosion);

4. INSPECTION AND MAINTENANCE REQUIREMENTS

4.1 INSPECTION PROGRAM

The channels are to be inspected on a semi-annual basis (spring and fall) by the environmental compliance manager (ECM) for routine maintenance activities and after storm events. The inspections are to assess the following within the channel and along the banks:

- Erosion/sedimentation accumulation at the upstream inlet to the channel;
- Erosion/sedimentation accumulation at the downstream inlet to the channel;
- Erosion/sedimentation accumulation within the channel including development of an uncontrolled low-flow thalweg;
- Debris accumulation;

- Condition of the soil-cement lined channel base;
- Visual evidence of the stormwater overtopping the channel;
- Vegetation/weed management;
- Evidence of animal use within or around the channel (i.e. tortoise movement, animal tracks);
- Condition of grade control structures;
- Condition of the berm;
- Condition of the fencing (including any keystone block/reinforced concrete walls);
- Condition of the box culverts;
- Condition of the access roads; and
- Condition of gates and signs.

The ECM will record the finds from the inspection, which will dictate the level of maintenance activities required.

Specially after a storm event, the ECM must note if the stormwater run off caused:

- Significant damage to the project, adjacent property or structural elements of the diversion channel;
- A public safety concern;
- Negatively affected groundwater recharge; or
- Negatively affected adjacent plant communities or posed a hazard to wildlife.

4.2 MAINTENANCE PROGRAM

The maintenance program will be implemented after any deficiencies in the channel system are noted. Generally, routine maintenance will occur after the semi-annual site inspections or as needed after a storm event. Regular maintenance activities may include:

- Removal of all debris accumulation from the channel;
- Removal of accumulated sediment within the channel;
- Repairs to the soil-cement base or slopes if they have signs of erosion;
- Repairs to the culverts if they are not in adequate condition;
- Spraying of vegetation with a aquatic weed control herbicide to control its presence in the channel;
- Repairs to the fence if it is not in an adequate condition to prevent access to the channel;

- Repairs to the access road if it is not in an adequate condition to provide safe road vehicle access to the channel;
- Repairs to the gates if they are not in working order;
- Repairs/replacement of signs if they are not readable.

Debris and sediment can be removed from the channel using equipment that will not damage the soil-cement base and slopes of the channel.

Soil-cement can flex with changes in soil pressures directly underneath the channel and cause cracks. In addition debris in flood flows may cause damage to soil-cement. If there has been any damage to the banks or base of the channel that is soil-cemented lined, the area would need to be isolated and repairs made. Minor cracks can be filled in or alternatively sections of the soil-cement can be cut out, soil-cement mixture relayed and compacted.

Cracks in the culverts can also be filled in using a portland cement-based mortar or a flexible sealing type material.

Weed control is required within and around the channel due to the presence of invasive weeds on the Genesis Solar LLC Facility. As the base of the channel may be soil-cement, it will not be expected to have any weeds. However, nutrient rich sediment that has dropped out during storm events may start growing weeds. There is a Site Weed Management Plan that addresses weed prevention and control around the project site. In addition, an aquatic weed control herbicide (such as Rodeo) will be sprayed in the base of the channel on a semi annual basis.

Repairs to the fence / gate / road / signage will all be undertaken on an as needed basis, as determined by the ECM and Facility Operator after the semi-annual inspection. The extent of repairs will be dependant on the level of degradation and assessment of its ability to meet its operational purpose and health and safety impact.

At the end of the Project life, it is expected that the channels will be restored to pre-project grades. Therefore a post project maintenance plan would not be required.

5. EMERGENCY REPAIRS

Emergency repairs will be undertaken as needed to ensure the capacity of the channel is not restricted. Emergency repairs may be required over the life of the Project due to unforeseen collapses to berms, embankments or in-stream structures. Other structures that may need emergency repair work would be channel crossings and vertical walls (i.e. keystone block, reinforced concrete etc).

6. REPORTING

A maintenance log will be kept by the ECM and maintained at the Genesis Solar LLC facility summarizing the inspections, maintenance activities, and any corrective actions taken including

emergency repairs. The log will also include the date of task (inspection / maintenance), who undertook the task and a description of the findings. If the task requires removal of sediment or debris, the location of where the sediment was removed from and location of where it was disposed will be recorded. The log will be on site and available to the CEC upon request.

By January 31st of each year, Genesis Solar LLC will submit an Annual Report to the appropriate regulatory agency including a summary of the inspection and maintenance activities, and any corrective actions taken including emergency repairs. The condition of the channels will be compared against the success criteria to determine any deficiencies in the maintenance program and the program updated accordingly.


7. COST

The annual cost of the maintenance program may be **\$31,558** however this value will fluctuate depending on the volume of sediment and debris removed, and required repairs (i.e. to fences, signage, gates and access roads) (refer to **Table 1**).


There are no planned capital improvement projects scheduled for the channel at this time. Any future capital improvement projects may impact this draft channel maintenance plan, therefore this plan will be updated as required to reflect the current conditions.

Genesis Solar LLC will have an allocation for channel maintenance, including emergency repairs, in their annual operating budget. If the annual budget is not fully used in any one year, then it may be rolled over to the following year's budget allocation as appropriate.

FIGURES

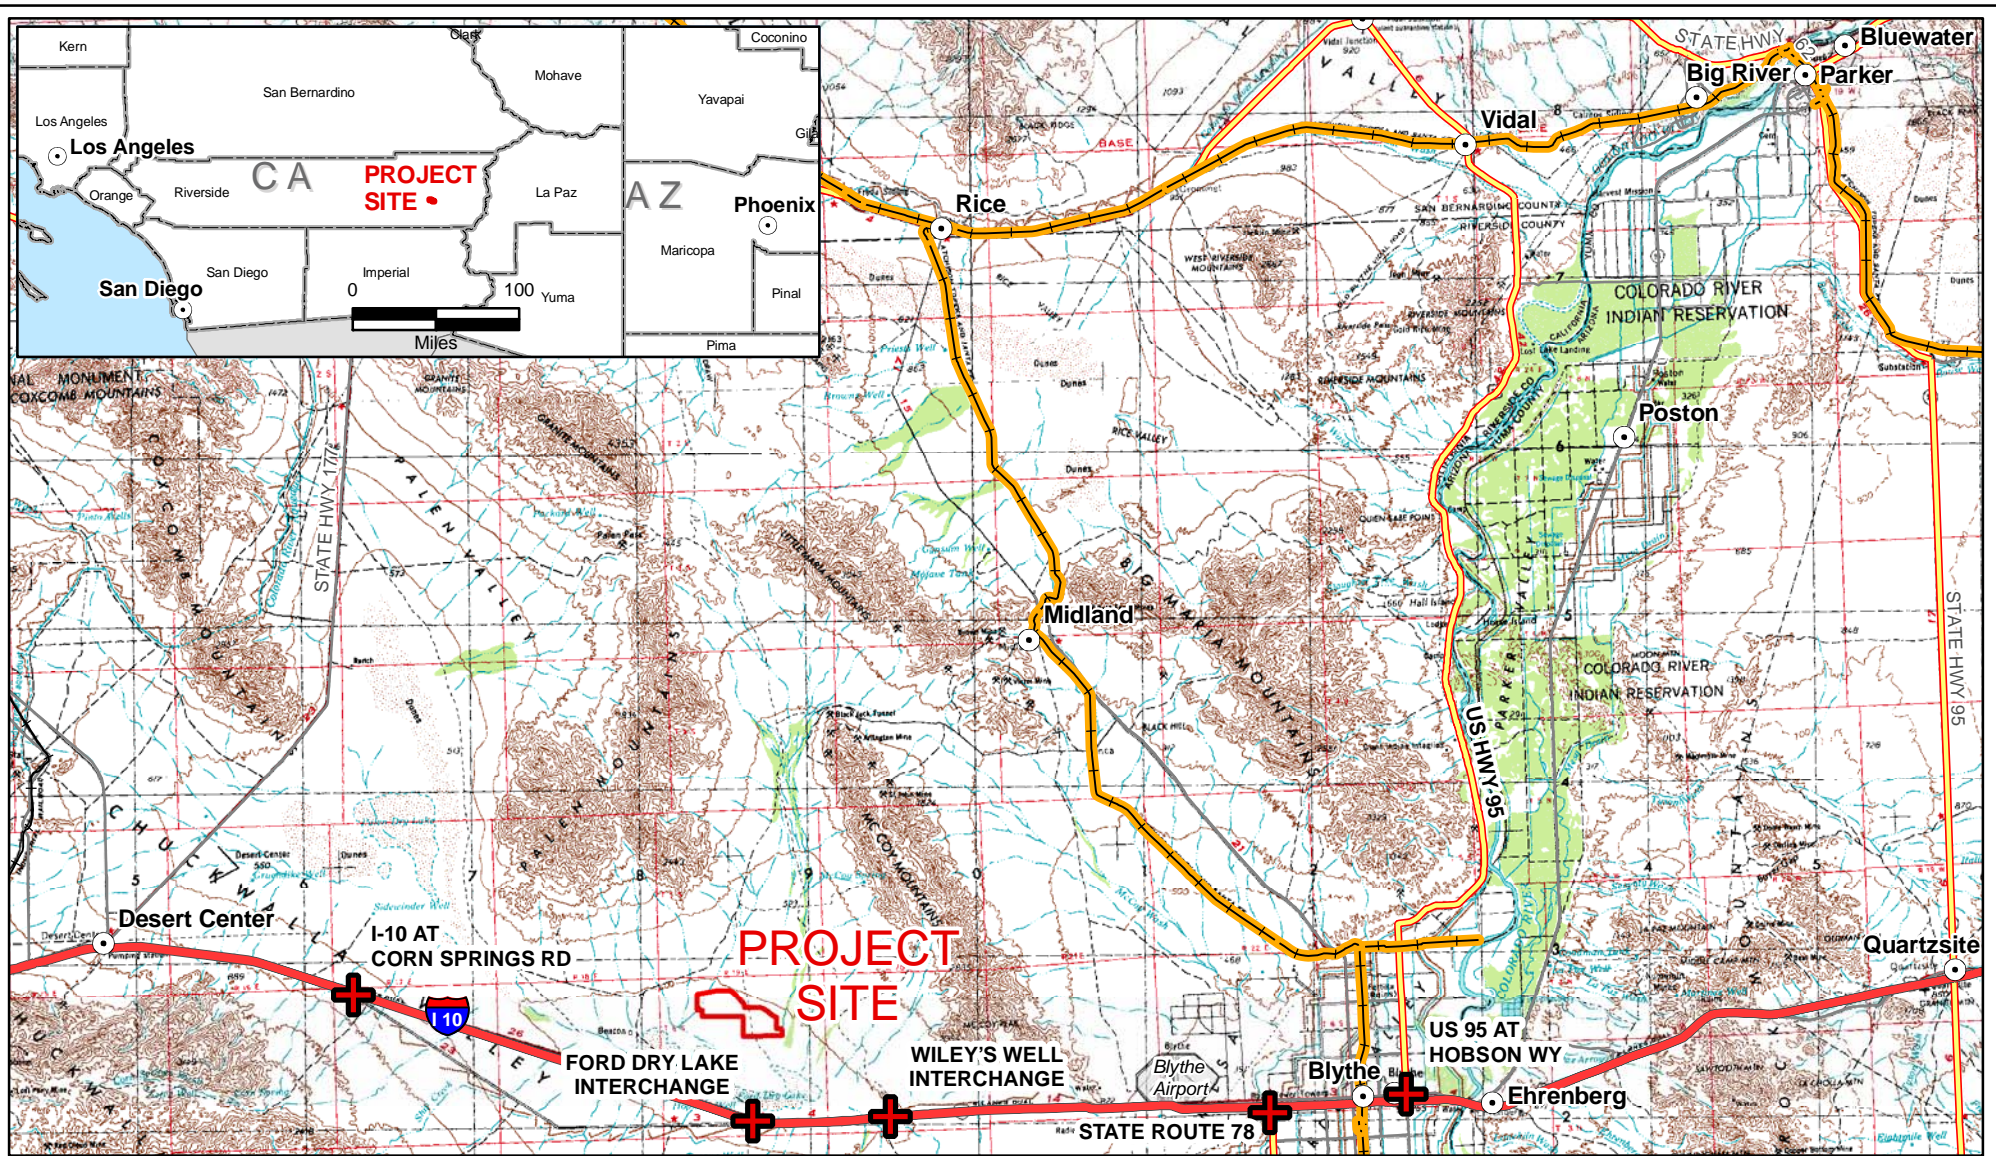

SOURCE:
 USGS 250K Quad Sheet, Salton Sea, Needles
 ESRI Cities, SDC Major Roads, Tiger Railroad
 All locations approximate

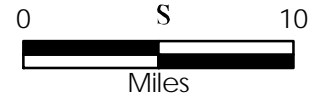

GENESIS SOLAR ENERGY PROJECT




WorleyParsons
 resources & energy

LOCATION MAP


SWL	JM	7/2009
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52004617

1

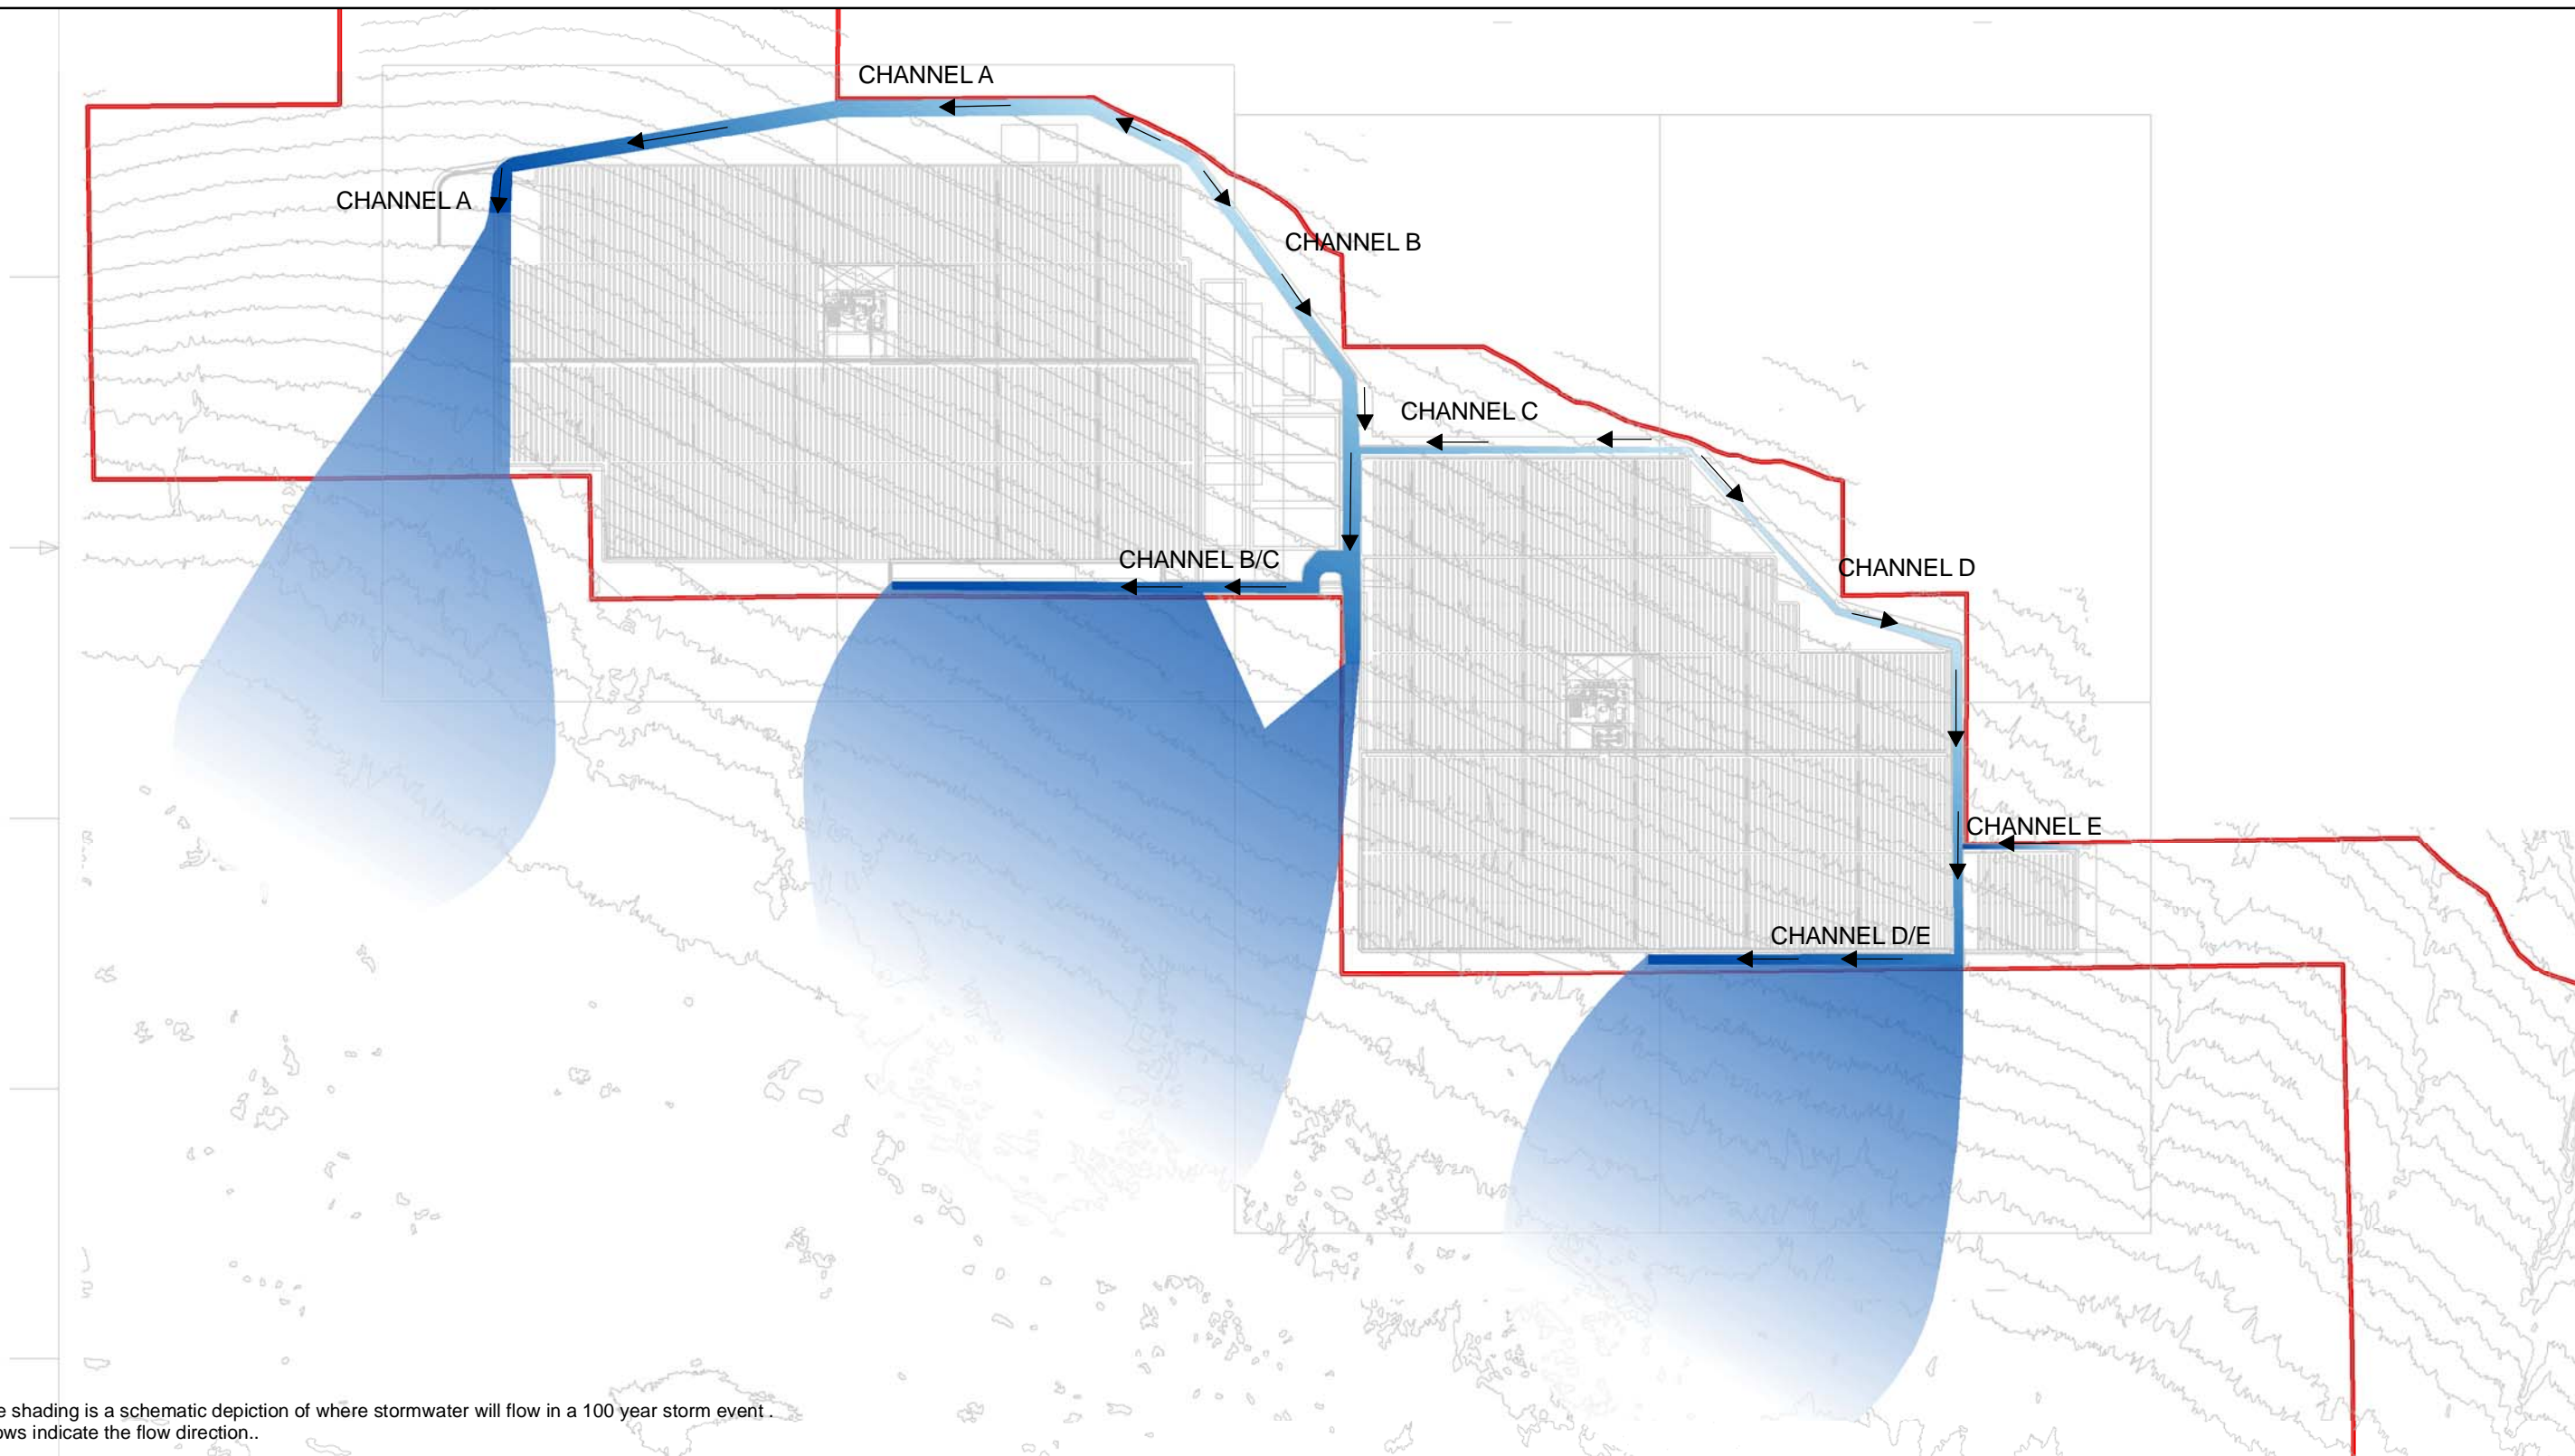

Note: The blue shading is a schematic depiction of where stormwater will flow in a 100 year storm event.
The black arrows indicate the flow direction..

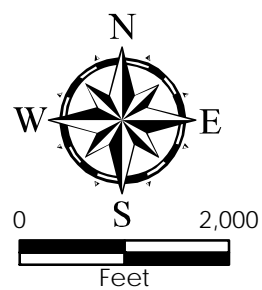

GENESIS SOLAR ENERGY PROJECT
GENESIS SOLAR, LLC



**100 YEAR POST
DEVELOPED FLOW PATTERN**

SWL PM 1/2010

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TABLES

TABLE 1
ANNUAL MAINTENANCE COST ESTIMATE
Gensis Solar Energy Project
Draft Channel Maintenance Plan

ACTIVITY	UNIT TYPE	ACTIVITY FREQUENCY PER YEAR	NO OF UNITS PER ACTIVITY	TOAL UNITS PER YEAR	UNIT COST PER YEAR	SUB TOTAL	COST REFERENCE
Channel, Berm and Road Inspections - Quarterly	Labour	2	74.2	148.4	\$ 30	\$ 4,452	Assume 1 hour to inspect one acre, 2 times per year
Channel Inspections - Wet Weather	Labour	2	37.1	74.2	\$ 30	\$ 2,226	Assume 30 mins to inspect one acre, 2 times per year
Weed Control - Spray aquatic herbicide (Rodeo or equivalent)	Labour, Equipment and Materials	2	37.1	74.2	\$ 100	\$ 7,420	Assume 2 people taking 30 mins to do one acre using an existing buggy, 2 times a year
Debris Collection and Removal	Labour	1	12	12	\$ 30	\$ 360	Assume one removal activity per year in six different locations, each taking 2 hours of work
Sedimentation Removal and Disposal	Labour and Materials	As Needed				\$ 4,000	Estimated - may not be used every year or may require more depending on the required work
Reperations to fence, gate, signage and access road	Labour and Materials	As Needed				\$ 4,000	Estimated - may not be used every year or may require more depending on the required work
Emergency Repairs - as needed	Labour, Equipment and Materials	As Needed				\$ 4,000	Estimated - may not be used every year or may require more depending on the required work
Reporting - Annual	Report	1	60	60	\$ 85	\$ 5,100	Assume 60 hours to undertake the annual report
TOTAL COST						\$ 31,558	

Note



1. There are 74.2 acres of channel area, including the base and side slopes of the channel.

APPENDIX A: GRADING AND DRAINAGE DRAWINGS

10 9 8 7 6 5 4 3 2 1

REFERENCES:
 GENI-0-SK-111-002-001, GENERAL ARRANGEMENT, OVERALL SITE PLAN, FIGURE 3.4-1
 GENI-1-DW-112-716-004-001, CONCEPTUAL GRADING PLAN, OVERALL PLAN, SHEET 1 OF 7
 GENI-1-DW-112-716-004-002, CONCEPTUAL GRADING PLAN, SHEET 2 OF 7
 GENI-1-DW-112-716-004-003, CONCEPTUAL GRADING PLAN, SHEET 3 OF 7
 GENI-1-DW-112-716-004-004, CONCEPTUAL GRADING PLAN, SHEET 4 OF 7
 GENI-1-DW-112-716-004-005, CONCEPTUAL GRADING PLAN, SHEET 5 OF 7
 GENI-1-DW-112-716-004-006, CONCEPTUAL GRADING PLAN, SHEET 6 OF 7
 GENI-1-DW-112-716-004-007, CONCEPTUAL GRADING PLAN, SHEET 7 OF 7
 GENI-1-DW-112-726-002-001, CONCEPTUAL GRADING DETAILS AND SECTIONS, SHEET 1 OF 2
 GENI-1-DW-112-726-002-002, CONCEPTUAL GRADING DETAILS AND SECTIONS, SHEET 2 OF 2
 DIVERSION CHANNEL CROSS SECTION SHEETS

NOTES:
 1. COORDINATE SYSTEM BASED ON CALIFORNIA STATE PLANE, ZONE 6, NAD 83.
 2. THE GRADING PLANS ARE BASED ON GENI-0-SK-111-002-001, GENERAL ARRANGEMENT, REVISION D.

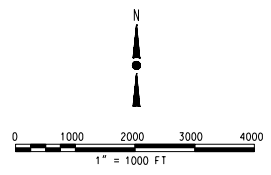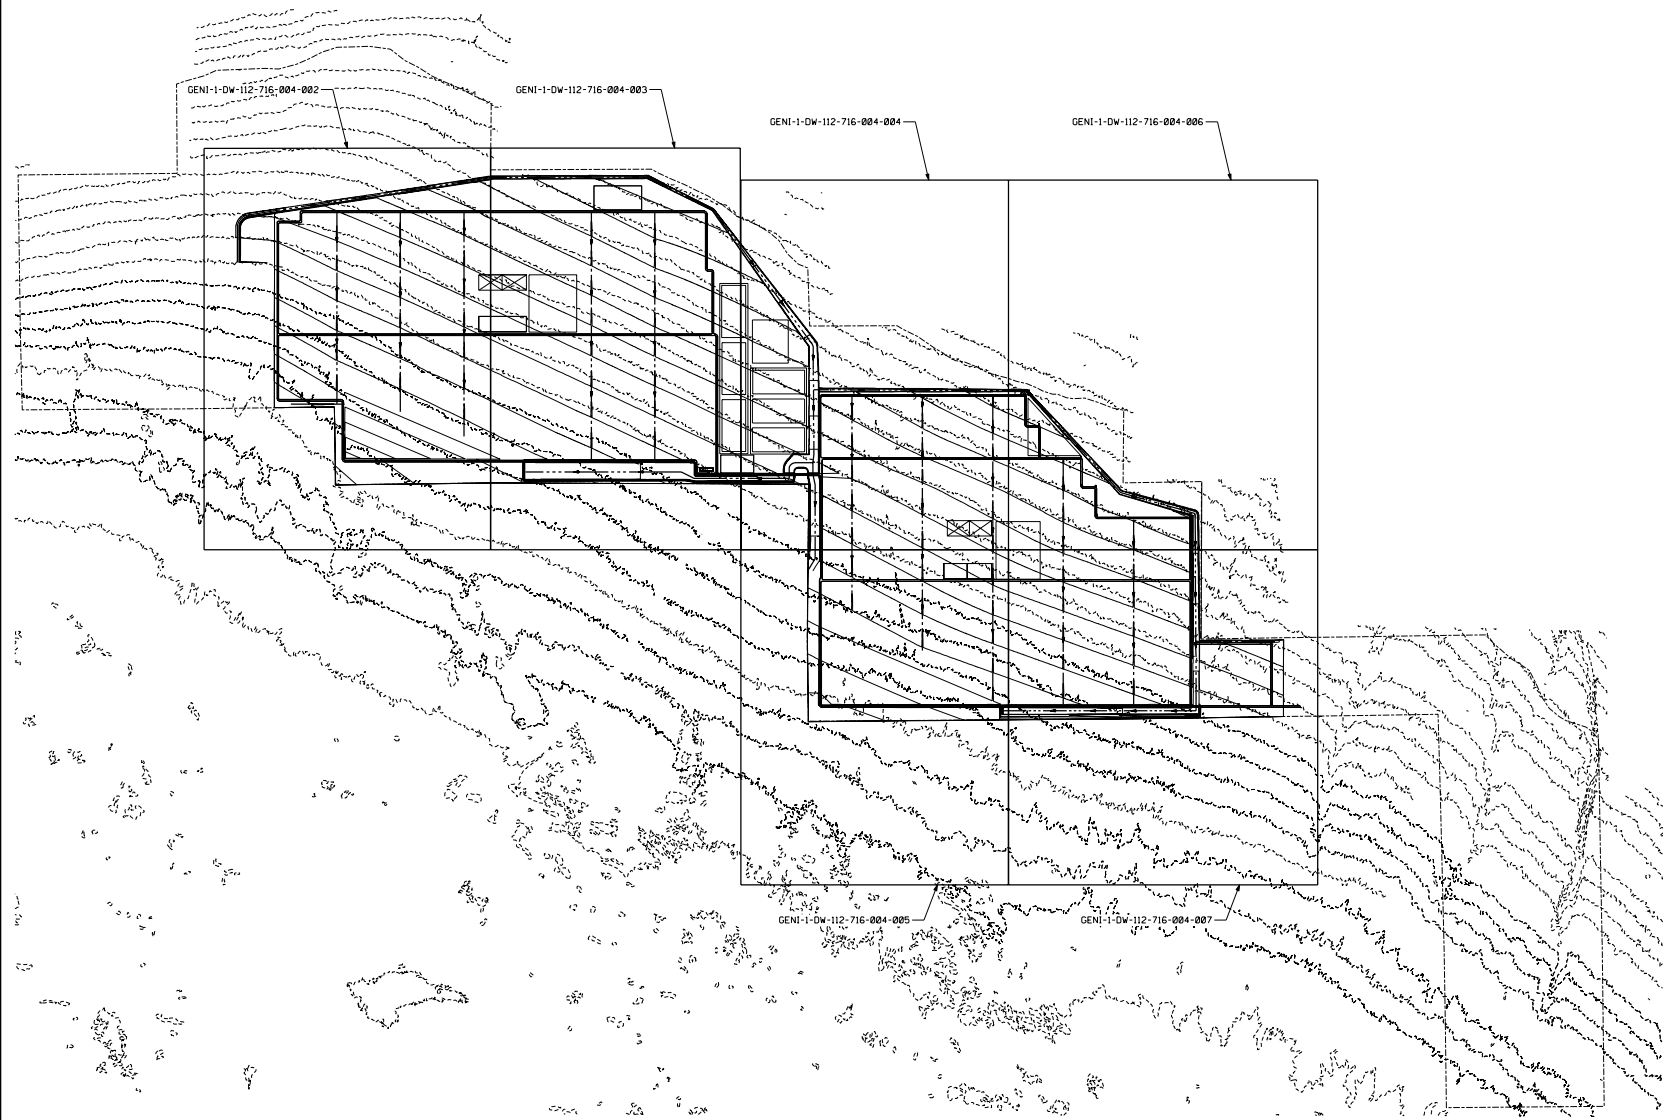


REV	DATE	DESCRIPTION	APPROVED BY	CHECKED BY	DATE
1		ISSUED FOR REVIEW	APL	JOB	BABABP
CHALLENGE STATUS DATE REPRESENTS GENERAL DESIGN CONCEPTS BASED ON ASSUMPTIONS. REVISED NOT CHECKED.					
REVISION STATUS DATE REPRESENTS REVIEWED AND APPROVED DESIGN. ANY PORTION MARKED "HOLD" REMAINS PRELIMINARY STATUS.					
ORIGINATING PERSONNEL			PROFESSIONAL ENGINEER'S SEAL		
DRAWN BY A. PRATT CHECKED BY E. LEIBY LEAD DESIGNER J. DAHLGREN ENGINEER/TECH SPECIALIST B. ANDERS PROJECT ENGINEERING MANAGER B. ANDERS PROJECT MANAGER B. PIETRUCHA					
CLIENT/PROJECT TITLE GENESIS SOLAR LLC GENESIS SOLAR ENERGY PROJECT					
CONCEPTUAL GRADING PLAN OVERALL PLAN					
SCALE 1"=200'		DRAWING SIZE ARCH D (36" x 24")			
GENI-1-DW-112-716-004-001					REV 1

10 9 8 7 6 5 4 3 2 1

REFERENCES:

- GENI-0-SK-111-002-001, GENERAL ARRANGEMENT, OVERALL SITE PLAN, FIGURE 3.4-1
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- GENI-1-DW-112-716-004-004, CONCEPTUAL GRADING PLAN, SHEET 4 OF 7
- GENI-1-DW-112-716-004-005, CONCEPTUAL GRADING PLAN, SHEET 5 OF 7
- GENI-1-DW-112-716-004-006, CONCEPTUAL GRADING PLAN, SHEET 6 OF 7
- GENI-1-DW-112-716-004-007, CONCEPTUAL GRADING PLAN, SHEET 7 OF 7
- GENI-1-DW-112-726-005-001, CONCEPTUAL GRADING DETAILS AND SECTIONS, SHEET 1 OF 2
- GENI-1-DW-112-726-005-002, CONCEPTUAL GRADING DETAILS AND SECTIONS, SHEET 2 OF 2
- DIVERSION CHANNEL CROSS SECTION SHEETS

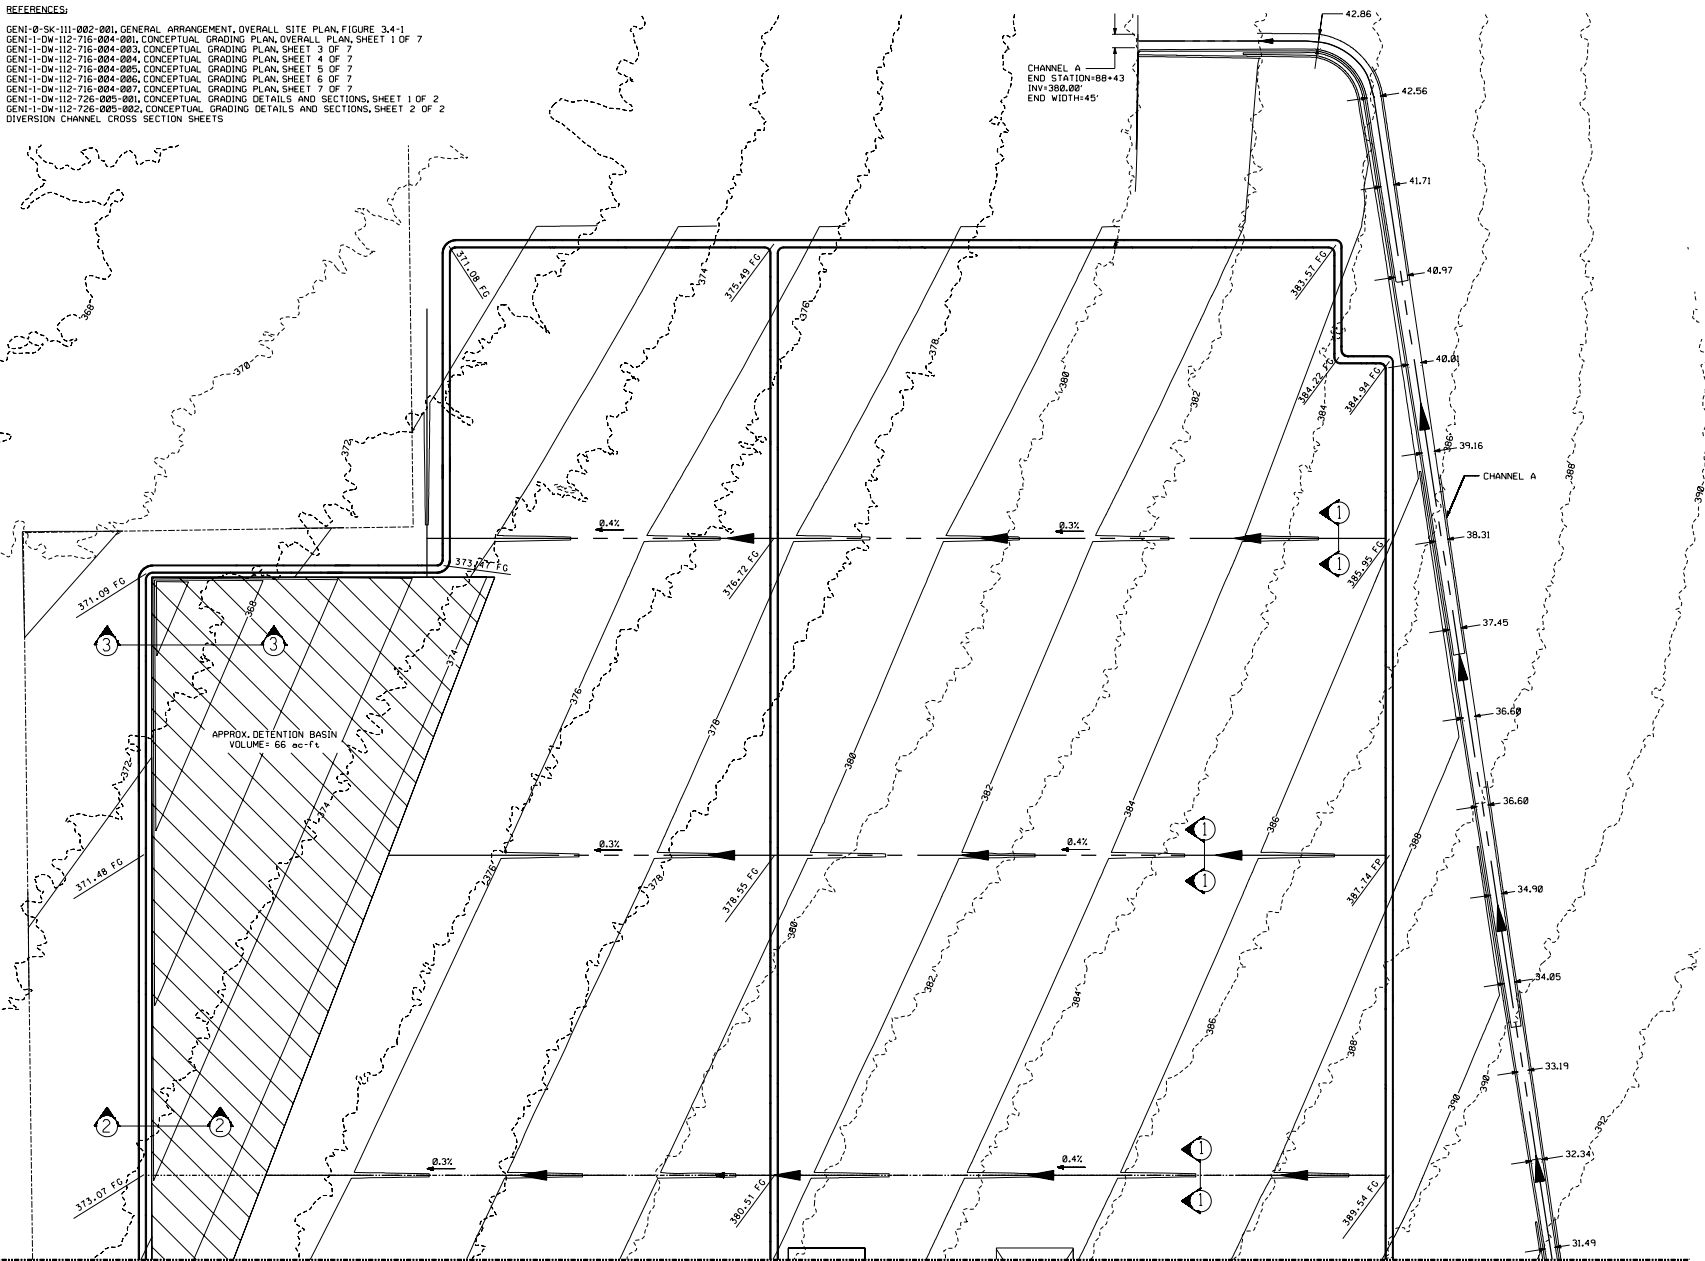


LEGEND

- DRAINAGE CHANNEL CENTERLINE
- PROPOSED CONTOUR
- EXISTING CONTOUR
- PROPERTY BOUNDARY
- DITCH SLOPE
- ROAD ELEVATION

NOTES:

- COORDINATE SYSTEM BASED ON CALIFORNIA STATE PLANE, ZONE 6, NAD 83.
- THE GRADING PLANS ARE BASED ON GENI-0-SK-111-002-001, GENERAL ARRANGEMENT, REVISION D.

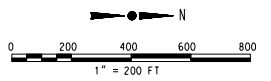

REV	DATE	DESCRIPTION	BY	CHECKED	DATE	PERIOD	PROJECT
1		ISSUED FOR REVIEW	AP	EL			

REVISION STATUS	DATE	REVISIONS
PRELIMINARY STATUS		REPRESENTS PRELIMINARY DESIGN CONCEPTS BASED ON ASSUMPTIONS. REVIEWS NOT CHECKED.
FOR REVIEW STATUS		REPRESENTS REVIEWED AND APPROVED DESIGN. ANY PORTION MARKED "HOLD" REMAINS PRELIMINARY STATUS.

DRAWN BY A. PRATT	PROFESSIONAL ENGINEER'S SEAL
CHECKED BY E. LEIBY	
LEAD DESIGNER A. PRATT	
ENGINEER/TECH SPECIALIST B. ANDERS	
PROJECT ENGINEERING MANAGER B. ANDERS	
PROJECT MANAGER B. PIETRUCHA	



CLIENT/PROJECT TITLE
GENESIS SOLAR LLC
GENESIS SOLAR ENERGY PROJECT

CONCEPTUAL
GRADING PLAN
DRAWING 2 OF 7

SCALE: 1" = 200' DRAWING SIZE: ARCH D (36" x 24")
WORLEYPARSONS DWG NO.: GENI-1-DW-112-716-004-002 REV: 1

MATCHLINE SEE SHEET GENI-1-DW-112-716-004-002

REFERENCES:


- GENI-0-SK-111-002-001, GENERAL ARRANGEMENT, OVERALL SITE PLAN, FIGURE 3.4-1
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- GENI-1-DW-112-716-004-005, CONCEPTUAL GRADING PLAN, SHEET 5 OF 7
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- GENI-1-DW-112-716-004-007, CONCEPTUAL GRADING PLAN, SHEET 7 OF 7
- GENI-1-DW-112-726-005-001, CONCEPTUAL GRADING DETAILS AND SECTIONS, SHEET 1 OF 2
- GENI-1-DW-112-726-005-002, CONCEPTUAL GRADING DETAILS AND SECTIONS, SHEET 2 OF 2

LEGEND:

- DRAINAGE CHANNEL CENTERLINE:
- PROPOSED CONTOUR:
- EXISTING CONTOUR:
- PROPERTY BOUNDARY:
- DITCH SLOPE:
- ROAD ELEVATION:
- 24" CULVERT:
- 12" CULVERT:

NOTES:

- 1. COORDINATE SYSTEM BASED ON CALIFORNIA STATE PLANE, ZONE 6, NAD 83.
- 2. THE GRADING PLANS ARE BASED ON GENI-0-SK-111-002-001, GENERAL ARRANGEMENT, REVISION D.

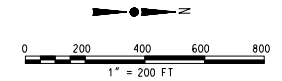

REV	DATE	DESCRIPTION	BY	CHKD	APP'D	REVISIONS
1	15	ISSUED FOR REVIEW	AP	EL	BA	BAB
REVISIONS			DESIGN	CHECK	APPROVE	DATE

DATE	DATE	DATE	DATE	DATE	DATE	DATE	DATE
DATE	DATE	DATE	DATE	DATE	DATE	DATE	DATE
DATE	DATE	DATE	DATE	DATE	DATE	DATE	DATE
DATE	DATE	DATE	DATE	DATE	DATE	DATE	DATE

DRAWN BY: A, PRATT
 CHECKED BY: E, LEIBY
 LEAD DESIGNER: A, PRATT
 ENGINEER/TECH SPECIALIST: B, ANDERS
 PROJECT ENGINEERING MANAGER: E, ANDERS
 PROJECT MANAGER: B, PIETRUCHA




CLIENT/PROJECT TITLE
 GENESIS SOLAR LLC
 GENESIS SOLAR ENERGY PROJECT

CONCEPTUAL
 GRADING PLAN
 DRAWING 3 OF 7

SCALE: 1"=200'
 DATE: MARCH 0 (36" x 24")
 FILE NAME: 112-716-004-003
 SHEET NUMBER: 1


MATCHLINE SEE SHEET GENI-1-DW-112-716-004-004

MATCHLINE SEE SHEET GENI-1-DW-112-716-004-003

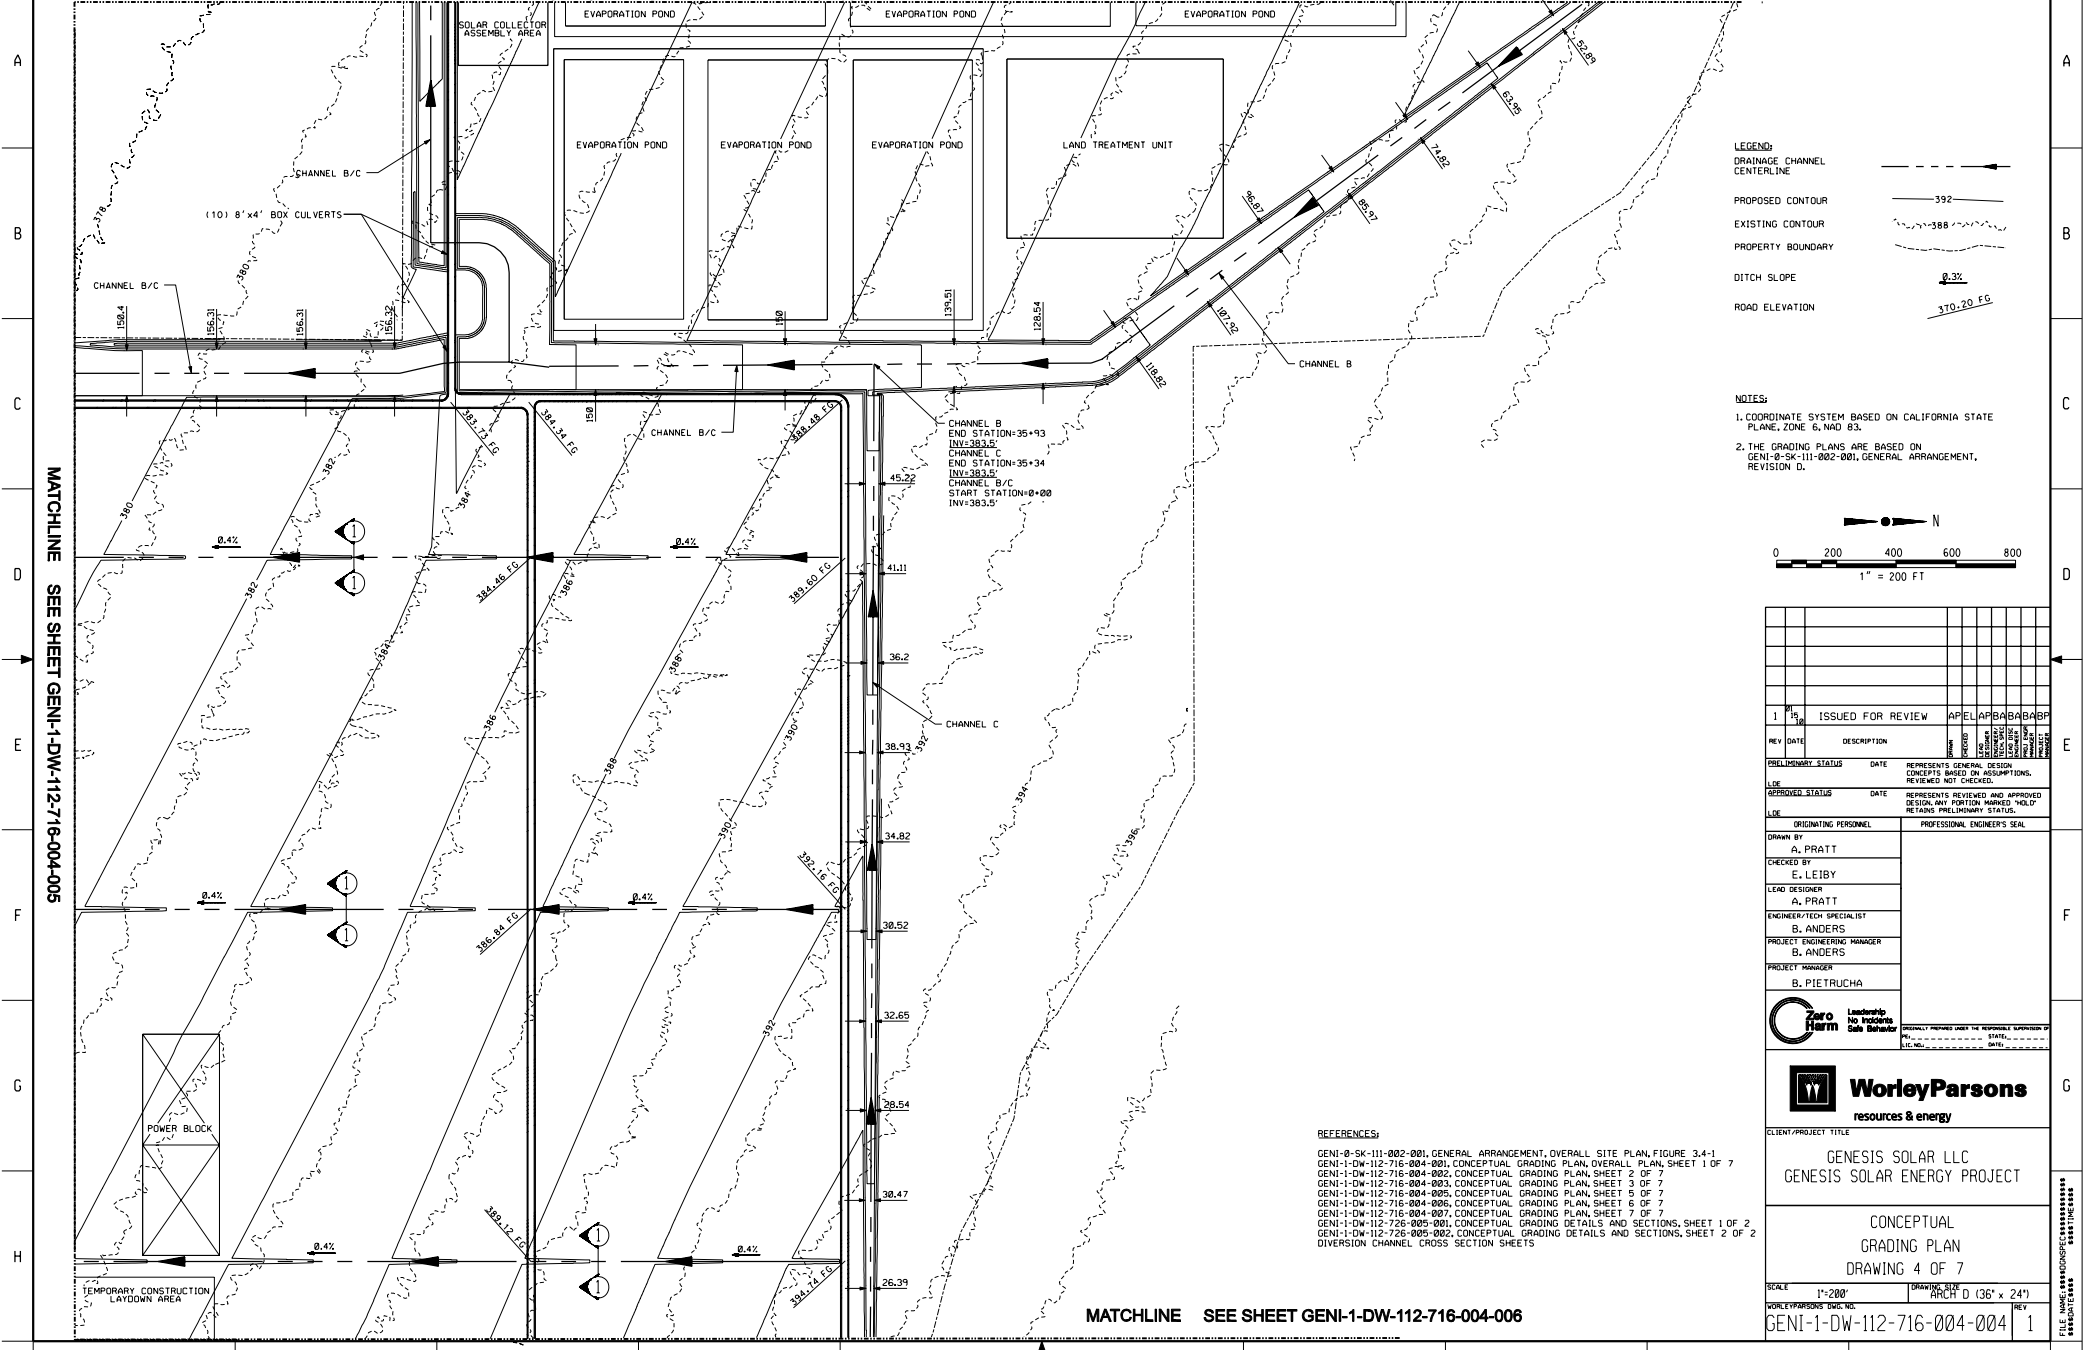

- LEGEND:**
- DRAINAGE CHANNEL CENTERLINE
 - PROPOSED CONTOUR
 - - - EXISTING CONTOUR
 - - - PROPERTY BOUNDARY
 - 0.3% DITCH SLOPE
 - 370.20 FG ROAD ELEVATION

- NOTES:**
- COORDINATE SYSTEM BASED ON CALIFORNIA STATE PLANE, ZONE 6, NAD 83.
 - THE GRADING PLANS ARE BASED ON GENI-0-SK-111-002-001, GENERAL ARRANGEMENT, REVISION D.

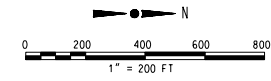

REV	DATE	DESCRIPTION	AP	EL	LP	BP	BP	BP	BP	BP
1	11/18	ISSUED FOR REVIEW	AP	EL	LP	BP	BP	BP	BP	BP

<p>REVISIONS:</p> <p>DATE: _____</p> <p>DESCRIPTION: _____</p>	<p>DATE: _____</p> <p>DESCRIPTION: _____</p>
--	--

DRAWN BY: A. PRATT
 CHECKED BY: E. LEIBY
 LEAD DESIGNER: A. PRATT
 ENGINEER/TECH SPECIALIST: B. ANDERS
 PROJECT ENGINEERING MANAGER: B. ANDERS
 PROJECT MANAGER: B. PIETRUCHA



- REFERENCES:**
- GENI-0-SK-111-002-001, GENERAL ARRANGEMENT, OVERALL SITE PLAN, FIGURE 3.4-1
 - GENI-1-DW-112-716-004-001, CONCEPTUAL GRADING PLAN, OVERALL PLAN, SHEET 1 OF 7
 - GENI-1-DW-112-716-004-002, CONCEPTUAL GRADING PLAN, SHEET 2 OF 7
 - GENI-1-DW-112-716-004-003, CONCEPTUAL GRADING PLAN, SHEET 3 OF 7
 - GENI-1-DW-112-716-004-005, CONCEPTUAL GRADING PLAN, SHEET 5 OF 7
 - GENI-1-DW-112-716-004-006, CONCEPTUAL GRADING PLAN, SHEET 6 OF 7
 - GENI-1-DW-112-716-004-007, CONCEPTUAL GRADING PLAN, SHEET 7 OF 7
 - GENI-1-DW-112-726-005-001, CONCEPTUAL GRADING DETAILS AND SECTIONS, SHEET 1 OF 2
 - GENI-1-DW-112-726-005-002, CONCEPTUAL GRADING DETAILS AND SECTIONS, SHEET 2 OF 2


CLIENT/PROJECT TITLE
 GENESIS SOLAR LLC
 GENESIS SOLAR ENERGY PROJECT

CONCEPTUAL GRADING PLAN
 DRAWING 4 OF 7

SCALE: 1"=200' GRAPHIC SCALE: ARCH D (36" x 24")
 WORLEYPARSONS' DRAWING NO.: GENI-1-DW-112-716-004-004
 FILE NAME: GENI-1-DW-112-716-004-004
 REV: 1


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MATCHLINE SEE SHEET GENI-1-DW-112-716-004-006

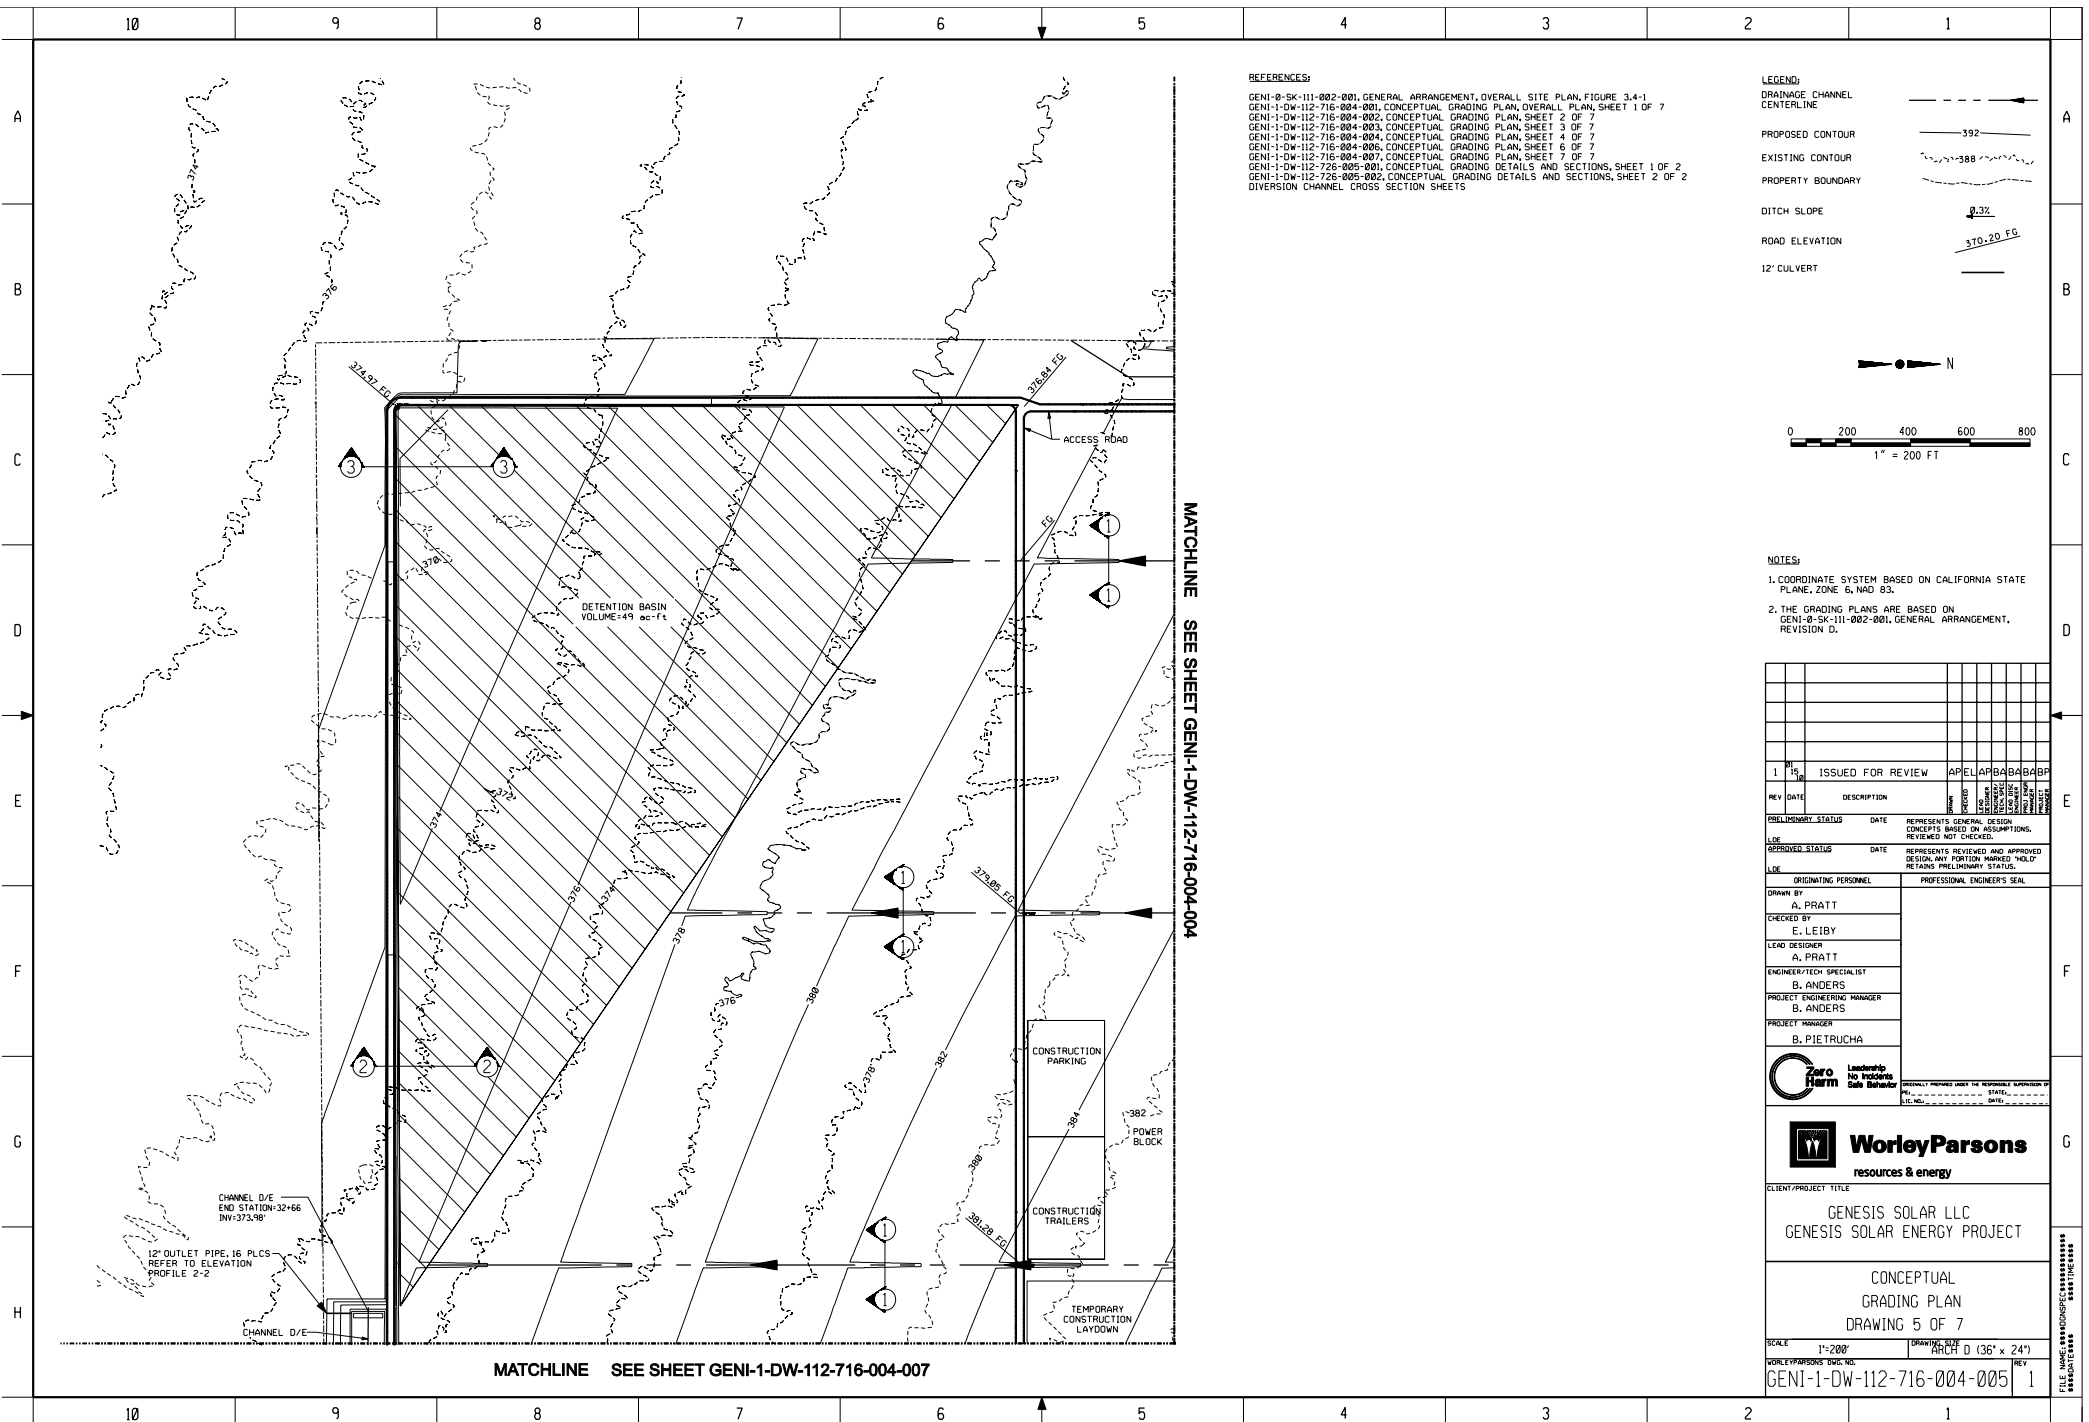

- REFERENCES:**
- GENI-0-SK-111-002-001, GENERAL ARRANGEMENT, OVERALL SITE PLAN, FIGURE 3.4-1
 - GENI-1-DW-112-716-004-001, CONCEPTUAL GRADING PLAN, OVERALL PLAN, SHEET 1 OF 7
 - GENI-1-DW-112-716-004-002, CONCEPTUAL GRADING PLAN, SHEET 2 OF 7
 - GENI-1-DW-112-716-004-003, CONCEPTUAL GRADING PLAN, SHEET 3 OF 7
 - GENI-1-DW-112-716-004-004, CONCEPTUAL GRADING PLAN, SHEET 4 OF 7
 - GENI-1-DW-112-716-004-005, CONCEPTUAL GRADING PLAN, SHEET 5 OF 7
 - GENI-1-DW-112-716-004-006, CONCEPTUAL GRADING PLAN, SHEET 6 OF 7
 - GENI-1-DW-112-716-004-007, CONCEPTUAL GRADING PLAN, SHEET 7 OF 7
 - GENI-1-DW-112-726-005-001, CONCEPTUAL GRADING DETAILS AND SECTIONS, SHEET 1 OF 2
 - GENI-1-DW-112-726-005-002, CONCEPTUAL GRADING DETAILS AND SECTIONS, SHEET 2 OF 2
 - DIVERSION CHANNEL CROSS SECTION SHEETS

- LEGEND:**
- DRAINAGE CHANNEL CENTERLINE
 - PROPOSED CONTOUR
 - EXISTING CONTOUR
 - PROPERTY BOUNDARY
 - DITCH SLOPE
 - ROAD ELEVATION
 - 12" CULVERT

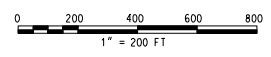

- NOTES:**
- COORDINATE SYSTEM BASED ON CALIFORNIA STATE PLANE, ZONE 6, NAD 83.
 - THE GRADING PLANS ARE BASED ON GENI-0-SK-111-002-001, GENERAL ARRANGEMENT, REVISION D.

REV	DATE	DESCRIPTION	AP	EL	AP	BA	BA	BA	BP
1		ISSUED FOR REVIEW							

REVISION STATUS	DATE	REPRESENTS GENERAL DESIGN CONCEPTS BASED ON ASSUMPTIONS. REVISED NOT CHECKED.
FOR PREPARED STATUS		REPRESENTS REVIEWED AND APPROVED DESIGN. ANY PORTION MARKED "HOLD" REMAINS PRELIMINARY STATUS.

DRAWN BY A. PRATT	
CHECKED BY E. LEIBY	
LEAD DESIGNER A. PRATT	
ENGINEER/TECH SPECIALIST B. ANDERS	
PROJECT ENGINEERING MANAGER B. ANDERS	
PROJECT MANAGER B. PIETRUCHA	




CLIENT/PROJECT TITLE
GENESIS SOLAR LLC
GENESIS SOLAR ENERGY PROJECT

CONCEPTUAL
GRADING PLAN
DRAWING 5 OF 7


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WORLEYPARSONS' DRAWING NO. GENI-1-DW-112-716-004-005	REV 1

MATCHLINE SEE SHEET GENI-1-DW-112-716-004-007

MATCHLINE SEE SHEET GENI-1-DW-112-716-004-004

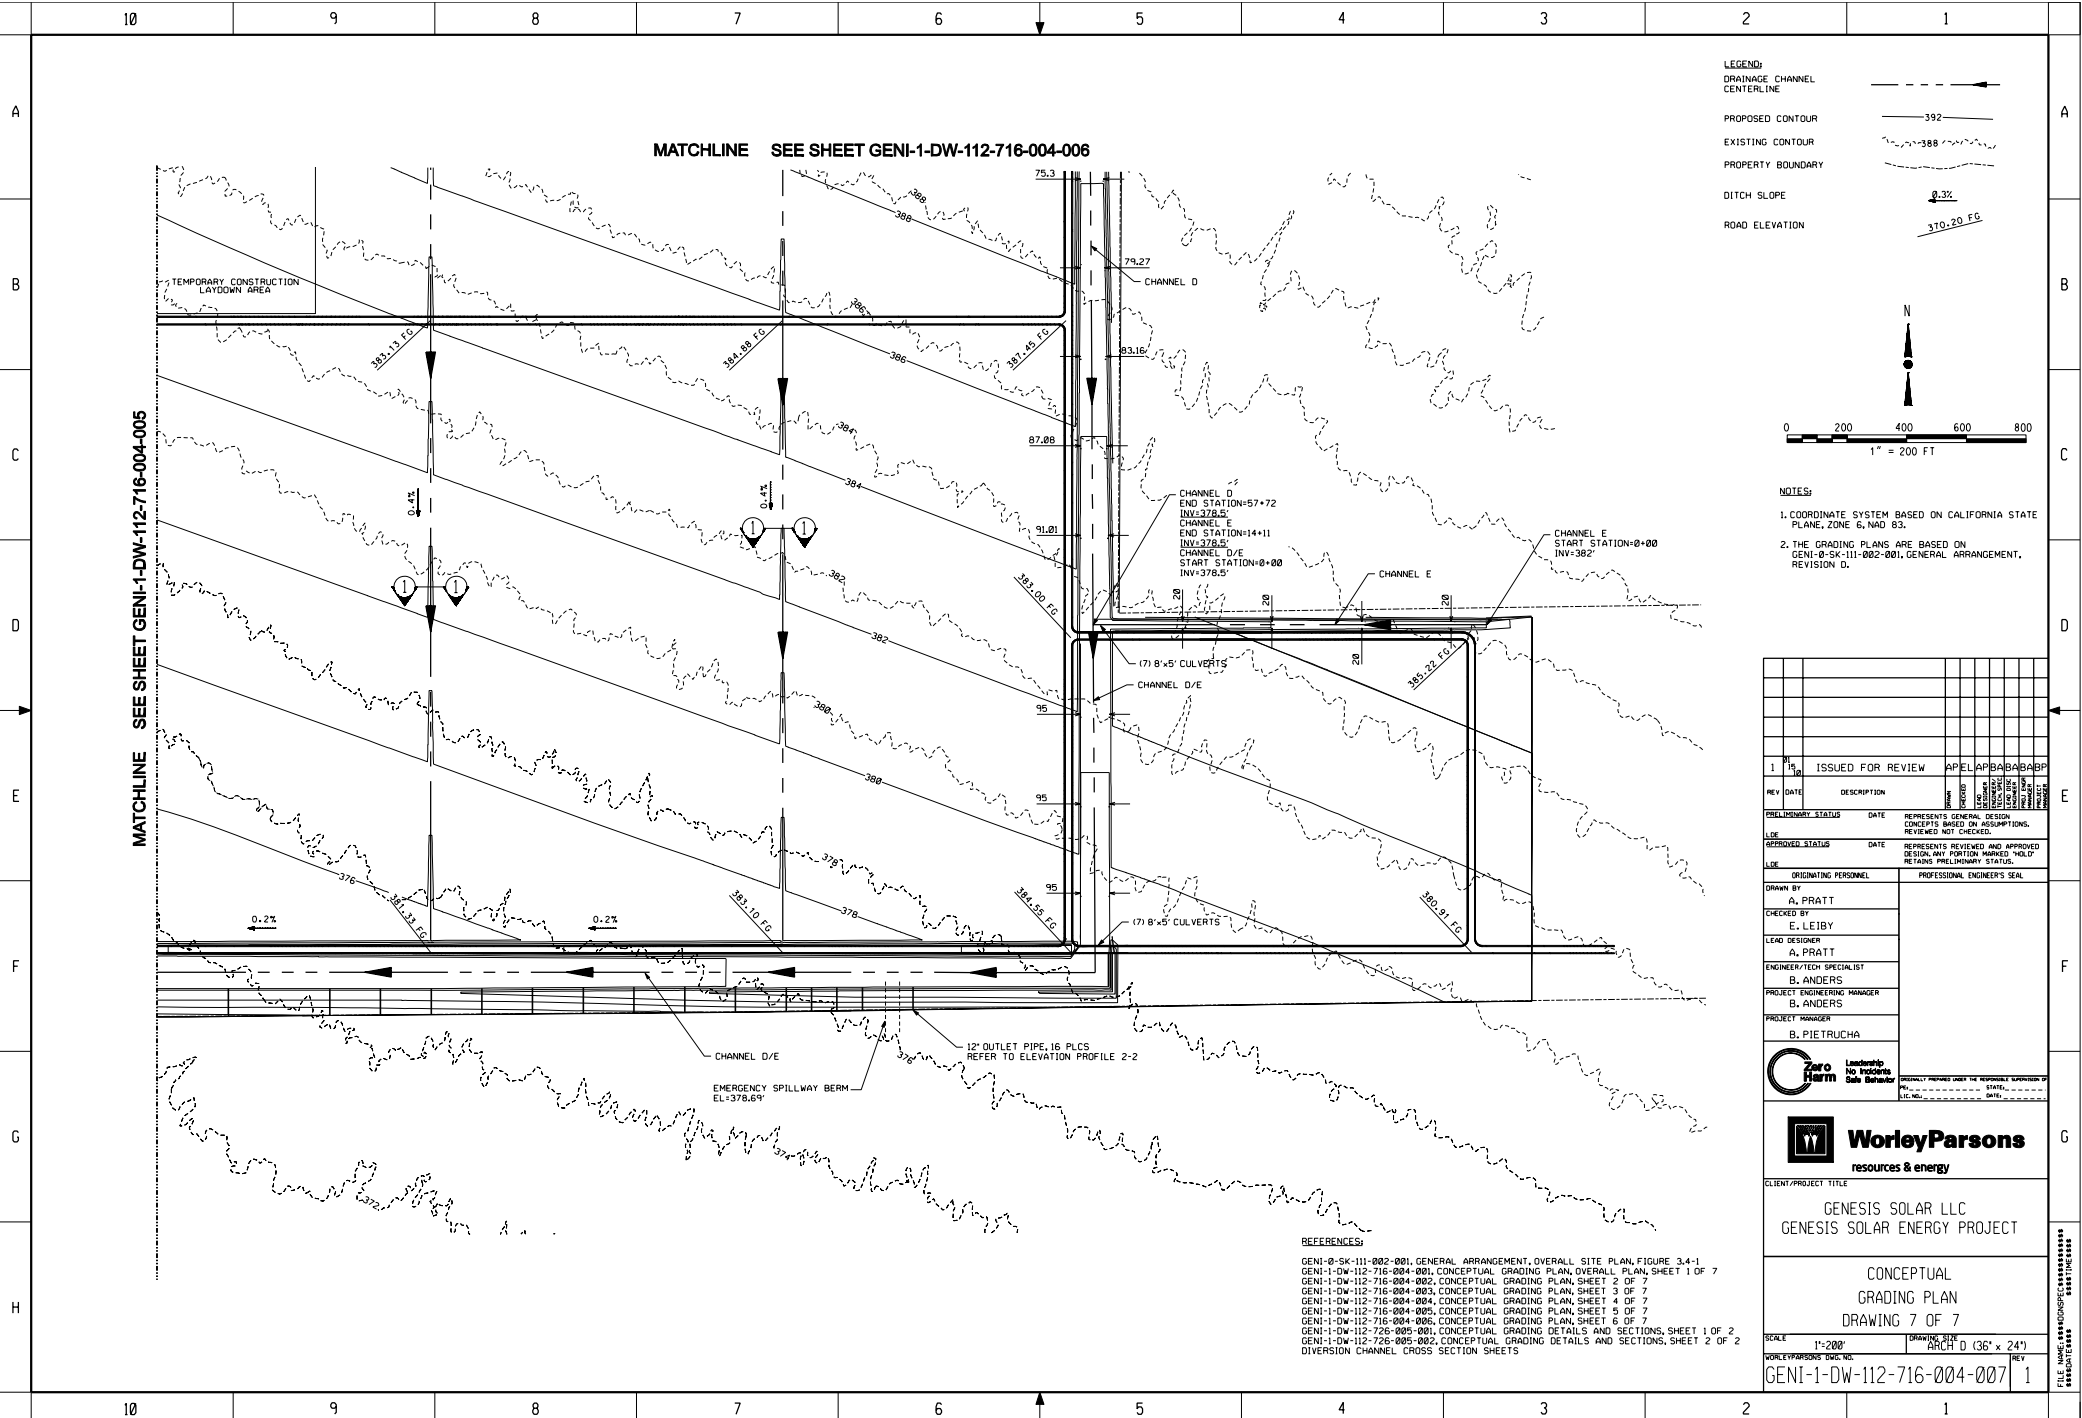

LEGEND:
 DRAINAGE CHANNEL CENTERLINE
 PROPOSED CONTOUR
 EXISTING CONTOUR
 PROPERTY BOUNDARY
 DITCH SLOPE
 ROAD ELEVATION

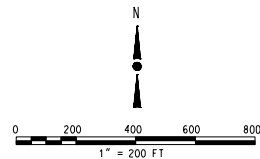

NOTES:
 1. COORDINATE SYSTEM BASED ON CALIFORNIA STATE PLANE, ZONE 6, NAD 83.
 2. THE GRADING PLANS ARE BASED ON GENI-0-SK-111-002-001, GENERAL ARRANGEMENT, REVISION D.

1	ISSUED FOR REVIEW	AP	EL	AP	BA	BA	BA	BA	BA
REV DATE	DESCRIPTION	DESIGNED	DRAWN	CHECKED	ENGINEER	PROJECT	MANAGER	OWNER	
DEVELOPMENT STATUS		DATE	REPRESENTS GENERAL DESIGN CONCEPTS BASED ON ASSUMPTIONS. REVISIONS NOT CHECKED.						
REVISION STATUS		DATE	REPRESENTS REVIEWED AND APPROVED DESIGN, ANY PORTION MARKED "HOLD" REMAINS PRELIMINARY STATUS.						
ORIGINATING PERSONNEL		PROFESSIONAL ENGINEER'S SEAL							
DRAWN BY A. PRATT									
CHECKED BY E. LEIBY									
LEAD DESIGNER A. PRATT									
ENGINEER/TECH SPECIALIST B. ANDERS									
PROJECT ENGINEERING MANAGER B. ANDERS									
PROJECT MANAGER B. PIETRUCHA									
PROJECT SUPERVISOR B. PIETRUCHA									

WorleyParsons
resources & energy

CLIENT/PROJECT TITLE
GENESIS SOLAR LLC
GENESIS SOLAR ENERGY PROJECT

CONCEPTUAL
GRADING PLAN
DRAWING 7 OF 7











SCALE 1"=200' DRAWING SIZE ARCH D (36" x 24")
 WORLEYPARSONS DWG NO. GENI-1-DW-112-716-004-007-1
 FILE NAME: GENI-1-DW-112-716-004-007-1

REFERENCES
 GENI-0-SK-111-002-001, GENERAL ARRANGEMENT, OVERALL SITE PLAN, FIGURE 3.4-1
 GENI-1-DW-112-716-001-001, CONCEPTUAL GRADING PLAN, OVERALL PLAN, SHEET 1 OF 7
 GENI-1-DW-112-716-004-002, CONCEPTUAL GRADING PLAN, SHEET 2 OF 7
 GENI-1-DW-112-716-004-003, CONCEPTUAL GRADING PLAN, SHEET 3 OF 7
 GENI-1-DW-112-716-004-004, CONCEPTUAL GRADING PLAN, SHEET 4 OF 7
 GENI-1-DW-112-716-004-005, CONCEPTUAL GRADING PLAN, SHEET 5 OF 7
 GENI-1-DW-112-716-004-006, CONCEPTUAL GRADING PLAN, SHEET 6 OF 7
 GENI-1-DW-112-726-005-001, CONCEPTUAL GRADING DETAILS AND SECTIONS, SHEET 1 OF 2
 GENI-1-DW-112-726-005-002, CONCEPTUAL GRADING DETAILS AND SECTIONS, SHEET 2 OF 2
 DIVERSION CHANNEL CROSS SECTION SHEETS

MATCHLINE SEE SHEET GENI-1-DW-112-716-004-005

MATCHLINE SEE SHEET GENI-1-DW-112-716-004-006

STA. 0+00 TO STA. 18+00

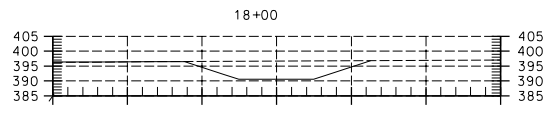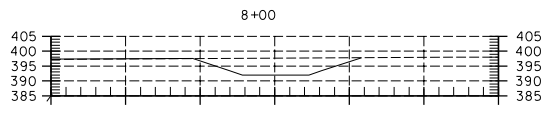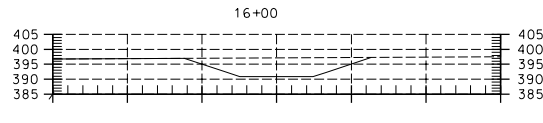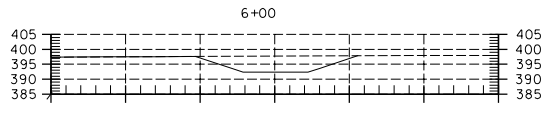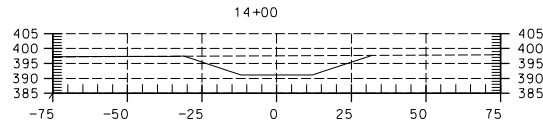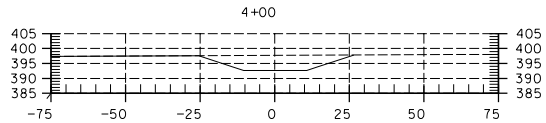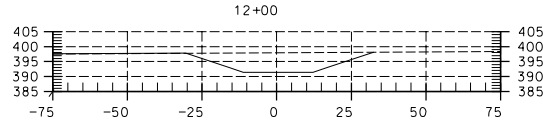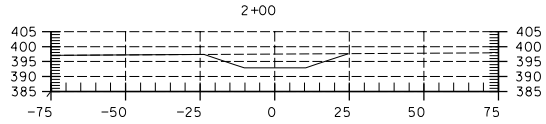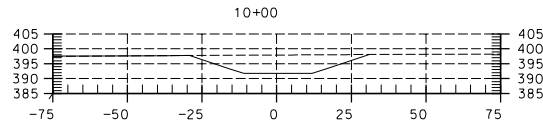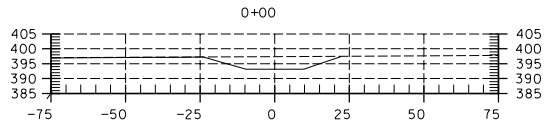


LEGEND:
 ----- EXISTING GRADE
 _____ PROPOSED GRADE

SCALE:
 HORIZ: 1"=20'
 VERT: 1"=20'

REV	DATE	DESCRIPTION	AP	EL	JD	BA	BB	AB	BP
1		ISSUED FOR REVIEW							
CHILLER/RY STATUS DATE REPRESENTS GENERAL DESIGN CONCEPTS BASED ON ASSUMPTIONS. REVIEWS NOT CHECKED.									
REVISION STATUS DATE REPRESENTS REVIEWED AND APPROVED DESIGN. ANY PORTION MARKED "HOLD" RETAINS PRELIMINARY STATUS.									

DRAWN BY: A. PRATT
 CHECKED BY: E. LEIBY
 LEAD DESIGNER: J. DAHLGREN
 ENGINEER/TECH SPECIALIST: B. ANDERS
 PROJECT ENGINEERING MANAGER: B. ANDERS
 PROJECT MANAGER: B. PIETRUCHA

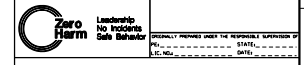











CLIENT/PROJECT TITLE
 GENESIS SOLAR LLC
 GENESIS SOLAR ENERGY PROJECT

CHANNEL A CROSS SECTIONS

SCALE: 1"=20' DRAWING SIZE: ARCH D (36" x 24")
 WORLEYPARSONS DUCT NO. GENI-1-DW-112-716-004-008 REV 1

FILE NAME: GENI-1-DW-112-716-004-008.dgn
 SHEET NUMBER: 112-716-004-008

STA. 20+00 TO STA. 38+00

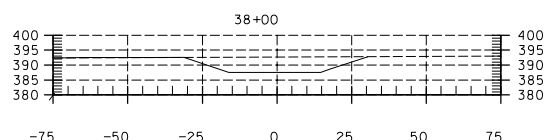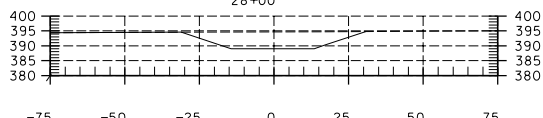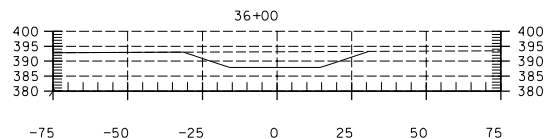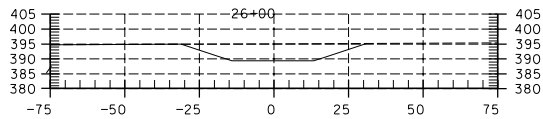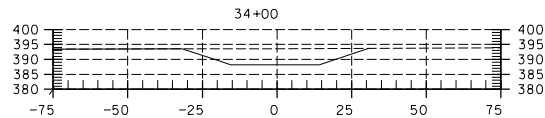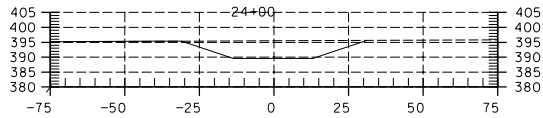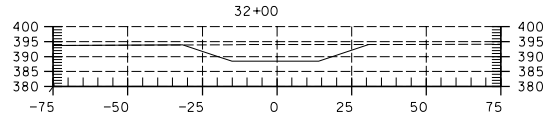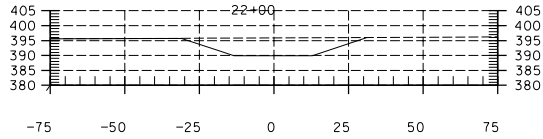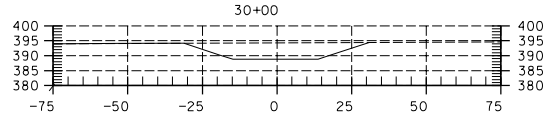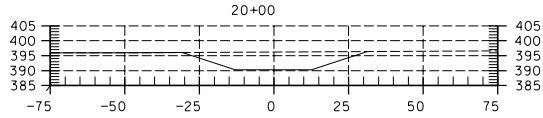

LEGEND:
 - - - - - EXISTING GRADE
 _____ PROPOSED GRADE

SCALE:
 HORIZ: 1"=20'
 VERT: 1"=20'

1	ISSUED FOR REVIEW	AP	EJ	JB	BA	BA	BA	BP
REV	DATE	DESCRIPTION	BY	CHECKED	DATE	DATE	DATE	DATE
PRELIMINARY STATUS		DATE	REPRESENTS GENERAL DESIGN CONCEPTS BASED ON ASSUMPTIONS. REVIEWED, NOT CHECKED.					
REVISION STATUS		DATE	REPRESENTS REVISED AND APPROVED DESIGN. ANY PORTION MARKED "HOLD" REMAINS PRELIMINARY STATUS.					

DRAWN BY A. PRATT CHECKED BY E. LEIBY LEAD DESIGNER J. DAHLGREN ENGINEER/TECH SPECIALIST B. ANDERS PROJECT ENGINEERING MANAGER B. ANDERS PROJECT MANAGER B. PIETRUCHA	PROFESSIONAL ENGINEER'S SEAL
--	----------------------------------

Zero Harm Leadership. No Incidents. Safe Behavior.
 I HEREBY PROMISE UNDER THE RESPONSIBLE SUPERVISION OF THE ABOVE NAMED ENGINEER TO MAINTAIN THE QUALITY AND ACCURACY OF THIS DESIGN.
 DATE: _____













CLIENT/PROJECT TITLE
 GENESIS SOLAR LLC
 GENESIS SOLAR ENERGY PROJECT

CHANNEL A CROSS SECTIONS

SCALE: 1"=20' DRAWING SIZE: ARCH D (36" x 24")
 WORLEYPARSONS DWG. NO.: GENI-1-DW-112-716-004-009 REV: 1

11/14/2010 4:56:15 PM GENI-1-DW-112-716-004-009.dgn

STA. 40+00 TO STA. 58+00

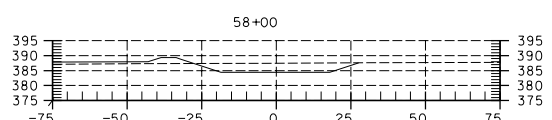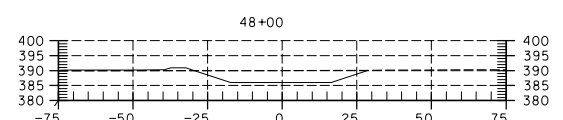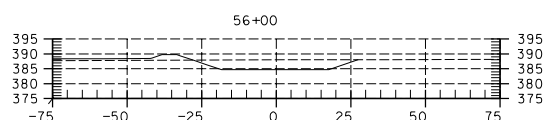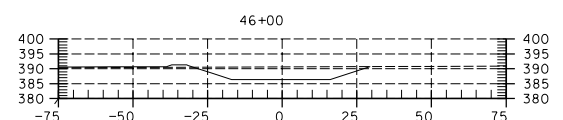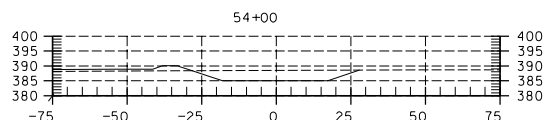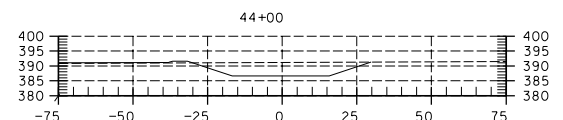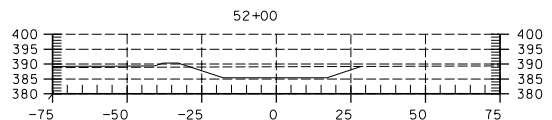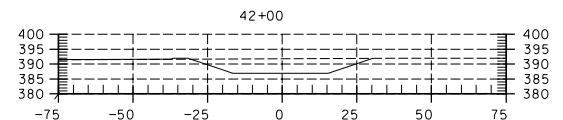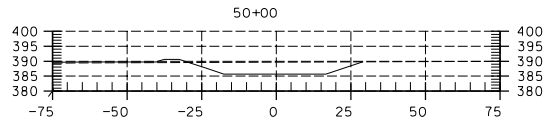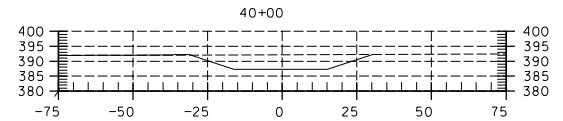

LEGEND:
 - - - - - EXISTING GRADE
 _____ PROPOSED GRADE

SCALE:
 HORIZ: 1"=20'
 VERT: 1"=20'

NO.	DATE	DESCRIPTION	BY	CHECKED
1		ISSUED FOR REVIEW	AP	EL

DRAWN BY A. PRATT CHECKED BY E. LEIBY LEAD DESIGNER J. DAHLGREN ENGINEER/TECH SPECIALIST B. ANDERS PROJECT ENGINEERING MANAGER B. ANDERS PROJECT MANAGER B. PIETRUCHA	PROFESSIONAL ENGINEER'S SEAL _____ _____ _____
--	---

Zero Harm Leadership. No Injuries. Safe Behavior.
 I HAVE FULLY REVIEWED AND APPROVED THIS DESIGN. ANY PORTION MARKED "HOLD" REMAINS PRELIMINARY STATUS.













CLIENT/PROJECT TITLE
 GENESIS SOLAR LLC
 GENESIS SOLAR ENERGY PROJECT

CHANNEL A CROSS SECTIONS

SCALE: 1"=20' DRAWING SIZE: ARCH D (36" x 24")
 WORLEYPARSONS DUCT NO.: GENI-1-DW-112-716-004-010 REV: 1

FILE NAME: GENI-1-DW-112-716-004-010.dgn
 SHEET NUMBER: 1
 TOTAL SHEETS: 1

STA. 60+00 TO STA. 78+00





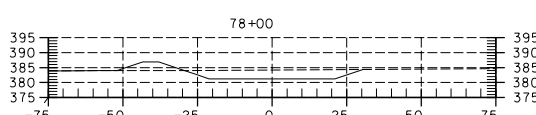
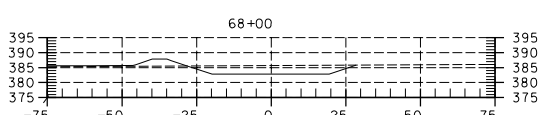
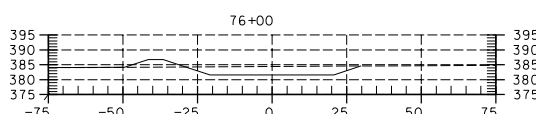
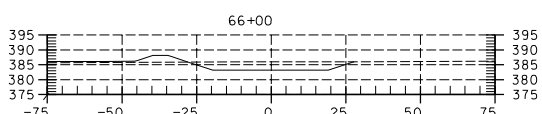
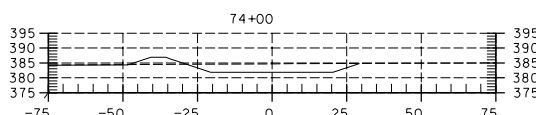
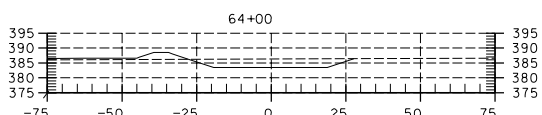
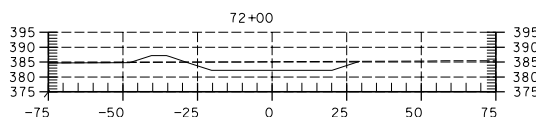
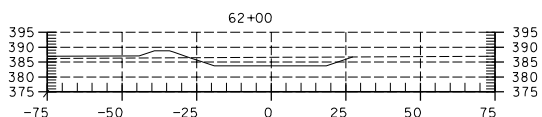
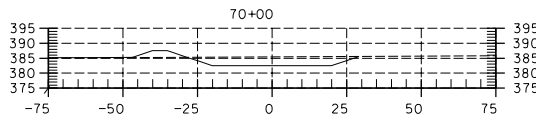
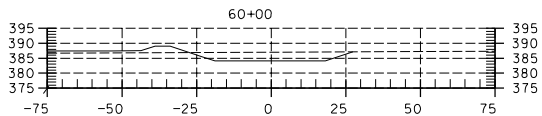


LEGEND:
- - - EXISTING GRADE
— PROPOSED GRADE

SCALE:
HORIZ: 1"=20'
VERT: 1"=20'

APR 1 2010		ISSUED FOR REVIEW				AP	EL	JD	BA	AB	AB	AB	AB	AB	AB	AB	AB	AB
REV	DATE	DESCRIPTION	BY	CHKD	DATE	ISSUED	DESIGNED	CHECKED	DATE	APPROVED	DATE	PROJECT	NO.	REV.	DATE	DESCRIPTION	DATE	
PRELIMINARY STATUS		DATE		REPRESENTS GENERAL DESIGN CONCEPTS BASED ON ASSUMPTIONS. REVIEWED NOT CHECKED.														
REFINED STATUS		DATE		REPRESENTS REVIEWED AND APPROVED DESIGN. ANY PORTION MARKED "HOLD" REMAINS PRELIMINARY STATUS.														
ORIGINATING PERSONNEL		PROFESSIONAL ENGINEER'S SEAL																
DRAWN BY A. PRATT		CHECKED BY E. LEIBY		LEAD DESIGNER J. DAHLGREN		ENGINEER/TECH SPECIALIST B. ANDERS		PROJECT ENGINEERING MANAGER B. ANDERS		PROJECT MANAGER B. PIETRUCHA								
Leadership No Injuries, Safe Behaviors		REVISOR'S NAME		REVISOR'S TITLE		DATE		DATE										
resources & energy		CLIENT/PROJECT TITLE		GENESIS SOLAR LLC GENESIS SOLAR ENERGY PROJECT														
CHANNEL A CROSS SECTIONS		SCALE		DRAWING SIZE		DATE		DATE										
GENI-1-DW-112-716-004-011		1"=20'		ARCH D (36" x 24')		2010.04.11		2010.04.11										

STA. 0+00 TO STA. 26+00

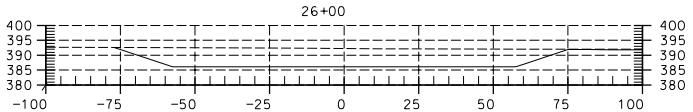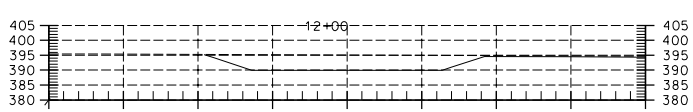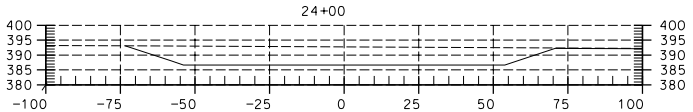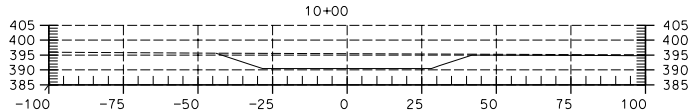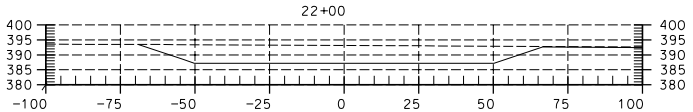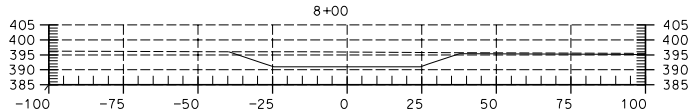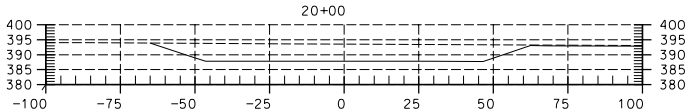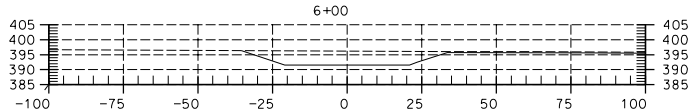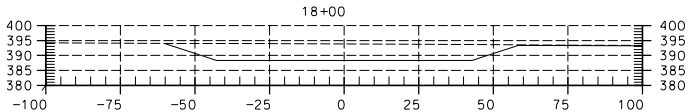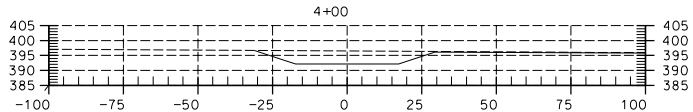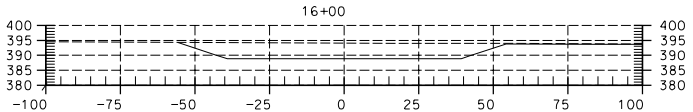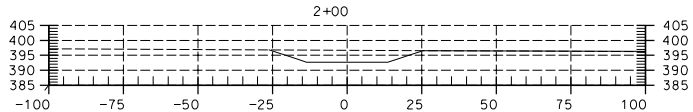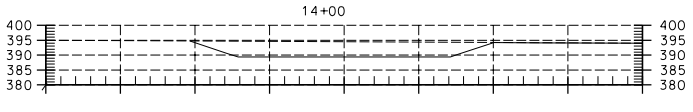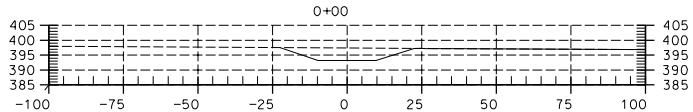


LEGEND:

----- EXISTING GRADE
 _____ PROPOSED GRADE

SCALE:
 HORIZ: 1"=20'
 VERT: 1"=20'

1	ISSUED FOR REVIEW	AP	EL	JB	BA	BA	BP
REV DATE	DESCRIPTION	DATE	BY	CHKD	APPD	DATE	BY
PRELIMINARY STATUS	DATE	REPRESENTS GENERAL DESIGN CONCEPTS BASED ON ASSUMPTIONS. REVISIONS NOT CHECKED.					
FOR REVIEW STATUS	DATE	REPRESENTS REVIEWED AND APPROVED DESIGN. ANY PORTION MARKED "HOLD" REMAINS PRELIMINARY STATUS.					
ORIGINATING PERSONNEL	PROFESSIONAL ENGINEER'S SEAL						

DRAWN BY
A. PRATT
 CHECKED BY
E. LEIBY
 LEAD DESIGNER
J. DAHLGREN
 ENGINEER/TECH SPECIALIST
B. ANDERS
 PROJECT ENGINEERING MANAGER
B. ANDERS
 PROJECT MANAGER
B. PIETRUCHA

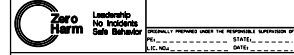

CLIENT/PROJECT TITLE
 GENESIS SOLAR LLC
 GENESIS SOLAR ENERGY PROJECT












CHANNEL B CROSS SECTIONS

SCALE: 1"=20' DRAWING SIZE: ARCH D (36" x 24")
 WORLEYPARSONS DWG NO.: GENI-1-DW-112-716-004-012 REV: 1

A
B
C
D
E
F
G
H

A
B
C
D
E
F
G

STA. 28+00 TO STA. 46+59

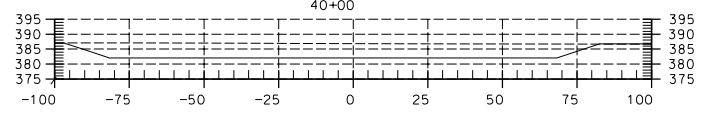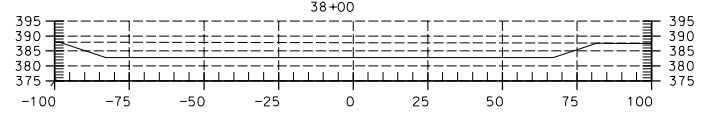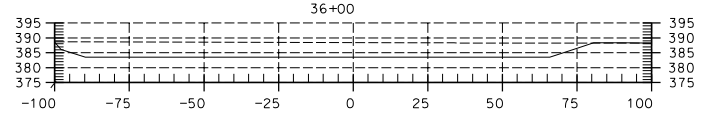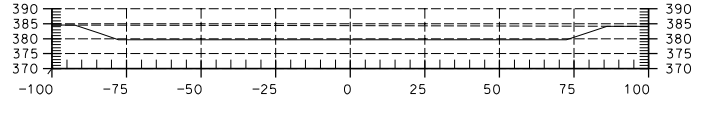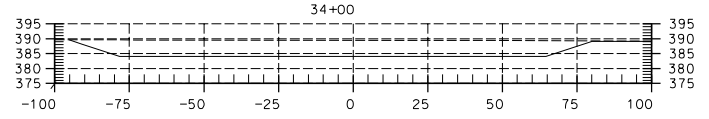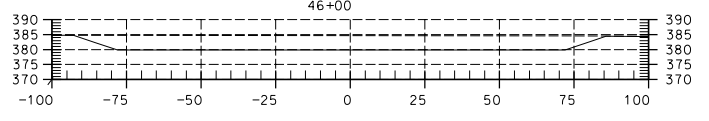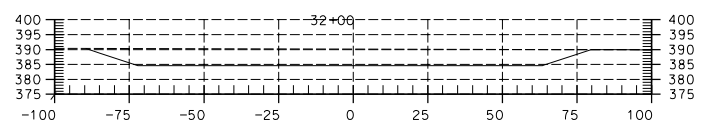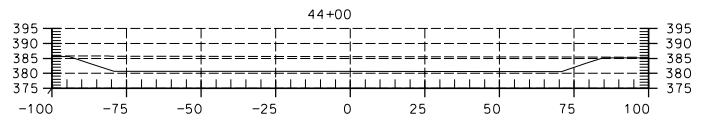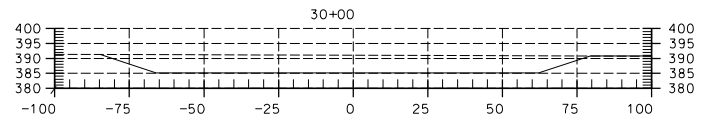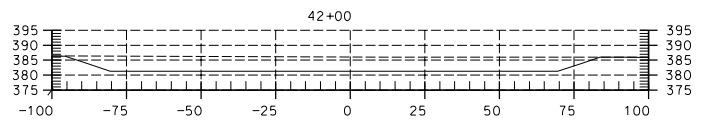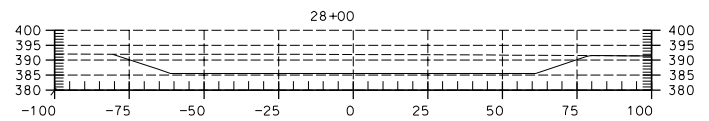

LEGEND:
 - - - - - EXISTING GRADE
 _____ PROPOSED GRADE

SCALE:
 HORIZ: 1"=20'
 VERT: 1"=20'

1	M	ISSUED FOR REVIEW	AP	EL	JO	BA	BA	BA	BP

REV	DATE	DESCRIPTION	DESIGNED	CHECKED	DATE	DATE	DATE	DATE	DATE
<small>REPRESENTS GENERAL DESIGN CONCEPTS BASED ON ASSUMPTIONS. REVISED NOT CHECKED.</small>									
<small>REPRESENTS REVISIONS AND APPROVED DESIGN. ANY PORTION MARKED "HOLD" REMAINS PRELIMINARY STATUS.</small>									

ORIGINATING PERSONNEL	PROFESSIONAL ENGINEER'S SEAL
DRAWN BY A. PRATT CHECKED BY E. LEIBY LEAD DESIGNER J. DAHLGREN ENGINEER/TECH SPECIALIST B. ANDERS PROJECT ENGINEERING MANAGER B. ANDERS PROJECT MANAGER B. PIETRUCHA	(Professional Engineer Seal Area)















Zero Harm Leadership. No Incidents. Safe Behaviors.

CLIENT/PROJECT TITLE
**GENESIS SOLAR LLC
 GENESIS SOLAR ENERGY PROJECT**

CHANNEL B CROSS SECTIONS

SCALE: 1"=20'	DRAWING SIZE: ARCH D (36" x 24")
WORLEYPARSONS DOC# NO: GENTI-1-DW-112-716-004-013	REV: 1

STA. 0+00 TO STA. 26+00

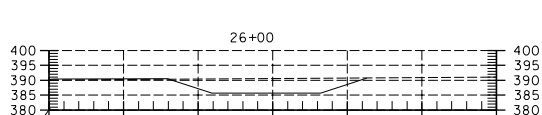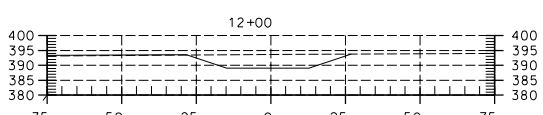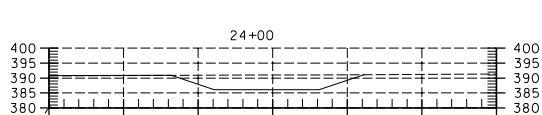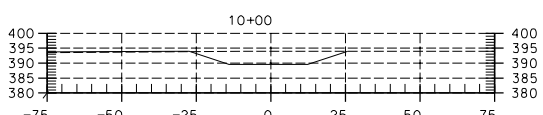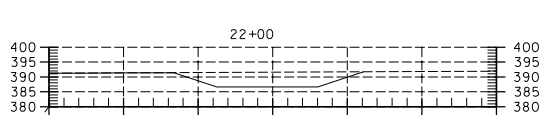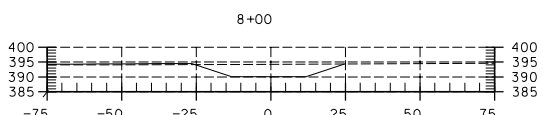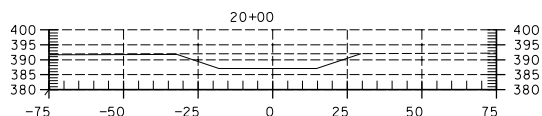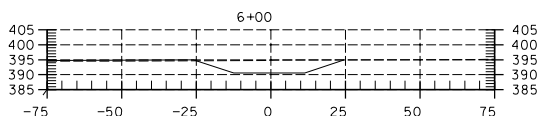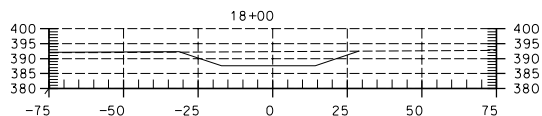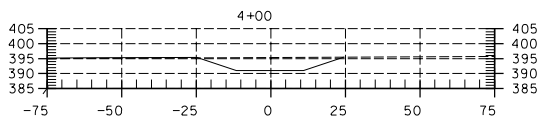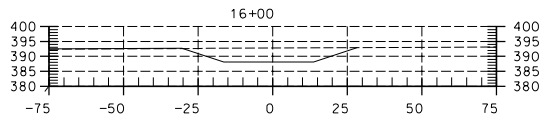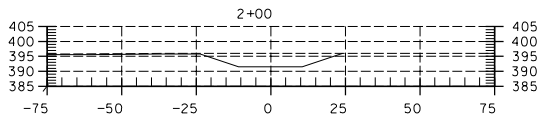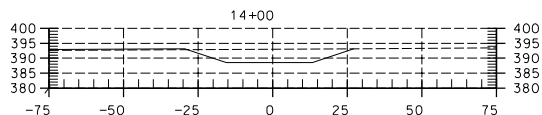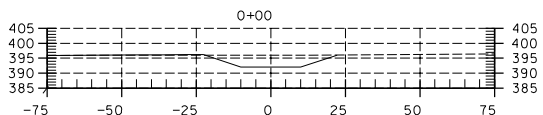


LEGEND:
 ----- EXISTING GRADE
 _____ PROPOSED GRADE

SCALE:
 HORIZ: 1"=20'
 VERT: 1"=20'

REV	DATE	DESCRIPTION	AP	EL	JO	BA	BA	BA	BP
1		ISSUED FOR REVIEW							
PREPARED STATUS DATE REPRESENTS GENERAL DESIGN CONCEPTS BASED ON ASSUMPTIONS. REVIEWED NOT CHECKED.			PROFESSIONAL ENGINEER'S SEAL						
CHECKED STATUS DATE REPRESENTS REVIEWED AND APPROVED DESIGN. ANY PORTION MARKED "HOLD" RETAINS PRELIMINARY STATUS.			DRAWN BY A. PRATT CHECKED BY E. LEIBY LEAD DESIGNER J. DAHLGREN ENGINEER/TECH SPECIALIST B. ANDERS PROJECT ENGINEERING MANAGER B. ANDERS PROJECT MANAGER B. PIETRUCHA						
Leadership No Incidents Safe Behavior			CLIENT/PROJECT TITLE GENESIS SOLAR LLC GENESIS SOLAR ENERGY PROJECT						
CHANNEL C CROSS SECTIONS									
SCALE 1"=20'			DRAWING SIZE ARCH D (36" x 24")						
WORLEYPARSONS DWG. NO. GENI-1-DW-112-716-004-014			REV 1						

STA. 28+00 TO STA. 35+66

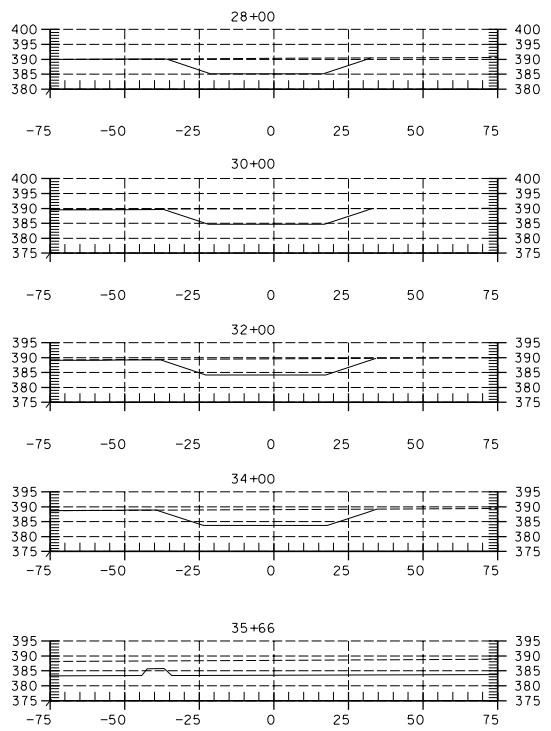















LEGEND:
 ----- EXISTING GRADE
 ————— PROPOSED GRADE

SCALE:
 HORIZ: 1"=20'
 VERT: 1"=20'

REV	DATE	DESCRIPTION	AP	EL	JOB	BA	BA	BA	BA	BA	BA	BA	BA	BA	BA
1		ISSUED FOR REVIEW	AP	EL	JOB	BA	BA	BA	BA	BA	BA	BA	BA	BA	BA
REVISION STATUS		DATE	<small>REPRESENTS GENERAL DESIGN CONCEPTS BASED ON ASSUMPTIONS. REVISIONS NOT CHECKED.</small>												
REVISION STATUS		DATE	<small>REPRESENTS REVIEWED AND APPROVED DESIGN. ANY PORTION MARKED "HOLD" REMAINS PRELIMINARY STATUS.</small>												
DRAWN BY		A. PRATT													
CHECKED BY		E. LEIBY													
LEAD DESIGNER		J. DAHLGREN													
ENGINEER/TECH SPECIALIST		B. ANDERS													
PROJECT ENGINEERING MANAGER		B. ANDERS													
PROJECT MANAGER		B. PIETRUCHA													
		<small>Leadership. No Incidents. Safe Behavior.</small>													
		<small>resources & energy</small>													
CLIENT/PROJECT TITLE		GENESIS SOLAR LLC GENESIS SOLAR ENERGY PROJECT													
SCALE		1"=20'													
DRAWING SIZE		ARCH D (36" x 24')													
WORLEYPARSONS DUC NO.		GENI-1-DW-112-716-004-015													
FILE NAME		GENI-1-DW-112-716-004-015													
REV		1													

112716004015
 ARCH D (36" x 24")
 GENI-1-DW-112-716-004-015

STA. 0+00 TO STA. 26+00

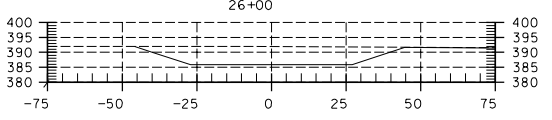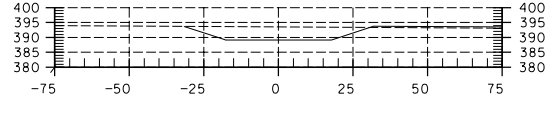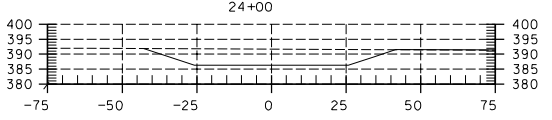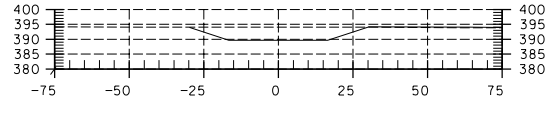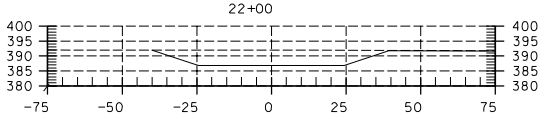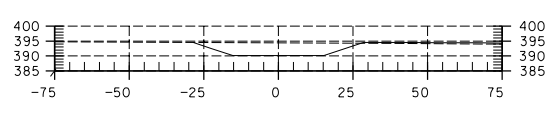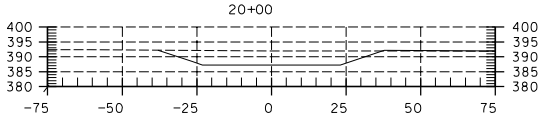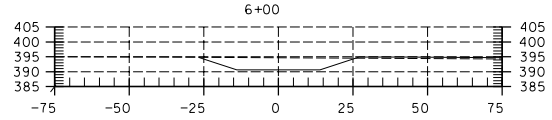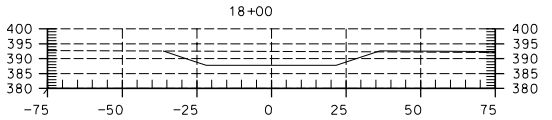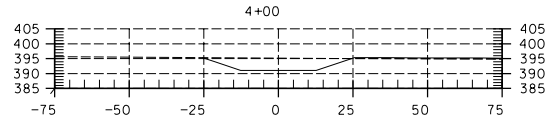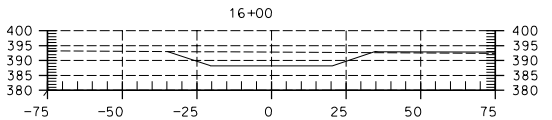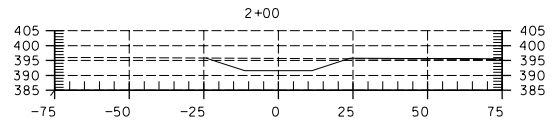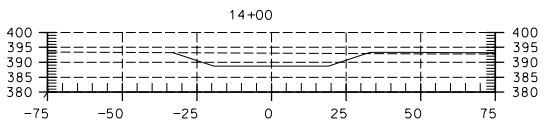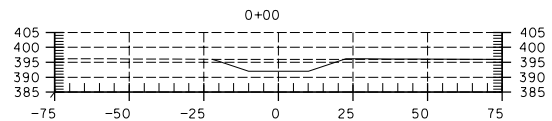

LEGEND:
 ----- EXISTING GRADE
 _____ PROPOSED GRADE

SCALE:
 HORIZ: 1"=20'
 VERT: 1"=20'

REV	DATE	DESCRIPTION	AP	EL	JD	BA	AB	AB	AB	AB
1		ISSUED FOR REVIEW								
REVISION STATUS		DATE	REPRESENTS GENERAL DESIGN CONCEPTS BASED ON ASSUMPTIONS. REVISIONS NOT CHECKED.							
REVISION STATUS		DATE	REPRESENTS REVIEWED AND APPROVED DESIGN. ANY PORTION MARKED "HOLD" RETAINS PRELIMINARY STATUS.							
ORIGINATING PERSONNEL		PROFESSIONAL ENGINEER'S SEAL								

DRAWN BY
A. PRATT
 CHECKED BY
E. LEIBY
 LEAD DESIGNER
J. DAHLGREN
 ENGINEER/TECH SPECIALIST
B. ANDERS
 PROJECT ENGINEERING MANAGER
B. ANDERS
 PROJECT MANAGER
B. PIETRUCHA

















CLIENT/PROJECT TITLE
 GENESIS SOLAR LLC
 GENESIS SOLAR ENERGY PROJECT

CHANNEL D CROSS SECTIONS

SCALE 1"=20' DRAWING SIZE ARCH D (36" x 24")
 WORLEYPARSONS DWG. NO. GENI-1-DW-112-716-004-016 REV 1

GENI-1-DW-112-716-004-016-001

STA. 28+00 TO STA. 54+00

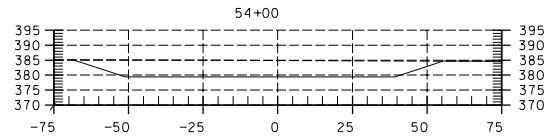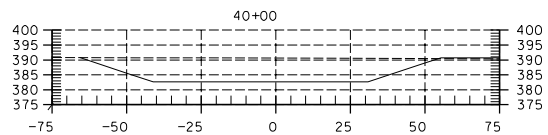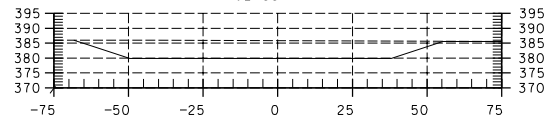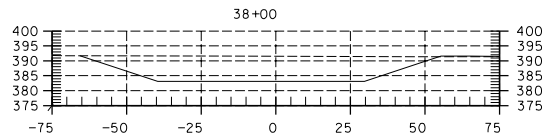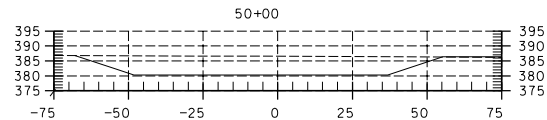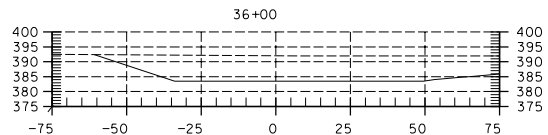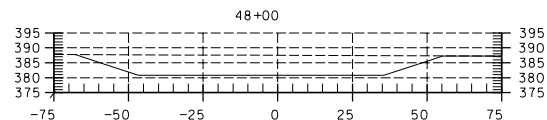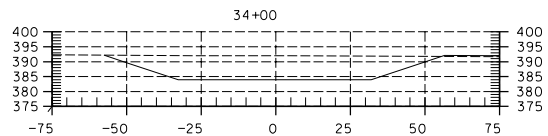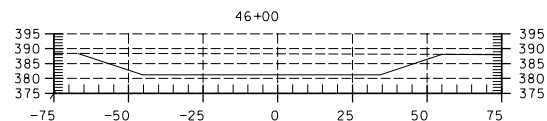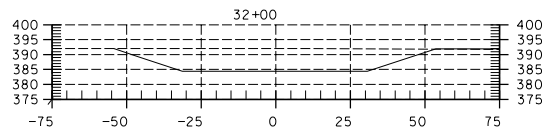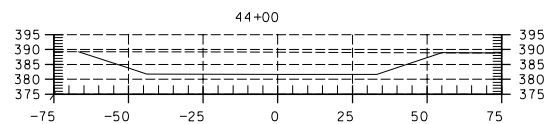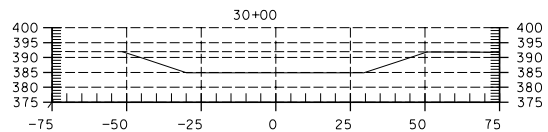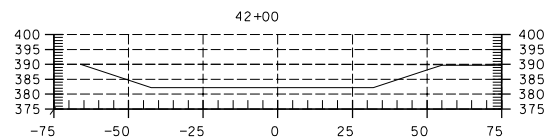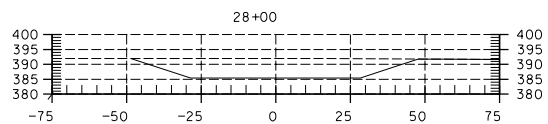









LEGEND:

- EXISTING GRADE
- PROPOSED GRADE

SCALE:
HORIZ: 1"=20'
VERT: 1"=20'

1	ISSUED FOR REVIEW	AP	EL	JD	BA	BA	BA	BP
REV	DATE	DESCRIPTION	PROJECT	DESIGN	CONSTRUCTION	OPERATION	MAINTENANCE	PROJECT
PRELIMINARY STATUS		DATE	REPRESENTS GENERAL DESIGN CONCEPTS BASED ON ASSUMPTIONS. REVISIONS NOT CHECKED.					
REVISION STATUS		DATE	REPRESENTS REVISIONS AND APPROVED DESIGN. ANY PORTION MARKED "HOLD" REMAINS PRELIMINARY STATUS.					
DRAWING PERSONNEL			PROFESSIONAL ENGINEER'S SEAL					
DRAWN BY A. PRATT								
CHECKED BY E. LEIBY								
LEAD DESIGNER J. DAHLGREN								
ENGINEER/TECH SPECIALIST B. ANDERS								
PROJECT ENGINEERING MANAGER B. ANDERS								
PROJECT MANAGER B. PIETRUCHA								
			I HEREBY PROMISE UNDER THE RESPONSIBLE SUPERVISOR OF NO. _____ DATE _____ (SEE INSTRUCTIONS)					
			CLIENT/PROJECT TITLE GENESIS SOLAR LLC GENESIS SOLAR ENERGY PROJECT					
CHANNEL D CROSS SECTIONS								
SCALE 1"=20'			DRAWING SIZE ARCH D (36" x 24')					
WORLEYPARSONS DWG. NO. GENT-1-DW-112-716-004-017			REV			1		

STA. 0+00 TO STA. 13+18

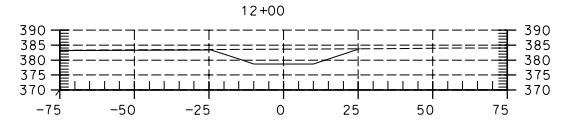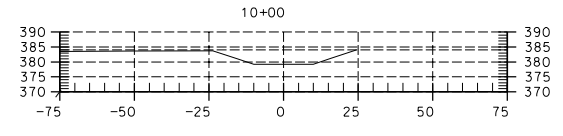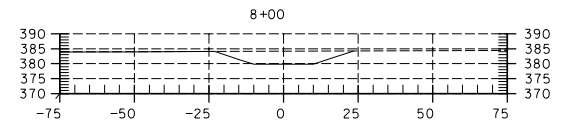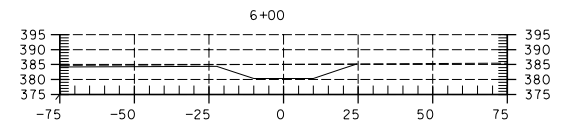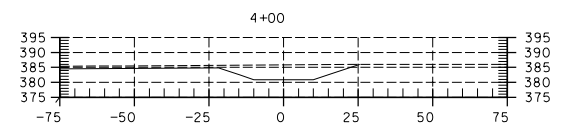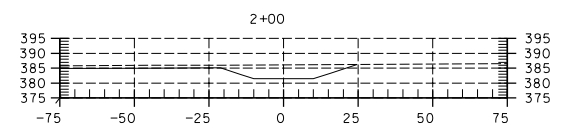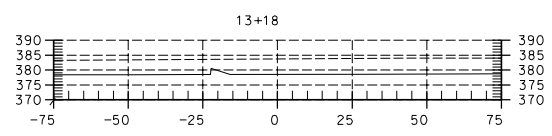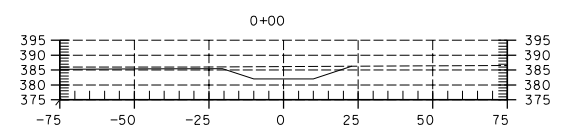

LEGEND:
 - - - - - EXISTING GRADE
 _____ PROPOSED GRADE

SCALE:
 HORIZ: 1"=20'
 VERT: 1"=20'

REV	DATE	DESCRIPTION	AP	EL	J	B	B	A	B	A	B	A	B	A	B	A	B
1		ISSUED FOR REVIEW															
REVISION STATUS			DATE			REPRESENTS GENERAL DESIGN CONCEPTS BASED ON ASSUMPTIONS. REVISED, NOT CHECKED.			DATE			REPRESENTS REVIEWED AND APPROVED DESIGN. ANY PORTION MARKED "HOLD" REMAINS PRELIMINARY STATUS.					
DRAWN BY			A. PRATT			CHECKED BY			E. LEIBY			LEAD DESIGNER			J. DAHLGREN		
ENGINEER/TECH SPECIALIST			B. ANDERS			PROJECT ENGINEERING MANAGER			B. ANDERS			PROJECT MANAGER			B. PIETRUCHA		

Zero Harm Leadership. No Injuries. Safe Behaviors.

REVISITATION PERIOD: _____

NO. _____ DATE: _____

WorleyParsons
 resources & energy

CLIENT/PROJECT TITLE
 GENESIS SOLAR LLC
 GENESIS SOLAR ENERGY PROJECT


CHANNEL E CROSS SECTIONS

SCALE	1"=20'	DRAWING SIZE	ARCH D (36" x 24")
FILE NAME	GEN1-1-DW-112-716-004-019	REV	1

A

A

STA. 0+00 TO STA. 8+00

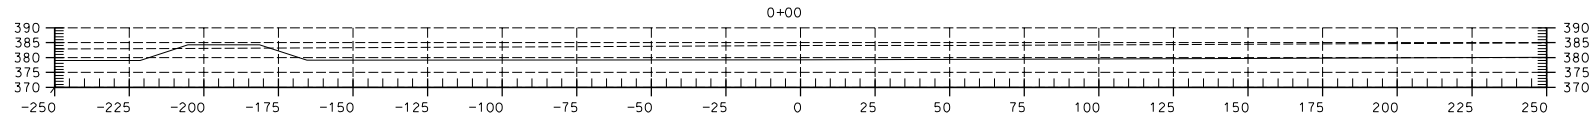


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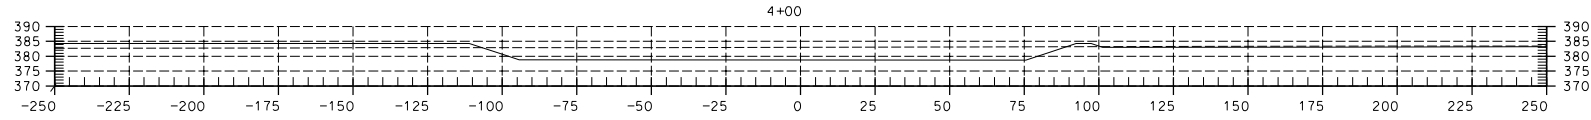
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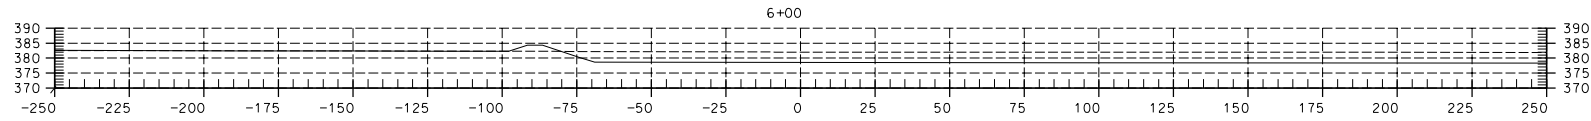
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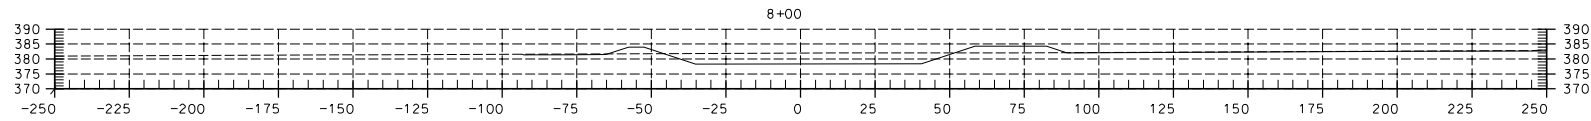
E

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G

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H

LEGEND:
 - - - - - EXISTING GRADE
 ——— PROPOSED GRADE

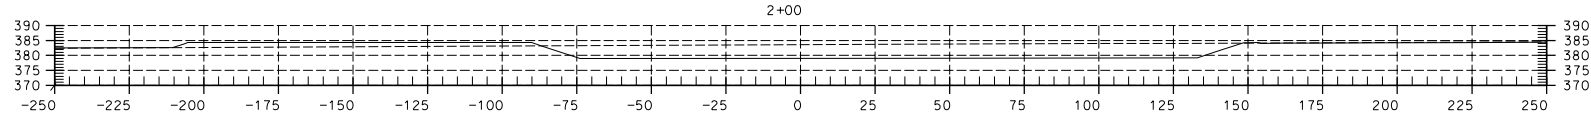SCALE:
 HORIZ: 1"=20'
 VERT: 1"=20'

1	ISSUED FOR REVIEW	APEL	JOB	BAB	BAB	BAB	BAB	BAB	BAB	BAB
REV	DATE	DESCRIPTION	BY	CHKD	APPD	DATE	DATE	DATE	DATE	DATE

PREPARED STATUS DATE <small>REPRESENTS GENERAL DESIGN CONCEPTS BASED ON ASSUMPTIONS. REVIEWS NOT CHECKED.</small>	
LDR DATE <small>REPRESENTS REVIEWED AND APPROVED DESIGN. ANY PORTION MARKED "HOLD" RETAINS PRELIMINARY STATUS.</small>	
ORIGINATING PERSONNEL DRAWN BY: A. PRATT CHECKED BY: E. LEIBY LEAD DESIGNER: J. DAHLGREN ENGINEER/TECH SPECIALIST: B. ANDERS PROJECT ENGINEERING MANAGER: B. ANDERS PROJECT MANAGER: B. PIETRUCHA	PROFESSIONAL ENGINEER'S SEAL



WorleyParsons
resources & energy

CLIENT/PROJECT TITLE
GENESIS SOLAR LLC
GENESIS SOLAR ENERGY PROJECT

CHANNEL B/C CROSS SECTIONS

SCALE: 1"=20' DRAWING SIZE: ARCH D (36" x 24")
 WORLEYPARSONS DWG NO.: GENI-1-DW-112-716-004-020






FILE NAME: GENI-1-DW-112-716-004-020.dgn
 SHEET NO.: 1
 TOTAL SHEETS: 1

10 9 8 7 6 5 4 3 2 1

A
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STA. 10+00 TO STA. 18+00



LEGEND:
 ----- EXISTING GRADE
 _____ PROPOSED GRADE

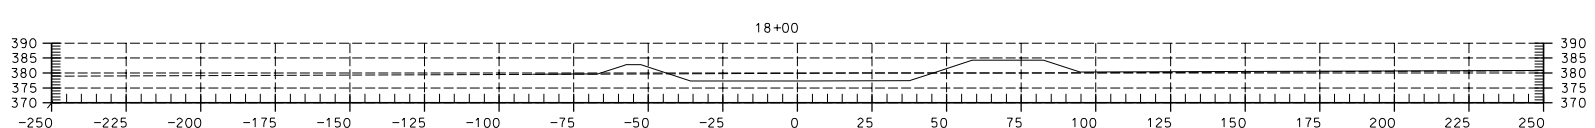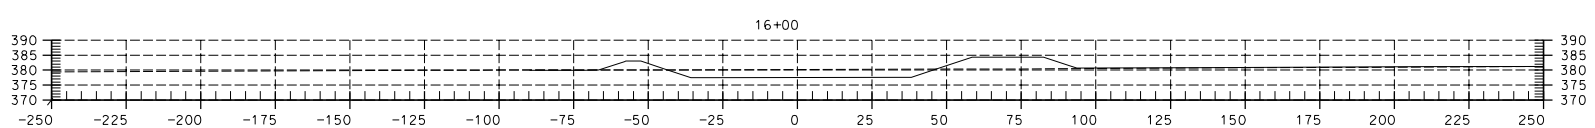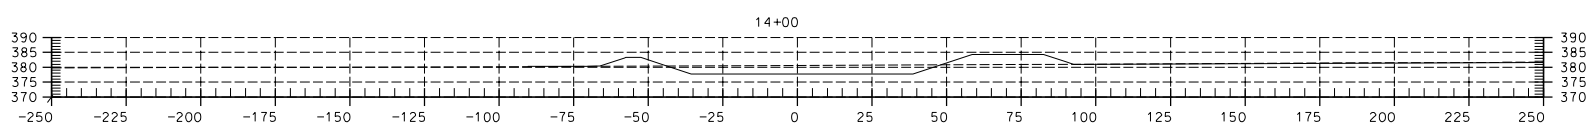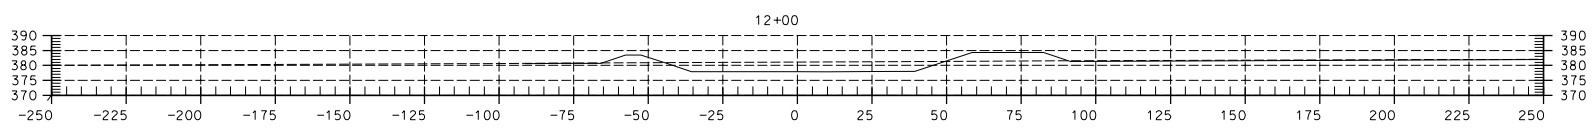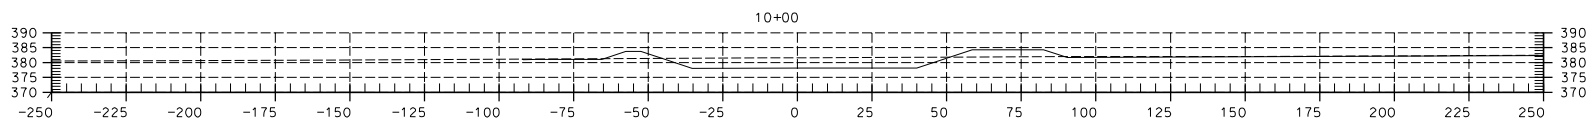 SCALE:
 HORIZ: 1"=20'
 VERT: 1"=20'

1	ISSUED FOR REVIEW	AP	EJ	JO	BA	BB	AB	BP
REV	DATE	DESCRIPTION	BY	CHECKED	DATE	BY	CHECKED	DATE

DESIGN STATUS: DATE: REPRESENTS GENERAL DESIGN CONCEPTS BASED ON ASSUMPTIONS. REVIEWED: NOT CHECKED.
 REVISION STATUS: DATE: REPRESENTS REVISED AND APPROVED DESIGN. ANY PORTION MARKED "HOLD" REMAINS PRELIMINARY STATUS.

DRAWN BY: A. PRATT
 CHECKED BY: E. LEIBY
 LEAD DESIGNER: J. DAHLGREN
 ENGINEER/TECH SPECIALIST: B. ANDERS
 PROJECT ENGINEERING MANAGER: B. ANDERS
 PROJECT MANAGER: B. PIETRUCHA

Zero Harm Leadership. No Incidents. Safe Behaviors.
 I PROMISE TO... RESPONSIBLY PROVIDE UNDER THE RESPONSIBLE SUPERVISOR BY: NO. DATE: DATE:



CLIENT/PROJECT TITLE:
 GENESIS SOLAR LLC
 GENESIS SOLAR ENERGY PROJECT

CHANNEL B/C CROSS SECTIONS

SCALE: 1"=20' DRAWING SIZE: ARCH D (36" x 24")
 FILE NAME: GEN1-1-DW-112-716-004-021 REV: 1

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GENESIS SOLAR ENERGY PROJECT


A

A

STA. 40+00 TO STA. 48+00

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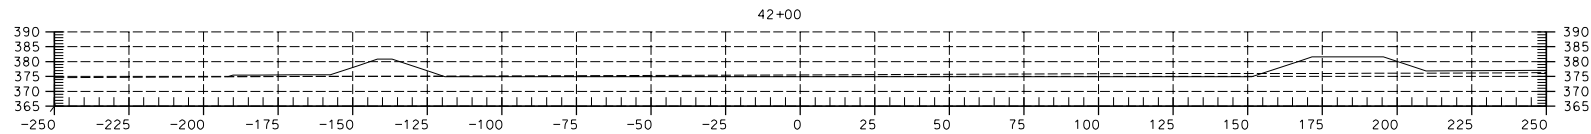
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LEGEND:
 ----- EXISTING GRADE
 ————— PROPOSED GRADE

SCALE:
 HORIZ: 1"=20'
 VERT: 1"=20'

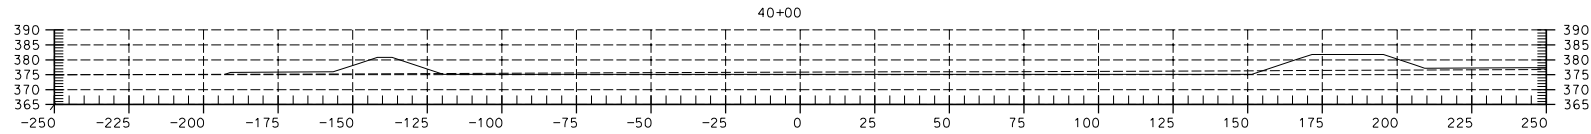
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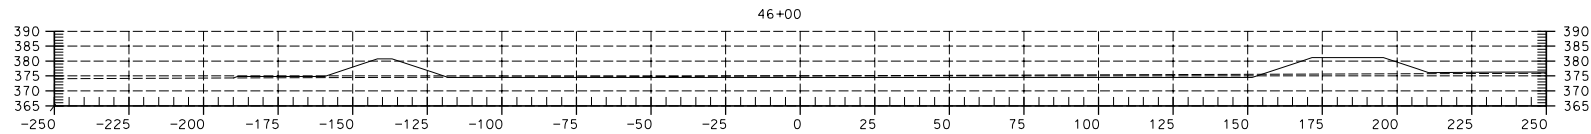
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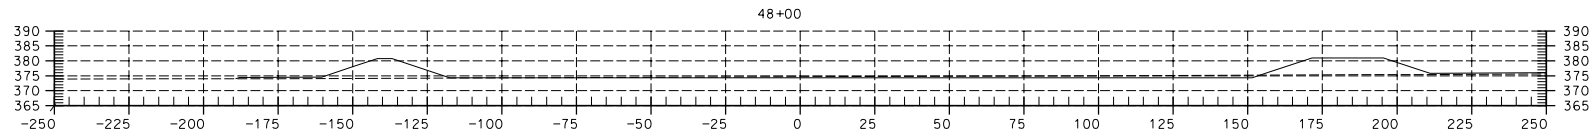
F

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REV	DATE	DESCRIPTION	AP	EL	JO	BA	BA	BP
1		ISSUED FOR REVIEW	AP	EL	JO	BA	BA	BP

DRAWING STATUS DATE REPRESENTS GENERAL DESIGN CONCEPTS BASED ON ASSUMPTIONS. REVISIONS NOT CHECKED.	PROFESSIONAL ENGINEER'S SEAL DATE REPRESENTS REVIEWED AND APPROVED DESIGN. ANY PORTION MARKED "HOLD" RETAINS PRELIMINARY STATUS.
DRAWN BY A. PRATT	PROFESSIONAL ENGINEER'S SEAL DATE REPRESENTS REVIEWED AND APPROVED DESIGN. ANY PORTION MARKED "HOLD" RETAINS PRELIMINARY STATUS.
CHECKED BY E. LEIBY	
LEAD DESIGNER J. DAHLGREN	
ENGINEER/TECH SPECIALIST B. ANDERS	
PROJECT ENGINEERING MANAGER B. ANDERS	
PROJECT MANAGER B. PIETRUCHA	



CLIENT/PROJECT TITLE
 GENESIS SOLAR LLC
 GENESIS SOLAR ENERGY PROJECT

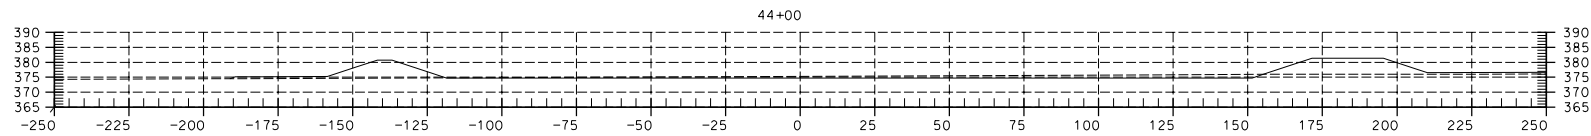CHANNEL B/C CROSS SECTIONS


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FILE NAME: GEN1-1-DW-112-716-004-024	REV 1

GEN1-1-DW-112-716-004-024.dgn
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A

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STA. 50+00 TO STA. 50+68




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C
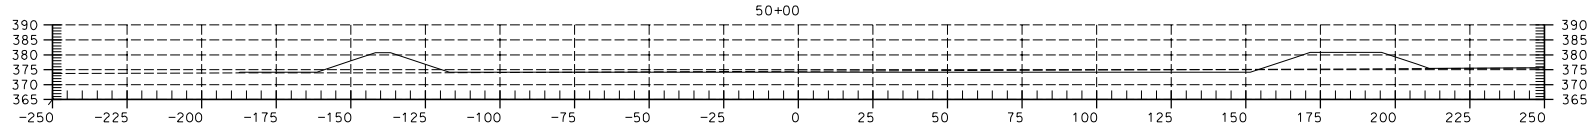
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D

LEGEND:
 - - - - - EXISTING GRADE
 _____ PROPOSED GRADE
 SCALE:
 HORIZ: 1"=20'
 VERT: 1"=20'

1	ISSUED FOR REVIEW	AP	EJ	JB	BA	BA	BA	BP
REV	DATE	DESCRIPTION	BY	CHKD	APPD	DATE	PROJECT	STATUS
DATE	DATE	DATE	DATE	DATE	DATE	DATE	DATE	DATE
DATE	DATE	DATE	DATE	DATE	DATE	DATE	DATE	DATE

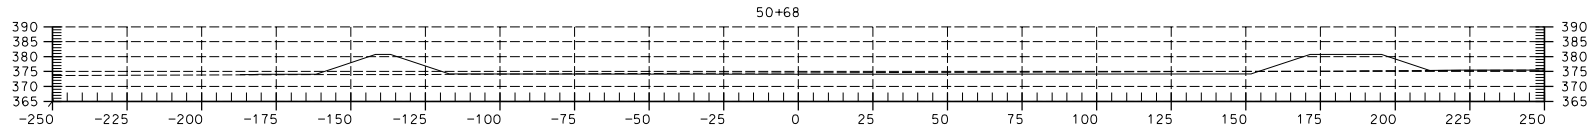E

E

DRAWN BY A. PRATT CHECKED BY E. LEIBY LEAD DESIGNER J. DAHLGREN ENGINEER/TECH SPECIALIST B. ANDERS PROJECT ENGINEERING MANAGER B. ANDERS PROJECT MANAGER B. PIETRUCHA	PROFESSIONAL ENGINEER'S SEAL NO HARM LEADERSHIP NO INCIDENTS SAFE BEHAVIOR
--	--

F

F

CLIENT/PROJECT TITLE
 GENESIS SOLAR LLC
 GENESIS SOLAR ENERGY PROJECT

G

G






CHANNEL B/C CROSS SECTIONS

H

H

SCALE	1"=20'	DRAWING SIZE	ARCH D (36" x 24")
WORLDWIDE PROJECT NO.	GENI-1-DW-112-716-004-025	REV	1

STA. 0+00 TO STA. 8+00

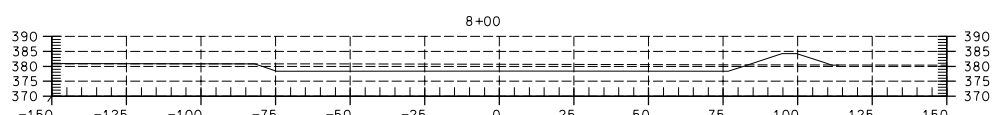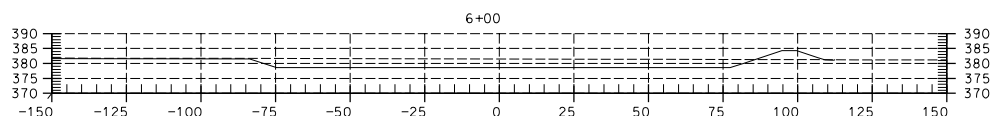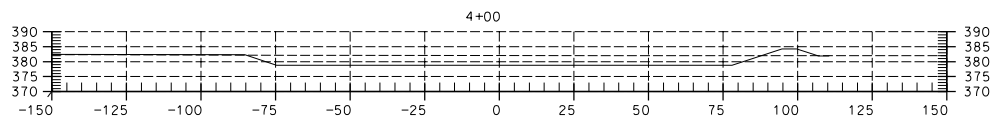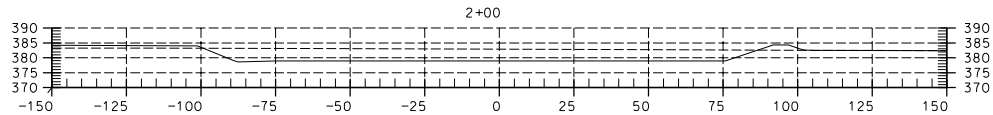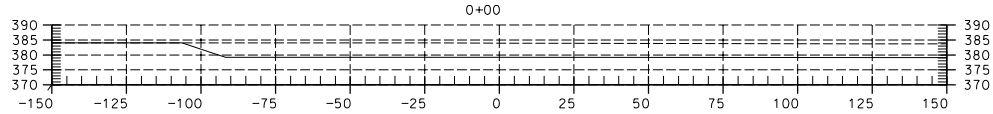

LEGEND:
 ----- EXISTING GRADE
 _____ PROPOSED GRADE

SCALE:
 HORIZ: 1"=20'
 VERT: 1"=20'

REV	DATE	DESCRIPTION	AP	EL	JD	BA	BA	BA	BA	BA	BA	BA	BA	BA	BA
1		ISSUED FOR REVIEW													

DRAWN BY A. PRATT	PROFESSIONAL ENGINEER'S SEAL
CHECKED BY E. LEIBY	
LEAD DESIGNER J. DAHLGREN	
ENGINEER/TECH SPECIALIST B. ANDERS	
PROJECT ENGINEERING MANAGER B. ANDERS	
PROJECT MANAGER B. PIETRUCHA	






Zero Harm Leadership: No Incidents, Safe Behaviors
 I HEREBY PROMISE UNDER THE RESPONSIBLE SUPERVISION OF
 NO. _____ DATE: _____
 I.E. NO. _____

WorleyParsons
 resources & energy
 CLIENT/PROJECT TITLE
 GENESIS SOLAR LLC
 GENESIS SOLAR ENERGY PROJECT

CHANNEL B/C-2 CROSS SECTIONS

SCALE: 1"=20' DRAWING SIZE: ARCH D (36" x 24")
 WORLEYPARSONS DUCR NO. GENI-1-DW-112-716-004-026 REV 1

STA. 10+00 TO STA. 17+86

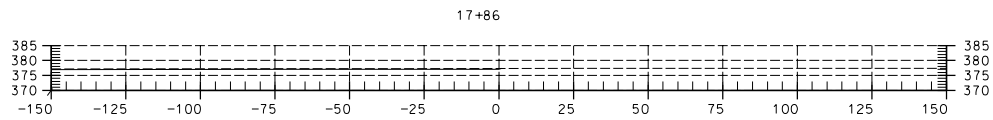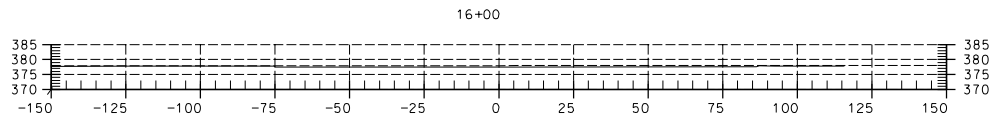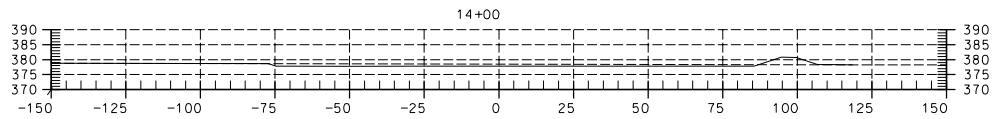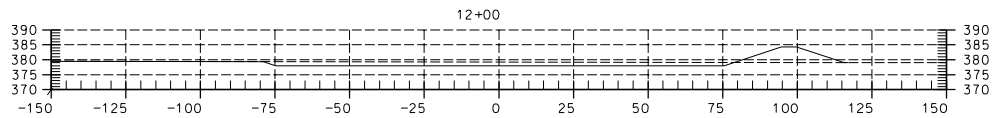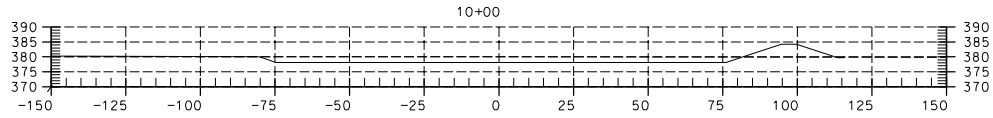

LEGEND:

----- EXISTING GRADE

———— PROPOSED GRADE

SCALE:

HORIZ: 1"=20'

VERT: 1"=20'

NO.	DATE	DESCRIPTION	BY	CHECKED	IN CHARGE
1	1/13/10	ISSUED FOR REVIEW	APEL	JOB	BABABBP
DESIGNER		CHECKER		IN CHARGE	
DESIGNER		CHECKER		IN CHARGE	
ORIGINATING PERSONNEL	PROFESSIONAL ENGINEER'S SEAL
DRAWN BY A. PRATT	
CHECKED BY E. LEIBY	
LEAD DESIGNER J. DAHLGREN	
ENGINEER/TECH SPECIALIST B. ANDERS	
PROJECT ENGINEERING MANAGER B. ANDERS	
PROJECT MANAGER B. PIETRUCHA	
REPRESENTS GENERAL DESIGN CONCEPTS BASED ON ASSUMPTIONS. REVIEWS NOT CHECKED.	
REPRESENTS REVIEWED AND APPROVED DESIGN. ANY PORTION MARKED "HOLD" RETAINS PRELIMINARY STATUS.	

Zero Harm Leadership No Incidents Safe Behaviors

REPRESENTS REVIEWED AND APPROVED DESIGN. ANY PORTION MARKED "HOLD" RETAINS PRELIMINARY STATUS.

NO. _____ DATE _____

WorleyParsons
resources & energy

CLIENT/PROJECT TITLE

GENESIS SOLAR LLC
GENESIS SOLAR ENERGY PROJECT

CHANNEL B/C CROSS SECTIONS


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WORLEYPARSONS DWG NO. GENI-1-DW-112-716-004-027 REV 1


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STA. 0+00 TO STA. 8+00


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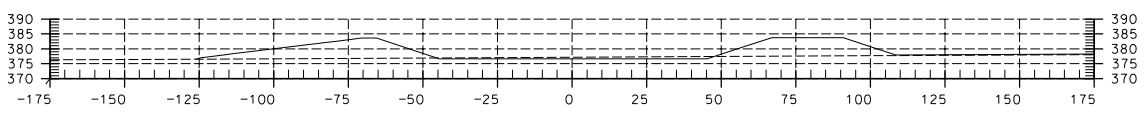
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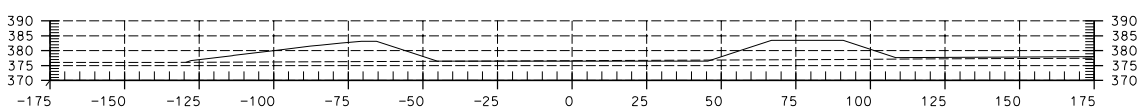
4+00



6+00

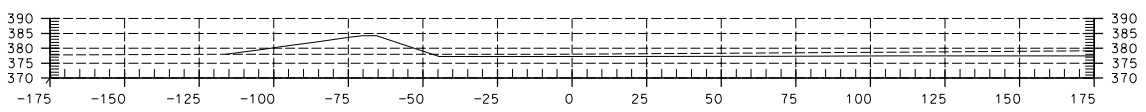

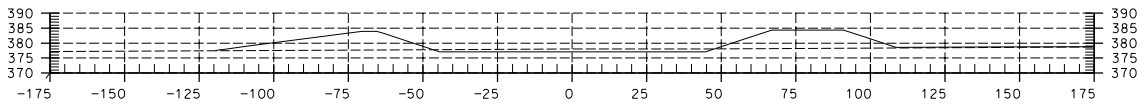8+00

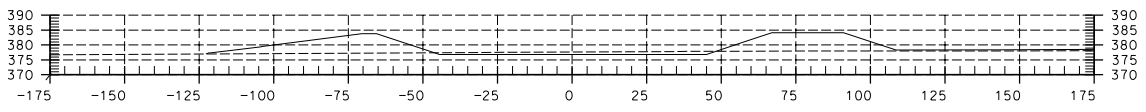

LEGEND:
 ----- EXISTING GRADE
 _____ PROPOSED GRADE

SCALE:
 HORIZ: 1"=20'
 VERT: 1"=20'

REV	DATE	DESCRIPTION	AP	EL	JO	BA	BB	BA	BB	AP	EL	JO	BA	BB	BA	BB
1		ISSUED FOR REVIEW														

CHALLENGE STATUS DATE REPRESENTS GENERAL DESIGN CONCEPTS BASED ON ASSUMPTIONS. REVISED, NOT CHECKED.

DEFERRED STATUS DATE REPRESENTS REVIEWED AND APPROVED DESIGN, ANY PORTION MARKED "HOLD" REMAINS PRELIMINARY STATUS.

DRAWN BY
A. PRATT

CHECKED BY
E. LEIBY

LEAD DESIGNER
J. DAHLGREN

ENGINEER/TECH SPECIALIST
B. ANDERS

PROJECT ENGINEERING MANAGER
B. ANDERS

PROJECT MANAGER
B. PIETRUCHA

PROFESSIONAL ENGINEER'S SEAL








CLIENT/PROJECT TITLE
 GENESIS SOLAR LLC
 GENESIS SOLAR ENERGY PROJECT

CHANNEL D/E CROSS SECTIONS

SCALE: 1"=20' DRAWING SIZE: ARCH D (36" x 24")
 WORLEYPARSONS DWG NO.: GENI-1-DW-112-716-004-028 REV: 1

 11/14/2010 5:08:16 PM

STA. 20+00 TO STA. 28+00

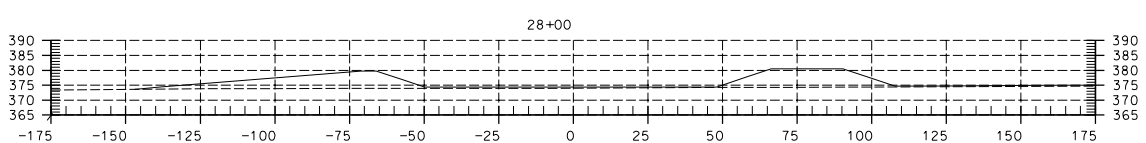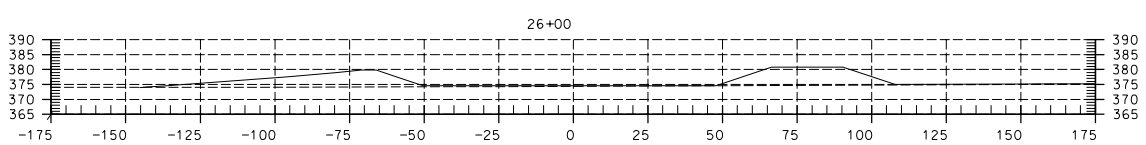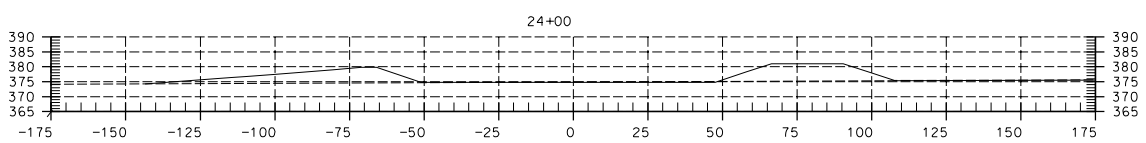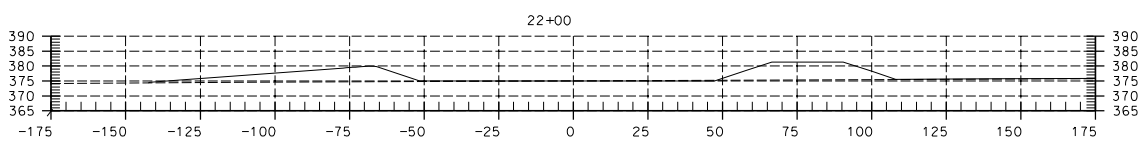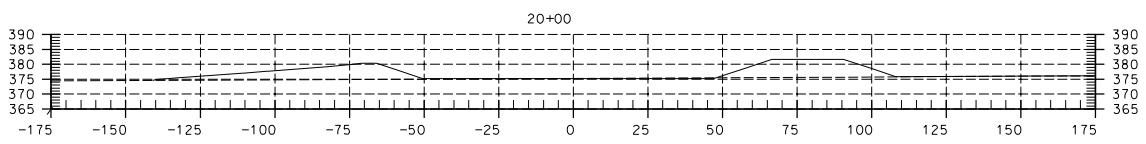

LEGEND:
 ----- EXISTING GRADE
 _____ PROPOSED GRADE

SCALE:
 HORIZ: 1"=20'
 VERT: 1"=20'

REV	DATE	DESCRIPTION	AP	EL	UD	BA	BA	BA	BA	BA	BA
1		ISSUED FOR REVIEW	A	P	E	L	U	B	A	B	A

DRAWN BY
A. PRATT


CHECKED BY
E. LEIBY

LEAD DESIGNER
J. DAHLGREN

ENGINEER/TECH SPECIALIST
B. ANDERS

PROJECT ENGINEERING MANAGER
B. ANDERS

PROJECT MANAGER
B. PIETRUCHA

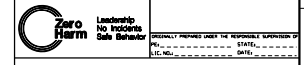

CLIENT/PROJECT TITLE
 GENESIS SOLAR LLC
 GENESIS SOLAR ENERGY PROJECT

CHANNEL D/E CROSS SECTIONS

SCALE: 1"=20' DRAWING SIZE: ARCH D (36" x 24")
 FILE NAME: GEN1-1-DW-112-716-004-030 REV: 1

A

B

C

D




E

F

G

H

STA. 30+00 TO STA. 32+66

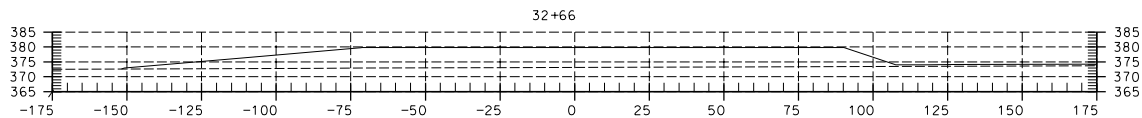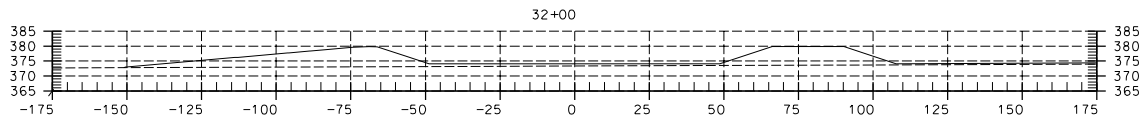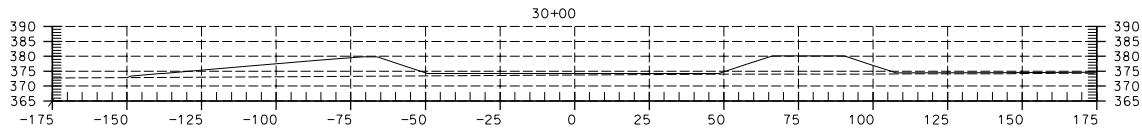

LEGEND:

----- EXISTING GRADE
 ————— PROPOSED GRADE

SCALE:
 HORIZ: 1"=20'
 VERT: 1"=20'

1		ISSUED FOR REVIEW		AP	EL	JO	BA	BA	BA	BP
REV	DATE	DESCRIPTION		ISSUED FOR REVIEW	FOR CONSTRUCTION	FOR RECORD	FOR AS-BUILT	FOR CONSTRUCTION	FOR RECORD	FOR AS-BUILT
REVISION STATUS	DATE	REPRESENTS GENERAL DESIGN CONCEPTS BASED ON ASSUMPTIONS. REVISED, NOT CHECKED.								
DATE										
DATE										
DATE										
DATE										

ORIGINATING PERSONNEL

PROFESSIONAL ENGINEER'S SEAL

DRAWN BY
A. PRATT

CHECKED BY
E. LEIBY

LEAD DESIGNER
J. DAHLGREN

ENGINEER/TECH SPECIALIST
B. ANDERS

PROJECT ENGINEERING MANAGER
B. ANDERS

PROJECT MANAGER
B. PIETRUCHA

Zero Harm

Leadership. No Incidents. Safe Behaviors.

REPRESENTATIVE REVIEWED UNDER THE RESPONSIBLE SUPERVISOR OF:

NO. _____ DATE: _____

NO. _____ DATE: _____



CLIENT/PROJECT TITLE

GENESIS SOLAR LLC
 GENESIS SOLAR ENERGY PROJECT



CHANNEL D/E CROSS SECTIONS

SCALE
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WORLEYPARSONS Dwg. NO. GENI-1-DW-112-716-004-031 REV 1

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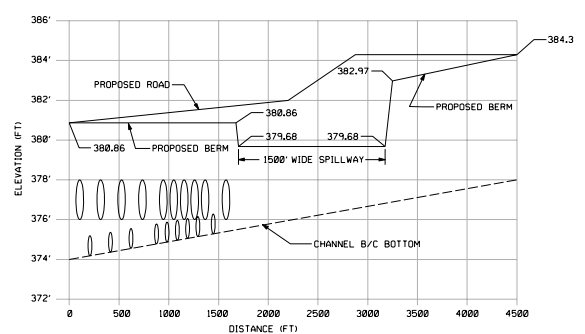
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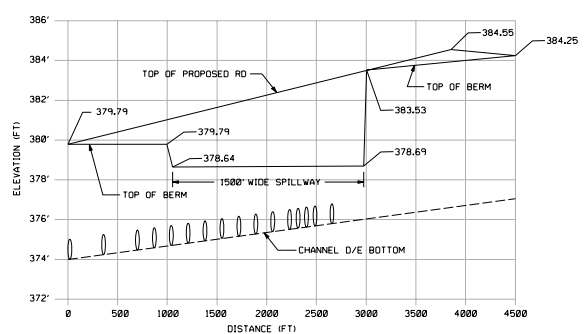
SECTION 1-1
NOT TO SCALE

ENERGY DISSIPATOR
DETAIL A
NOT TO SCALE

- REFERENCES:
- GENI-0-SK-111-002-001, GENERAL ARRANGEMENT, OVERALL SITE PLAN, FIGURE 3.4-1
 - GENI-1-DW-112-716-004-001, CONCEPTUAL GRADING PLAN, OVERALL PLAN, SHEET 1 OF 7
 - GENI-1-DW-112-716-004-003, CONCEPTUAL GRADING PLAN, SHEET 3 OF 7
 - GENI-1-DW-112-716-004-004, CONCEPTUAL GRADING PLAN, SHEET 4 OF 7
 - GENI-1-DW-112-716-004-005, CONCEPTUAL GRADING PLAN, SHEET 5 OF 7
 - GENI-1-DW-112-716-004-006, CONCEPTUAL GRADING PLAN, SHEET 6 OF 7
 - GENI-1-DW-112-716-004-007, CONCEPTUAL GRADING PLAN, SHEET 7 OF 7
 - GENI-1-DW-112-726-005-002, CONCEPTUAL GRADING DETAILS AND SECTIONS, SHEET 2 OF 2 DIVERSION CHANNEL CROSS SECTION SHEETS

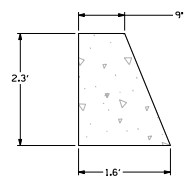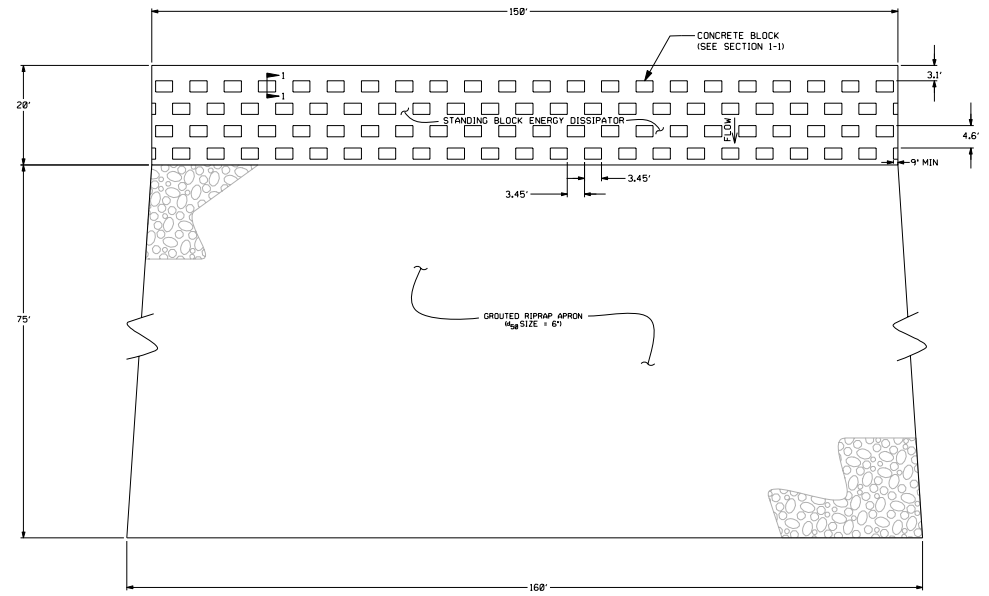


CHANNEL B/C
ELEVATION PROFILE 1-1



CHANNEL D/E
ELEVATION PROFILE 2-2

REV	DATE	DESCRIPTION	AP	EL	JO	BA	BA	BA	BA
1		ISSUED FOR REVIEW							

DESIGNED BY	A. PRATT	CHECKED BY	E. LEIBY
LEAD DESIGNER	J. DAHLGREN	ENGINEER/TECH SPECIALIST	B. ANDERS
PROJECT ENGINEERING MANAGER	B. ANDERS	PROJECT MANAGER	B. PIETRUCHA

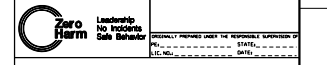


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GENESIS SOLAR ENERGY PROJECT


CONCEPTUAL
GRADING PLAN DETAILS AND SECTIONS
DRAWING 1 OF 2

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FILE NAME: GENI-1-DW-112-726-005-001 REV: 1


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SECTION 1-1
SCALE: NTS

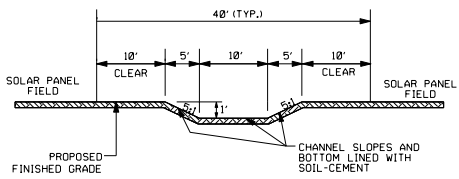

SECTION 2-2
SCALE: NTS

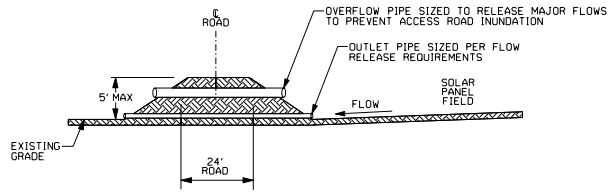

SECTION 3-3
SCALE: NTS

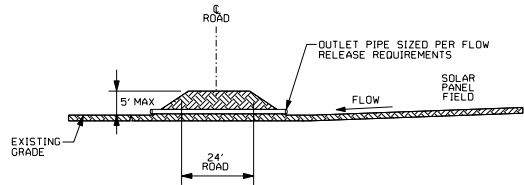REFERENCES:

- GENI-0-SK-111-002-001, GENERAL ARRANGEMENT, OVERALL SITE PLAN, FIGURE 3.4-1
- GENI-1-DW-112-716-004-001, CONCEPTUAL GRADING PLAN, OVERALL PLAN, SHEET 1 OF 7
- GENI-1-DW-112-716-004-003, CONCEPTUAL GRADING PLAN, SHEET 3 OF 7
- GENI-1-DW-112-716-004-004, CONCEPTUAL GRADING PLAN, SHEET 4 OF 7
- GENI-1-DW-112-716-004-005, CONCEPTUAL GRADING PLAN, SHEET 5 OF 7
- GENI-1-DW-112-716-004-006, CONCEPTUAL GRADING PLAN, SHEET 6 OF 7
- GENI-1-DW-112-716-004-007, CONCEPTUAL GRADING PLAN, SHEET 7 OF 7
- GENI-1-DW-112-726-005-001, CONCEPTUAL GRADING DETAILS AND SECTIONS, SHEET 1 OF 2
- DIVERSION CHANNEL CROSS SECTION SHEETS

2	ISSUED FOR REVIEW	J	J	J	J	J	J	B	B	A	A	A	A	A	A	A	A	A
1	N/A																	

REV	DATE	DESCRIPTION	ISSUED FOR REVIEW	FOR COMMENTS	FOR RECORD	FOR APPROVAL	FOR AS-BUILT
1		N/A					

CHLORUM STATUS DATE REPRESENTS GENERAL DESIGN CONCEPTS BASED ON ASSUMPTIONS. REVISED NOT CHECKED.

REVISION STATUS DATE REPRESENTS REVIEWED AND APPROVED DESIGN. ANY PORTION MARKED "HOLD" REMAINS PRELIMINARY STATUS.

DATE _____ **BY** _____

Drawn by: J. DAHLGREN
Checked by: J. DAHLGREN
Lead Designer: J. DAHLGREN
Engineer/Tech Specialist: J. BRAVO
Project Engineering Manager: J. BRAVO
Project Manager: B. PIETRUCHA

WorleyParsons
resources & energy

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CONCEPTUAL
GRADING PLAN SECTIONS
DRAWING 2 OF 2

SCALE: NOT TO SCALE DRAWING SIZE: ARCH D (36" x 24")

FILE NAME: GENI-1-DW-112-726-005-002 REV: 1