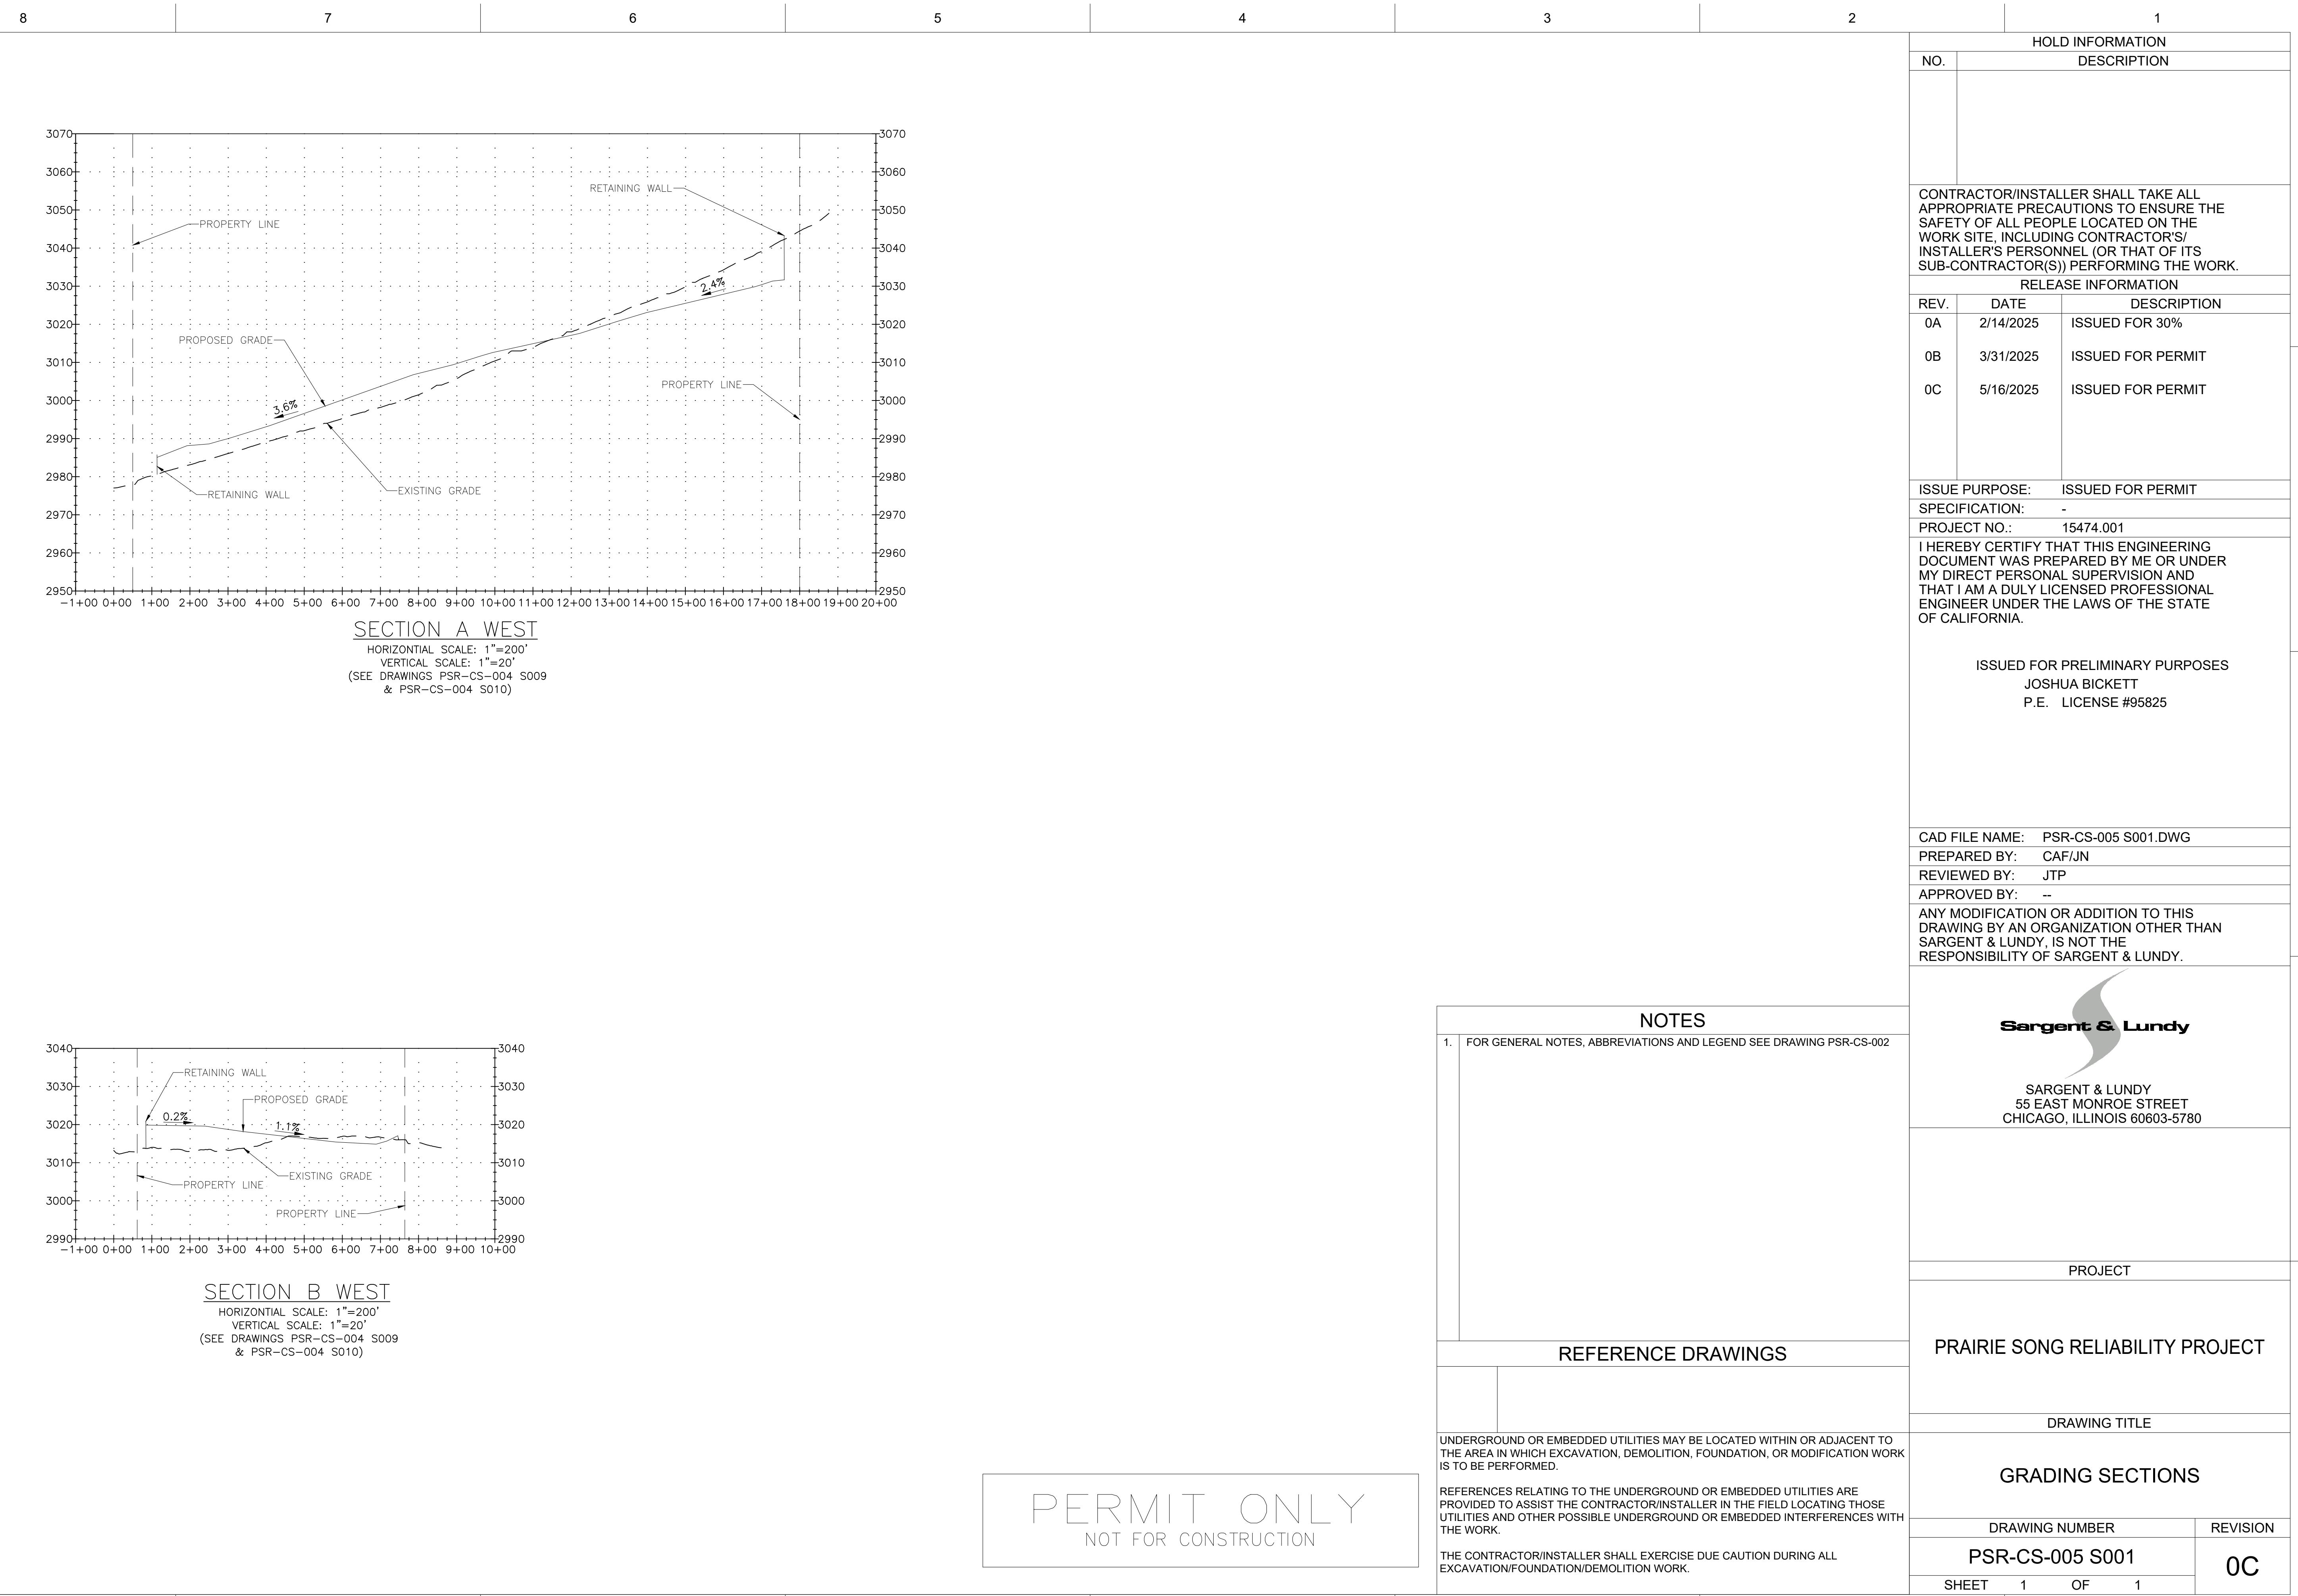
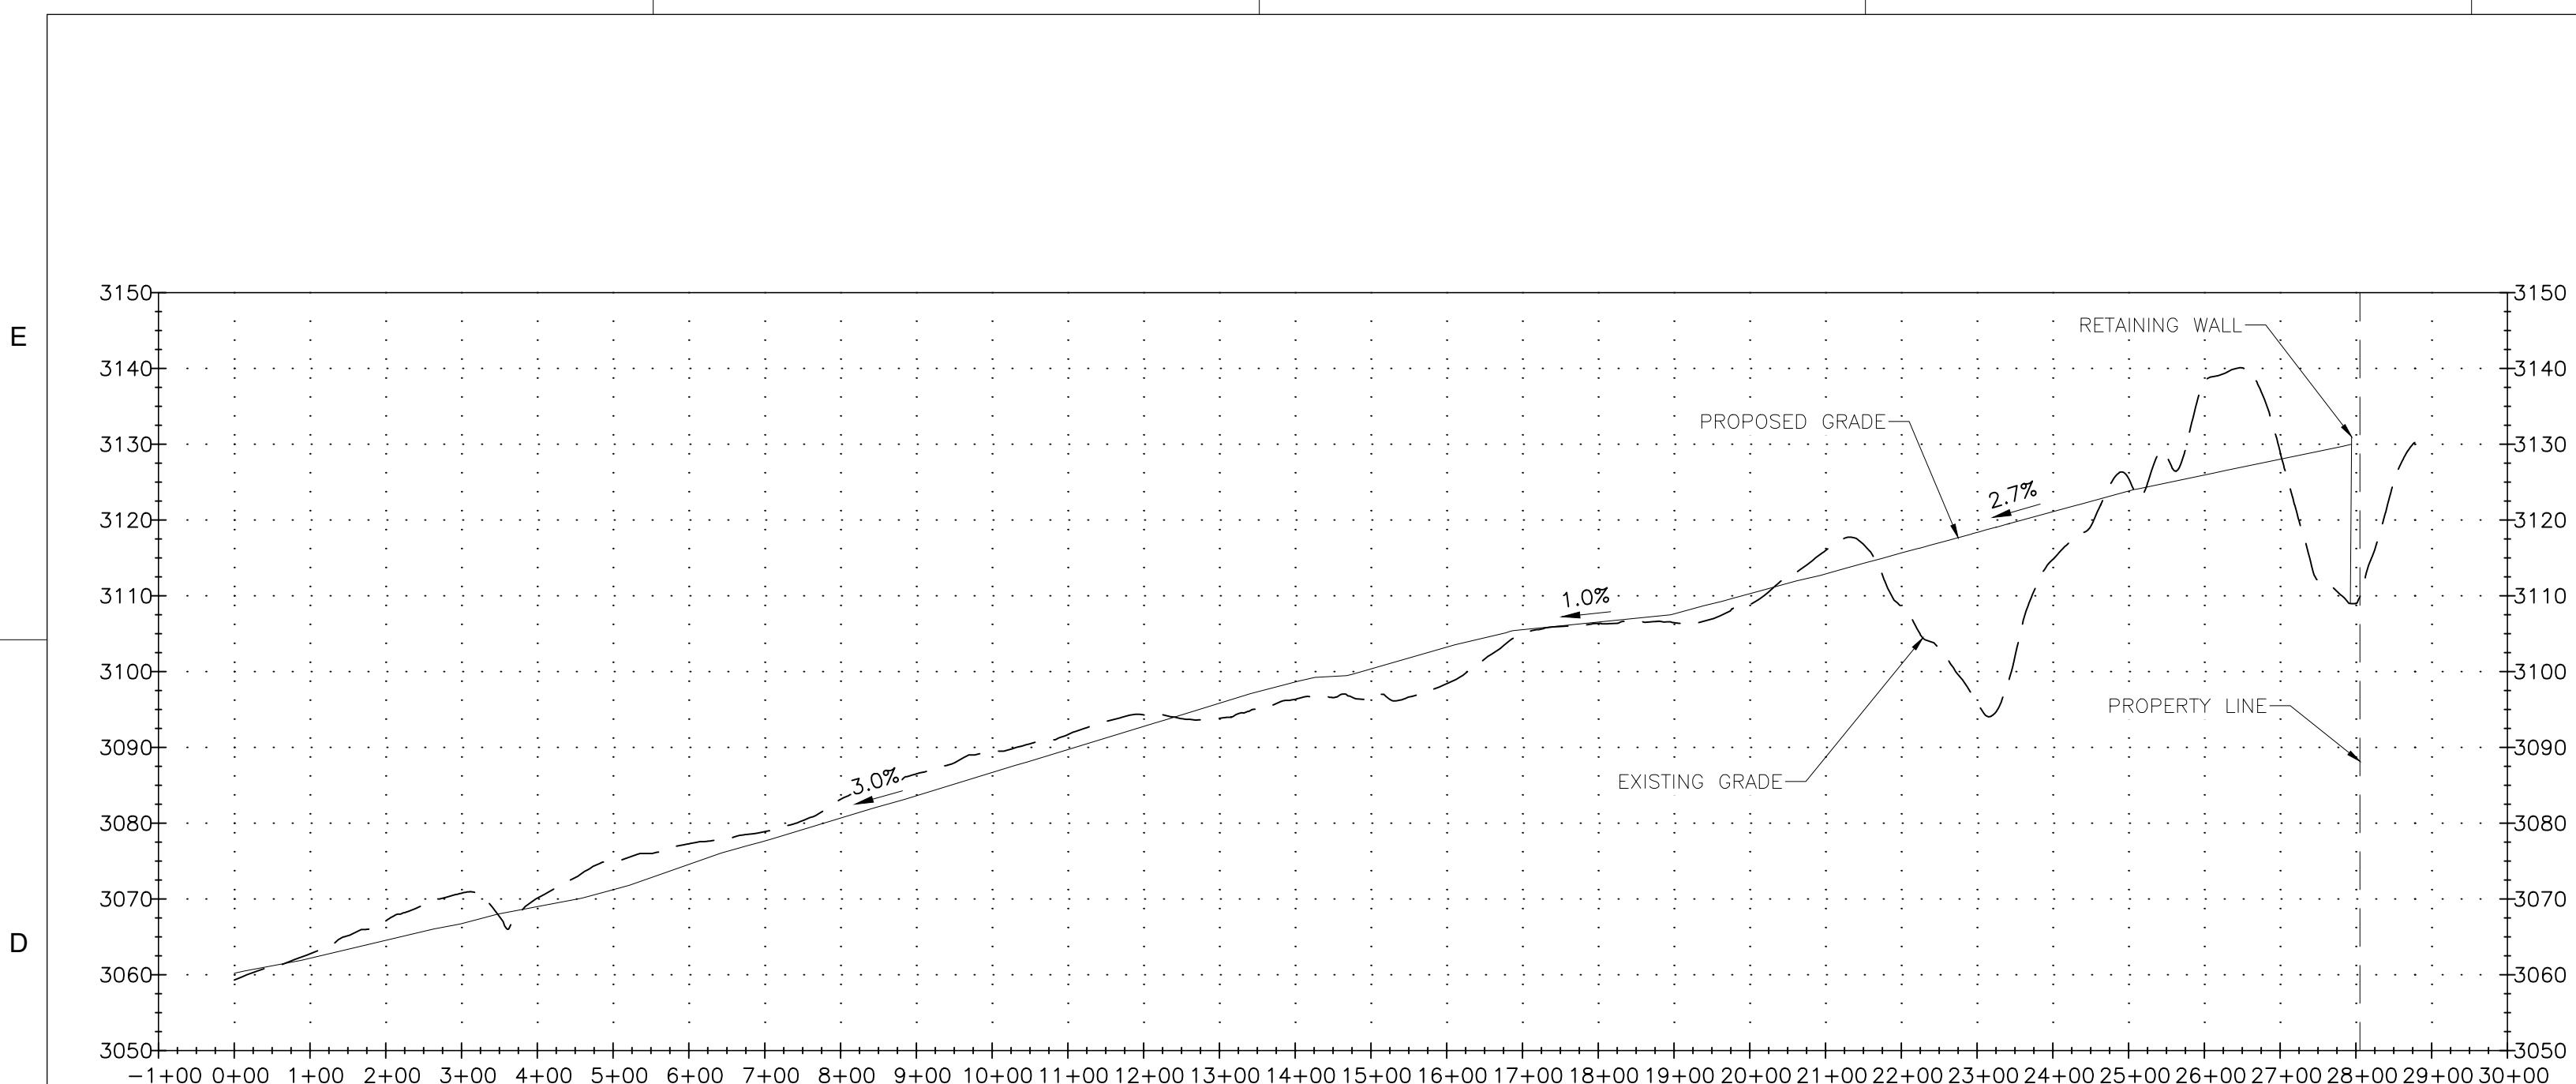


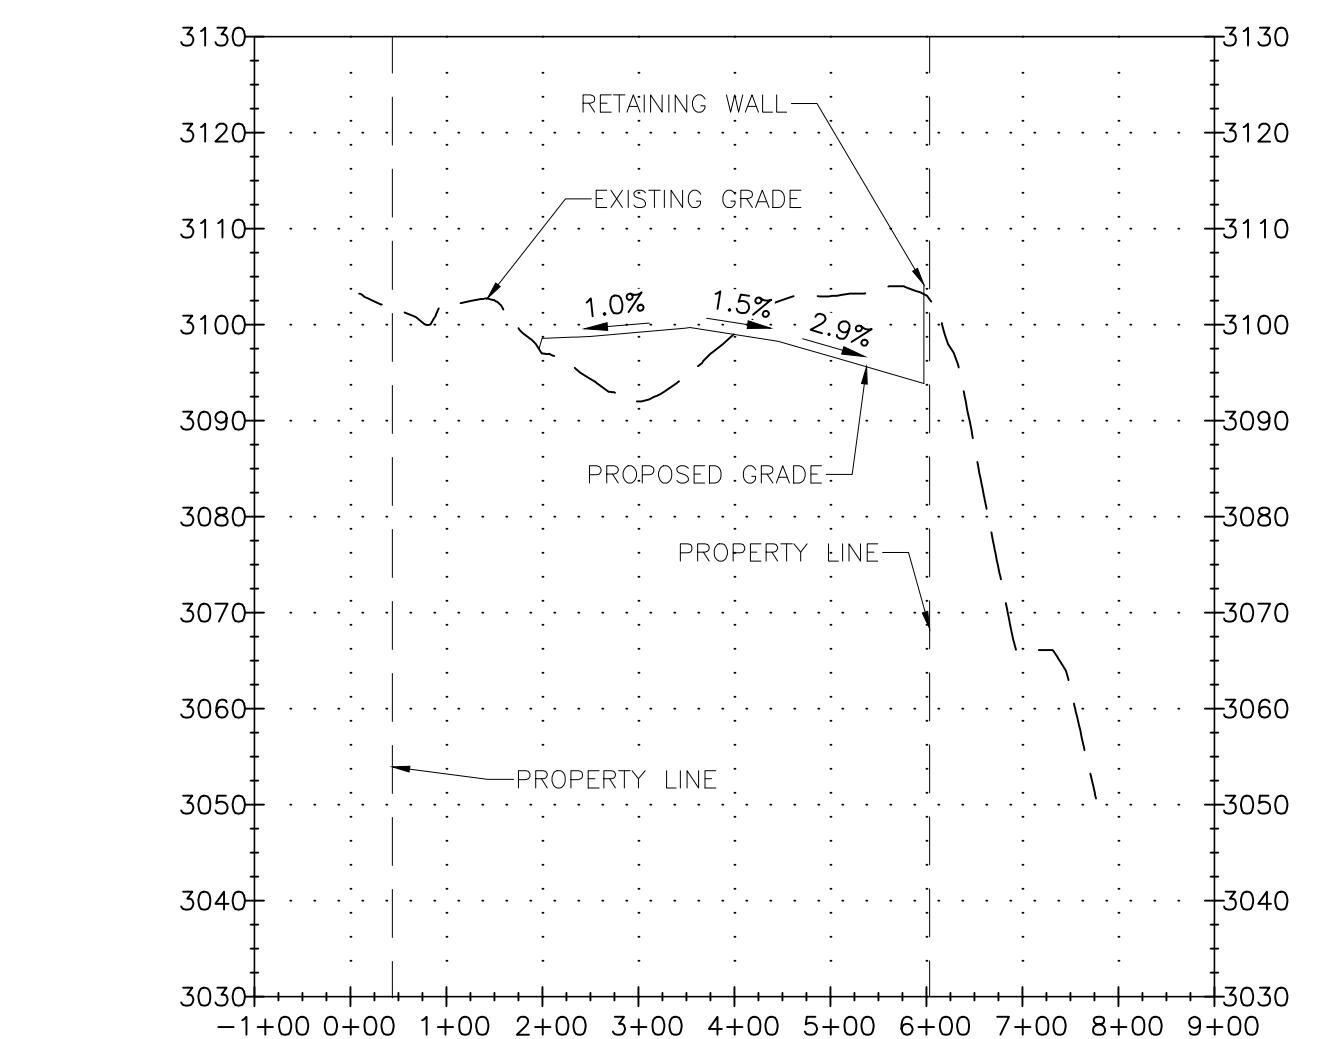
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Docket Number:	25-OPT-02
Project Title:	Prairie Song Reliability Project
TN #:	266805
Document Title:	Updated DR Response 2 Attachment 28 - Appendix 2A Site Plan Package - Part 1B
Description:	N/A
Filer:	Erin Phillips
Organization:	Dudek
Submitter Role:	Applicant Consultant
Submission Date:	10/23/2025 4:59:21 PM
Docketed Date:	10/23/2025





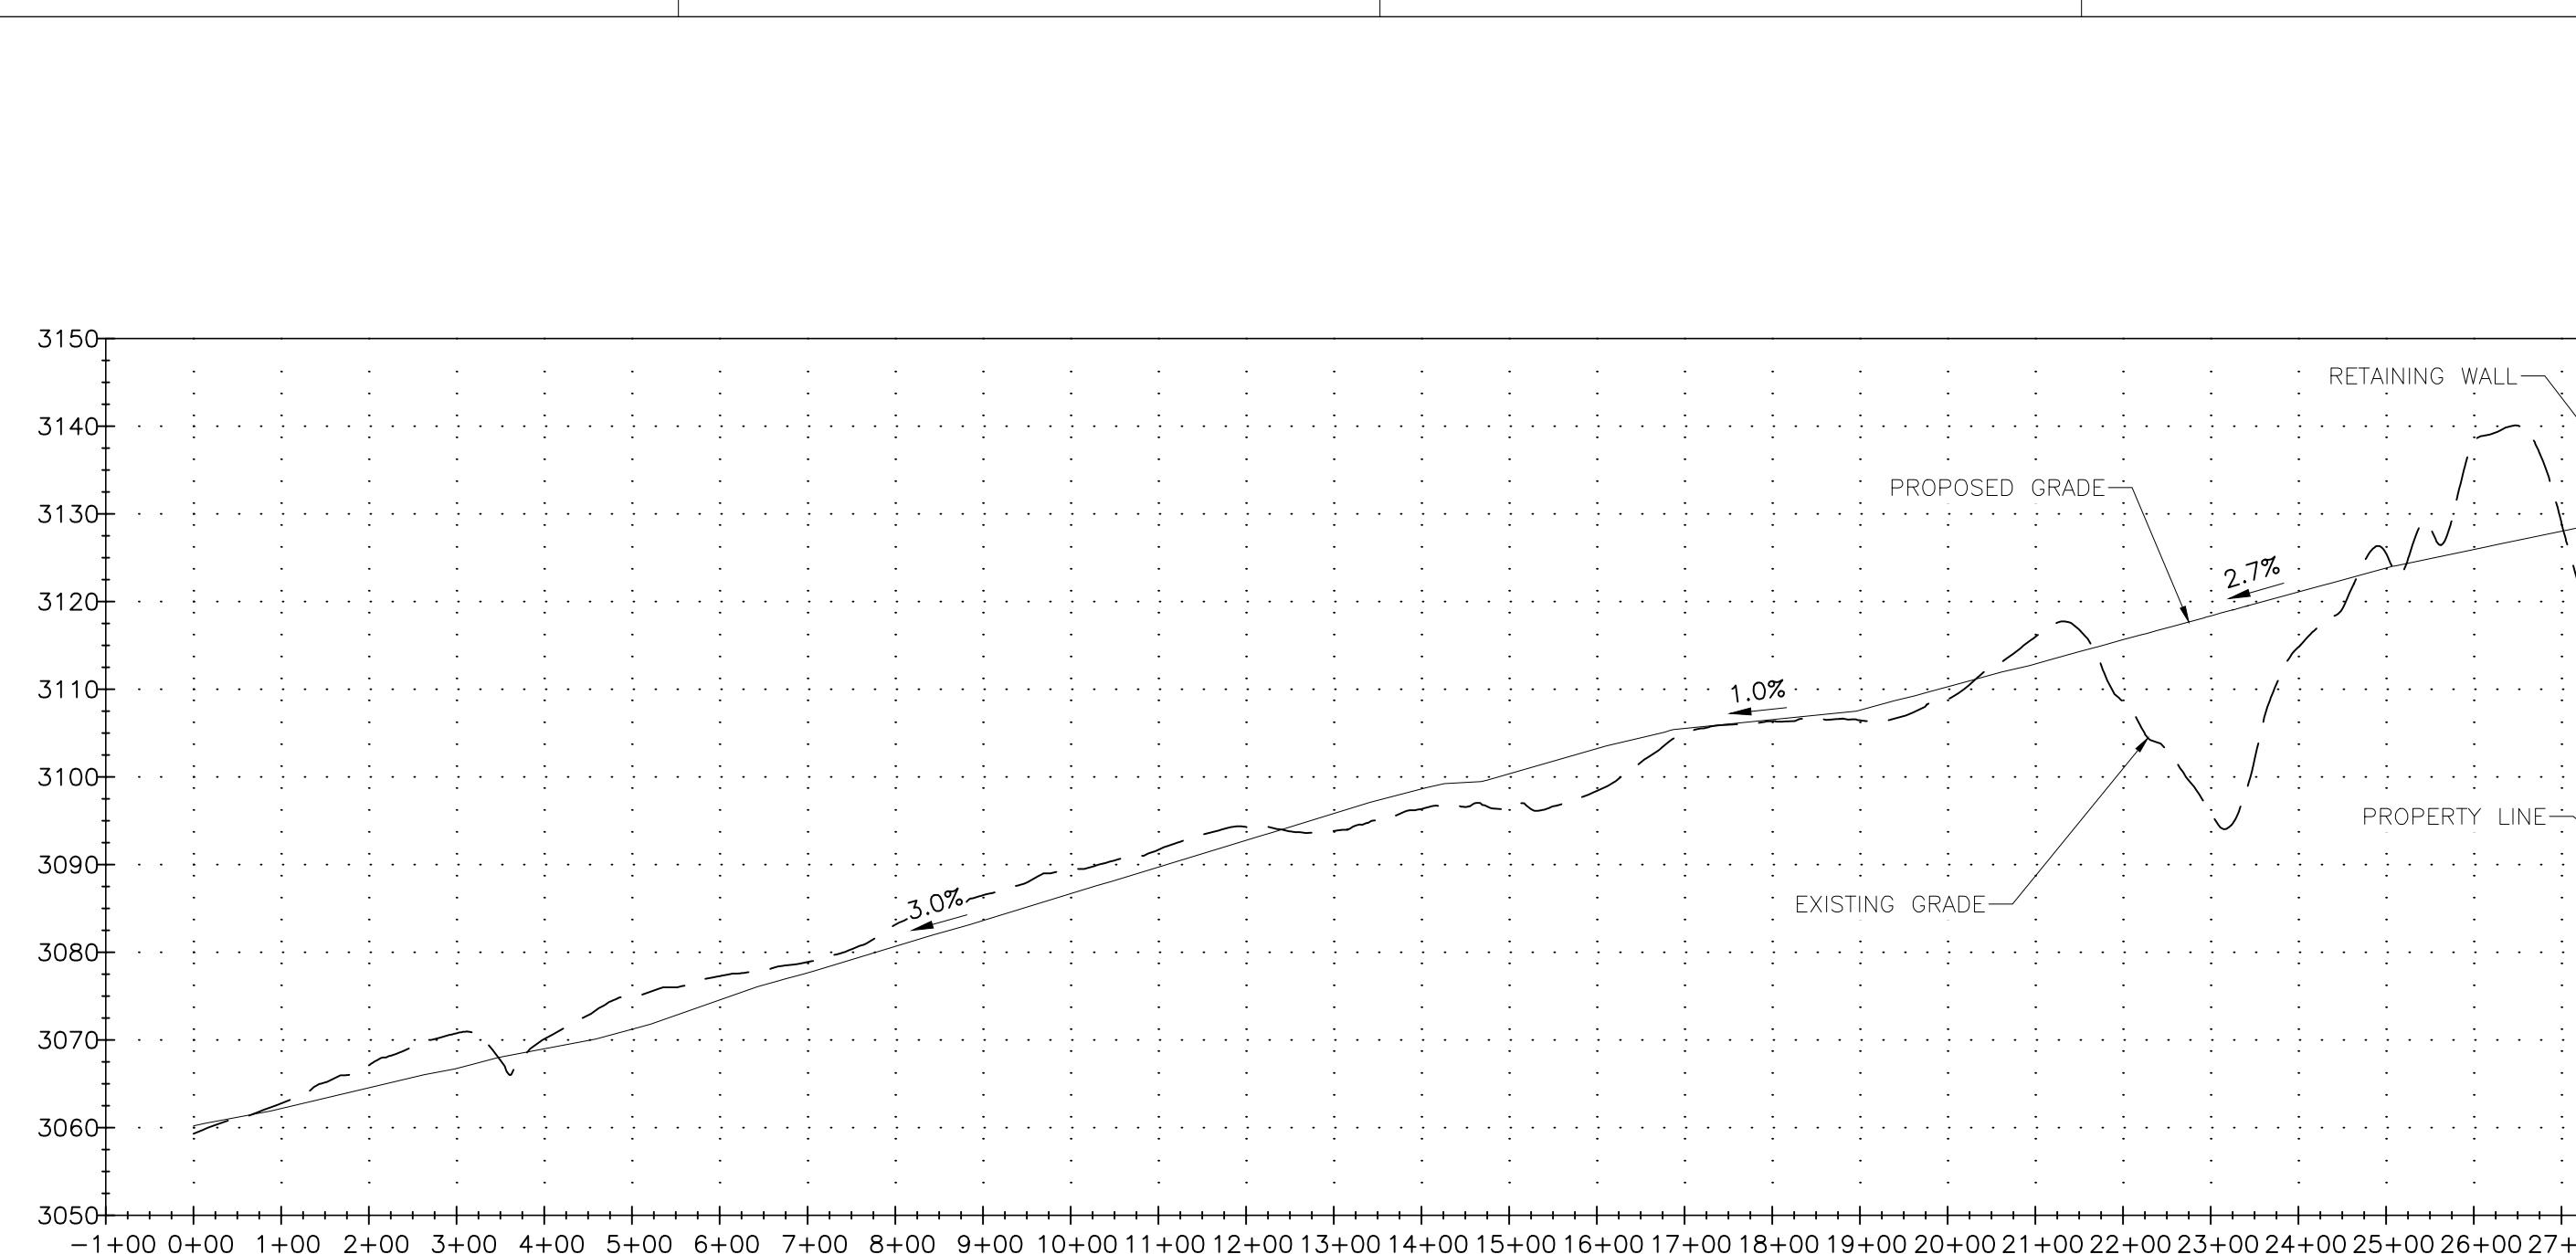
SECTION A EAST

HORIZONTAL SCALE: 1"=200'
VERTICAL SCALE: 1"=20'
(SEE DRAWING PSR-CS-004 S012)



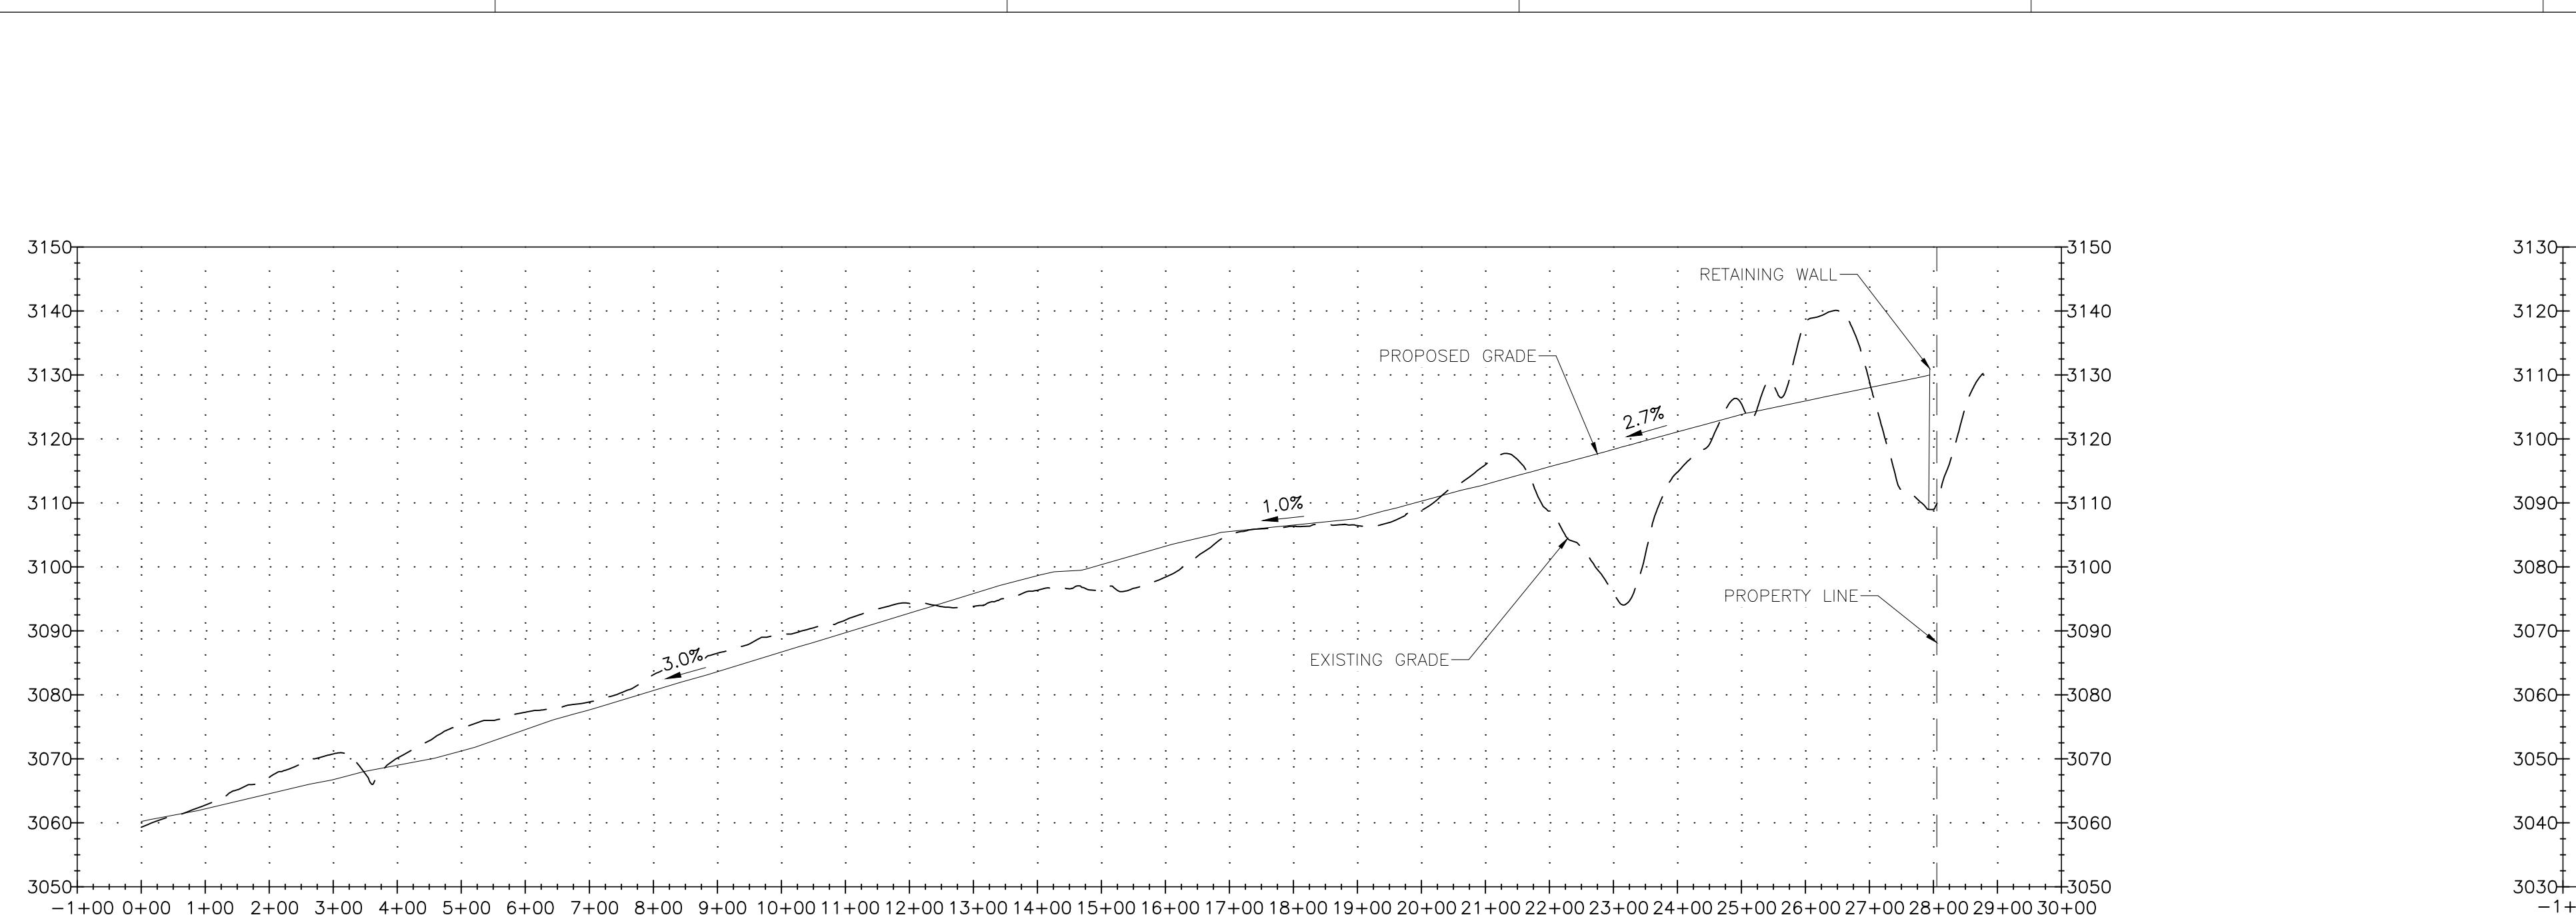
SECTION B EAST

HORIZONTAL SCALE: 1"=200'
VERTICAL SCALE: 1"=20'
(SEE DRAWING PSR-CS-004 S012)



SECTION C EAST

HORIZONTAL SCALE: 1"=200'
VERTICAL SCALE: 1"=20'
(SEE DRAWINGS PSR-CS-004 S011 & PSR-CS-004 S012)



SECTION D EAST

HORIZONTAL SCALE: 1"=200'
VERTICAL SCALE: 1"=20'
(SEE DRAWING PSR-CS-004 S011)

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P.E. LICENSE #95825

CAD FILE NAME: PSR-CS-005 S002.DWG
PREPARED BY: CAF/JN
REVIEWED BY: JTP
APPROVED BY: --
ANY MODIFICATION OR ADDITION TO THIS DRAWING BY AN ORGANIZATION OTHER THAN SARGENT & LUNDY, IS NOT THE RESPONSIBILITY OF SARGENT & LUNDY.

Sargent & Lundy

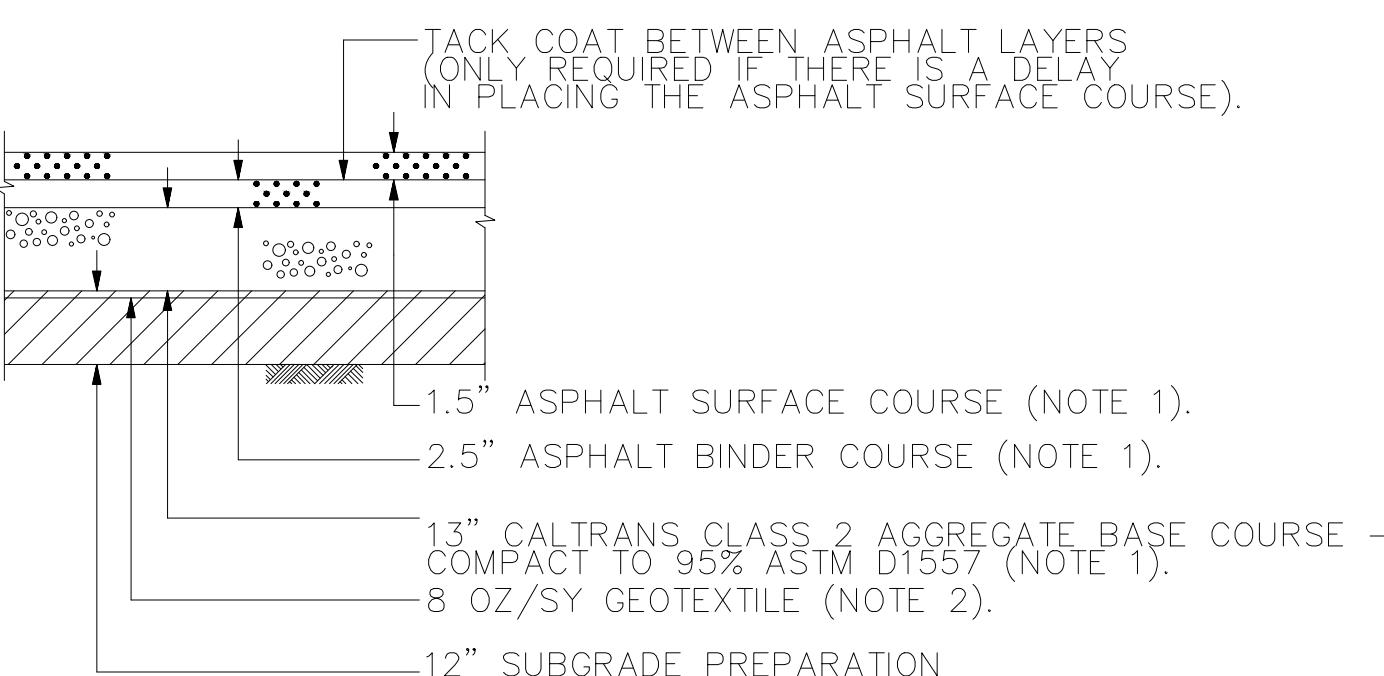
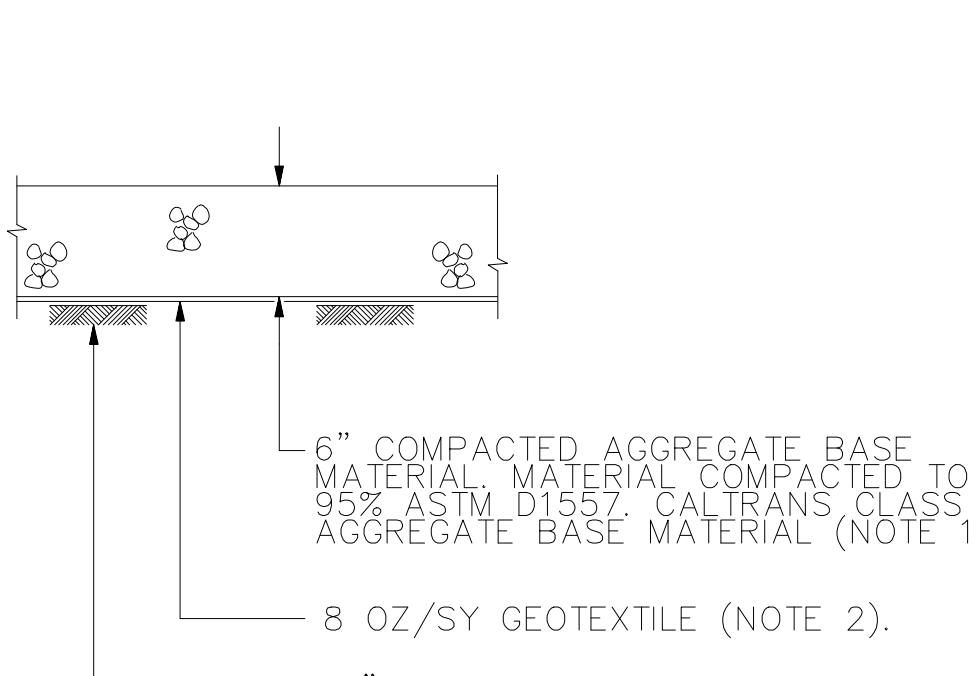
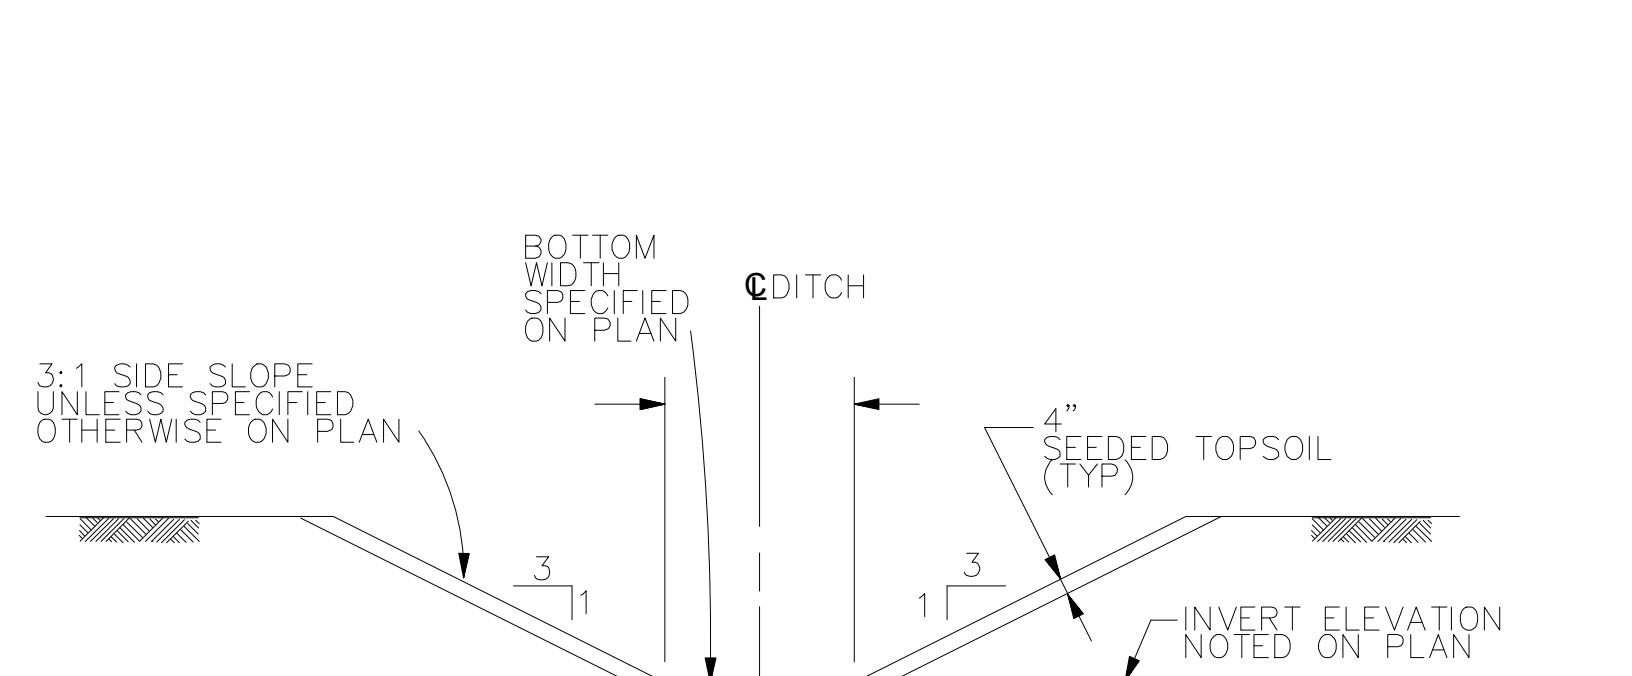
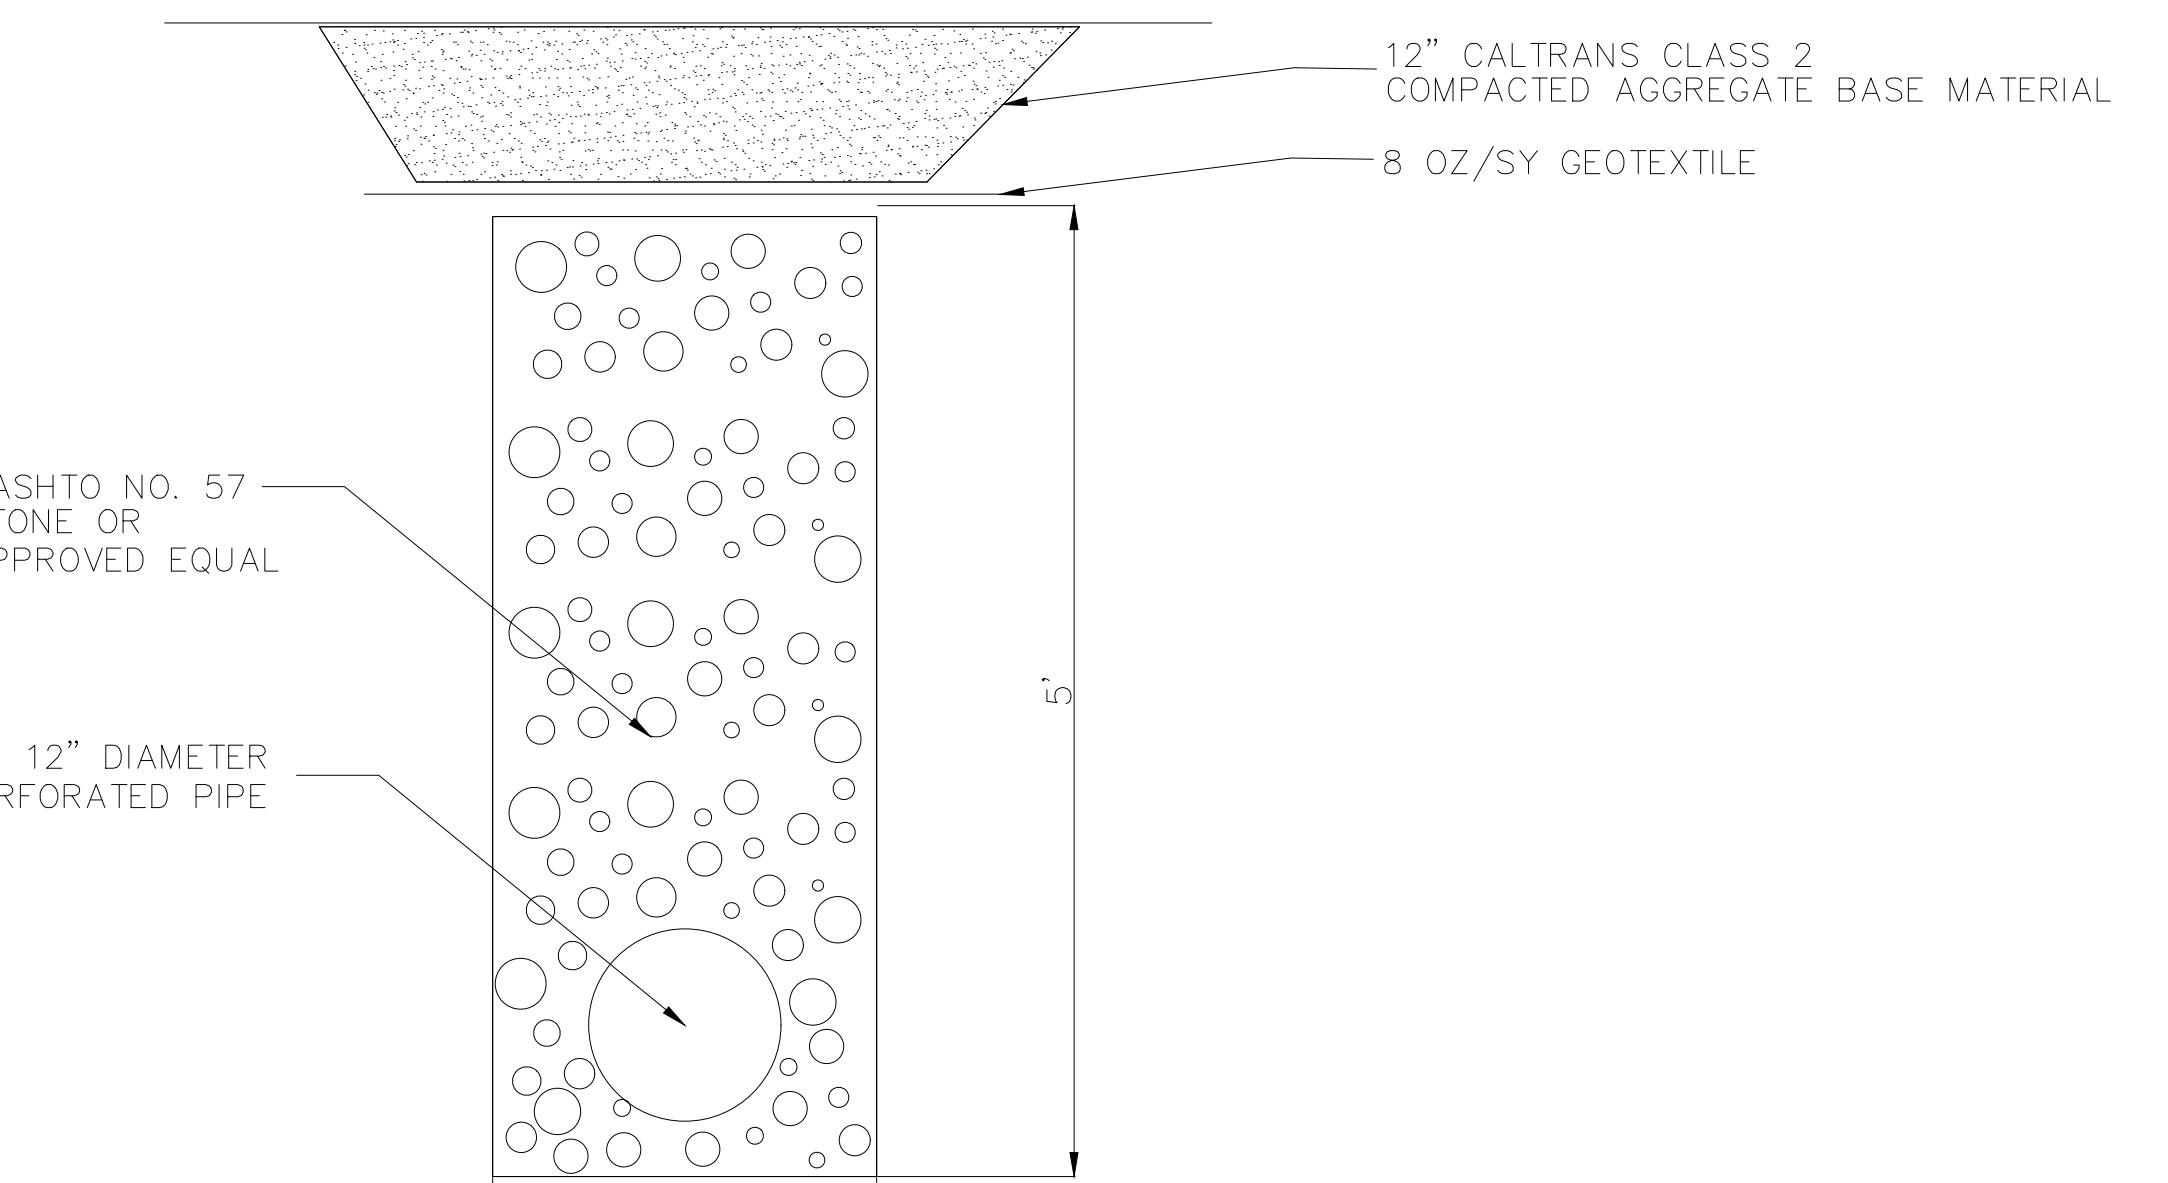
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CHICAGO, ILLINOIS 60603-5780

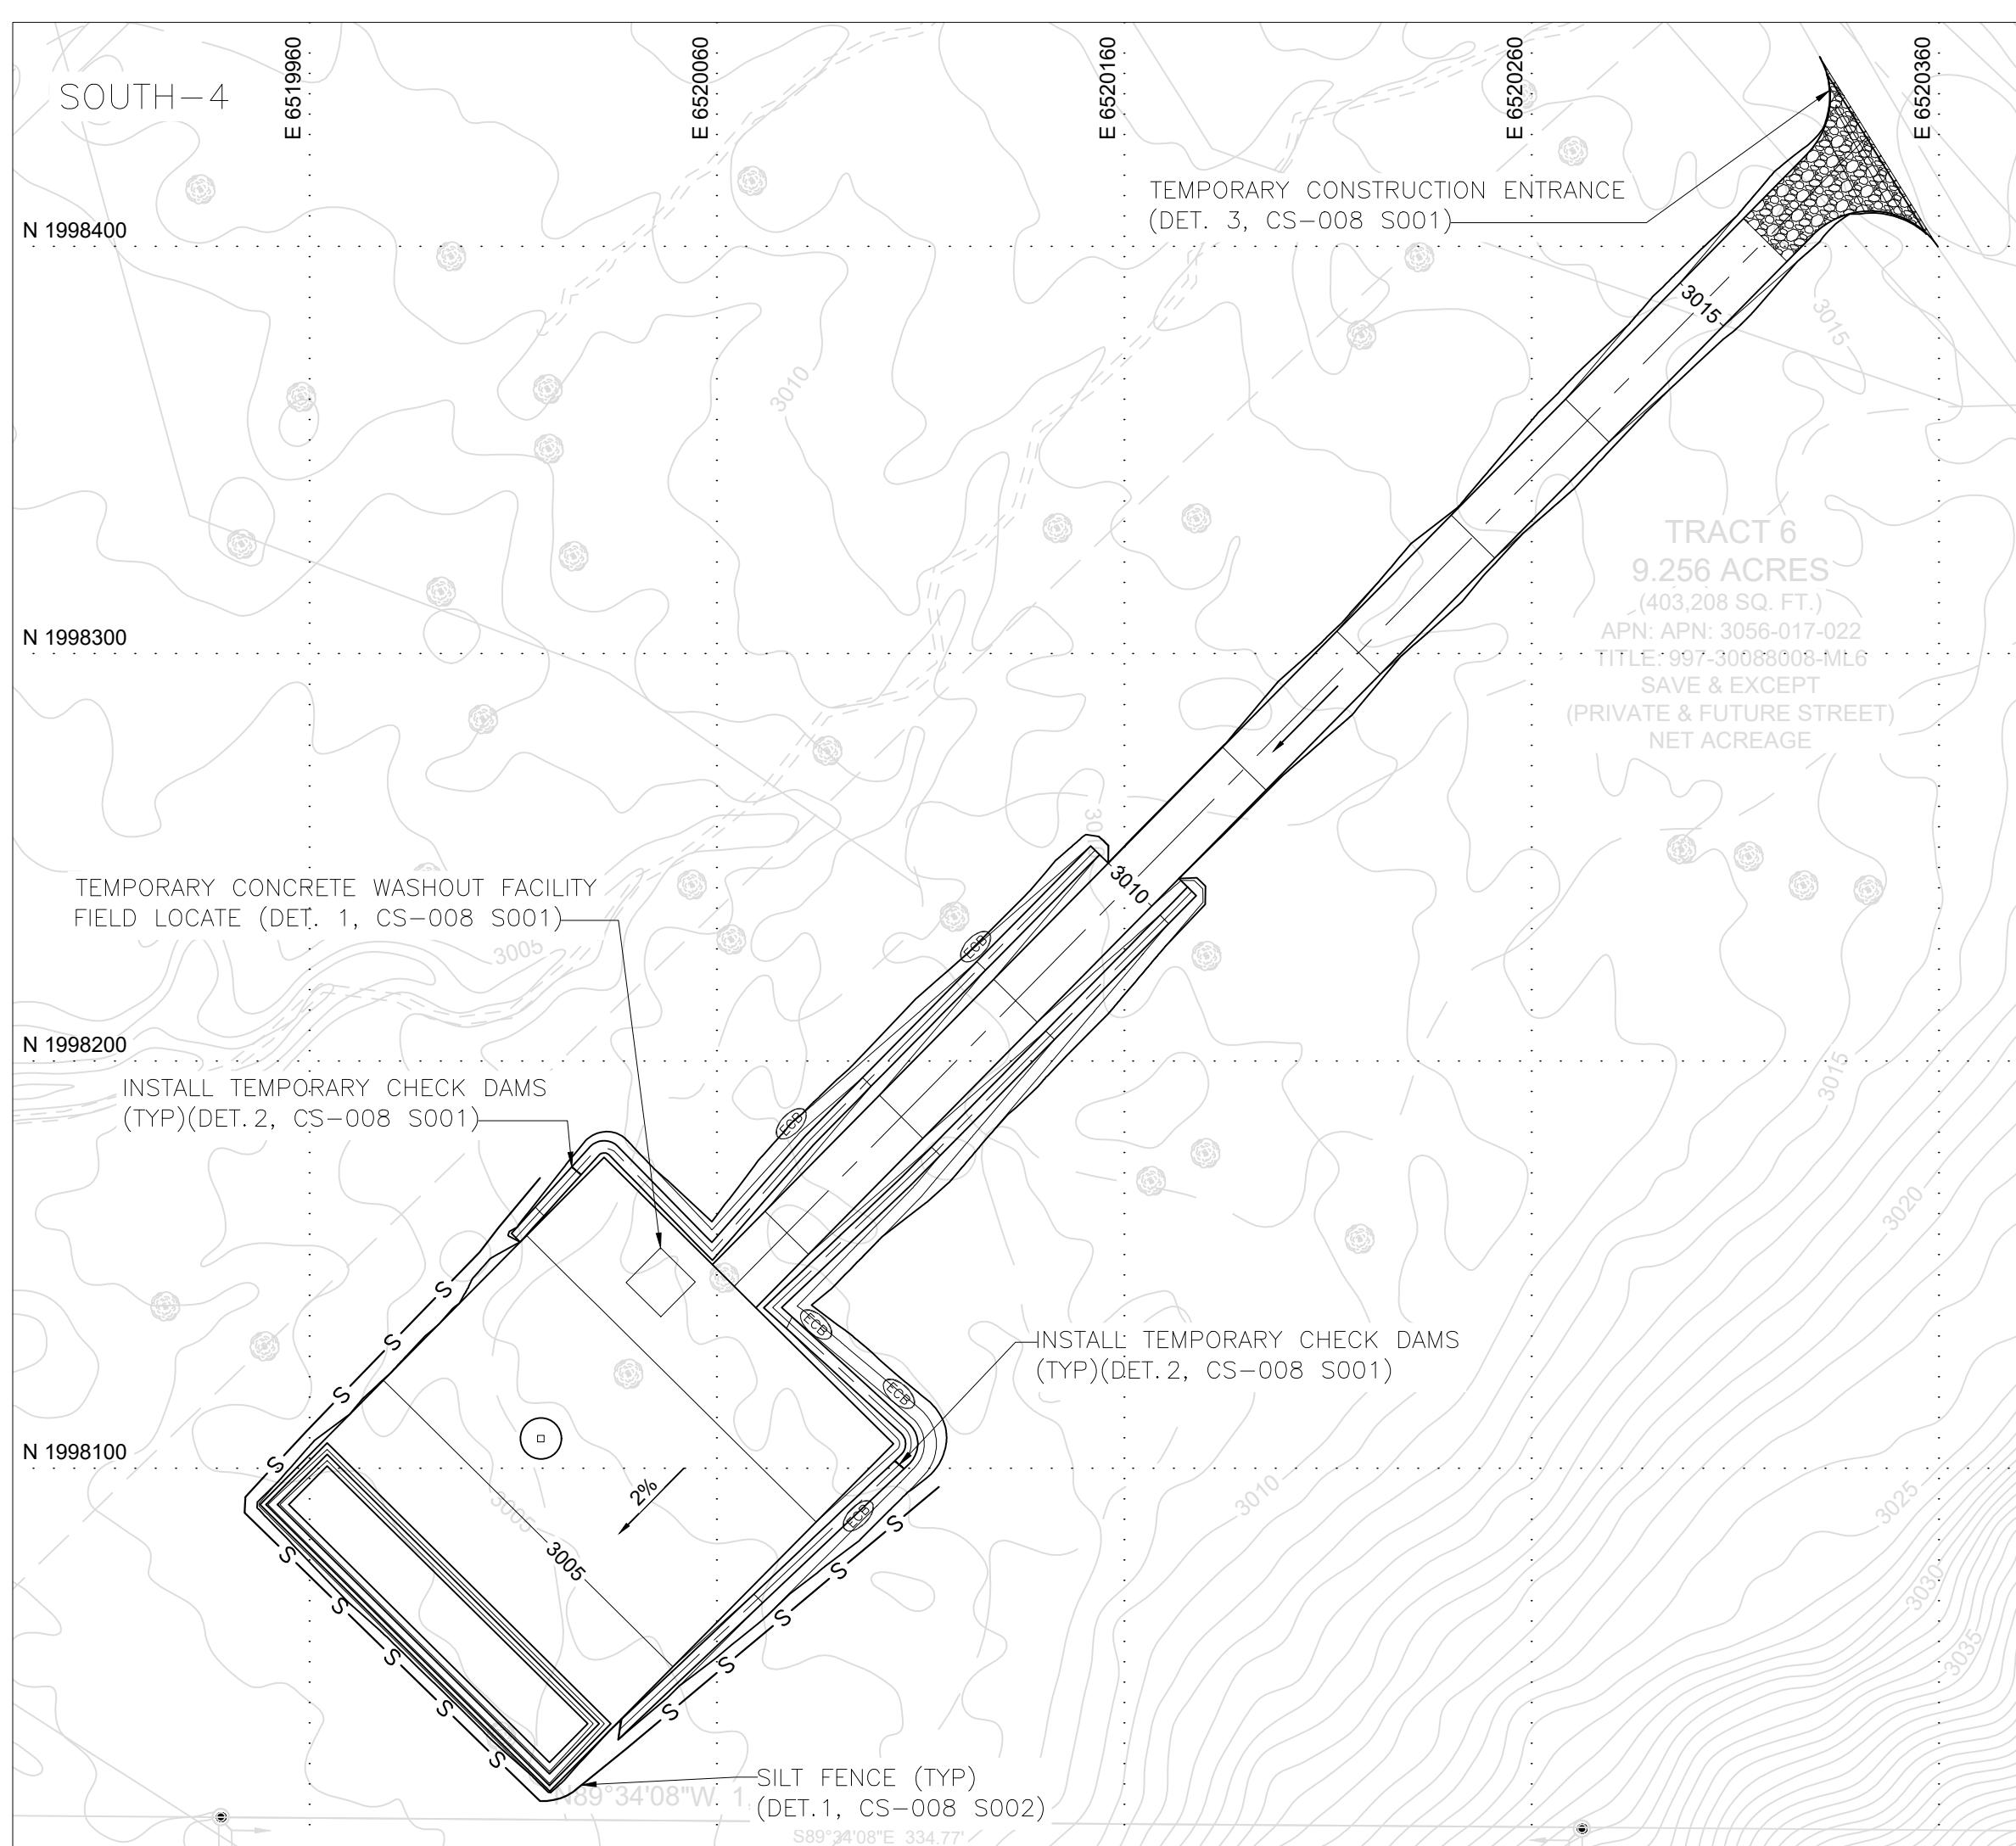
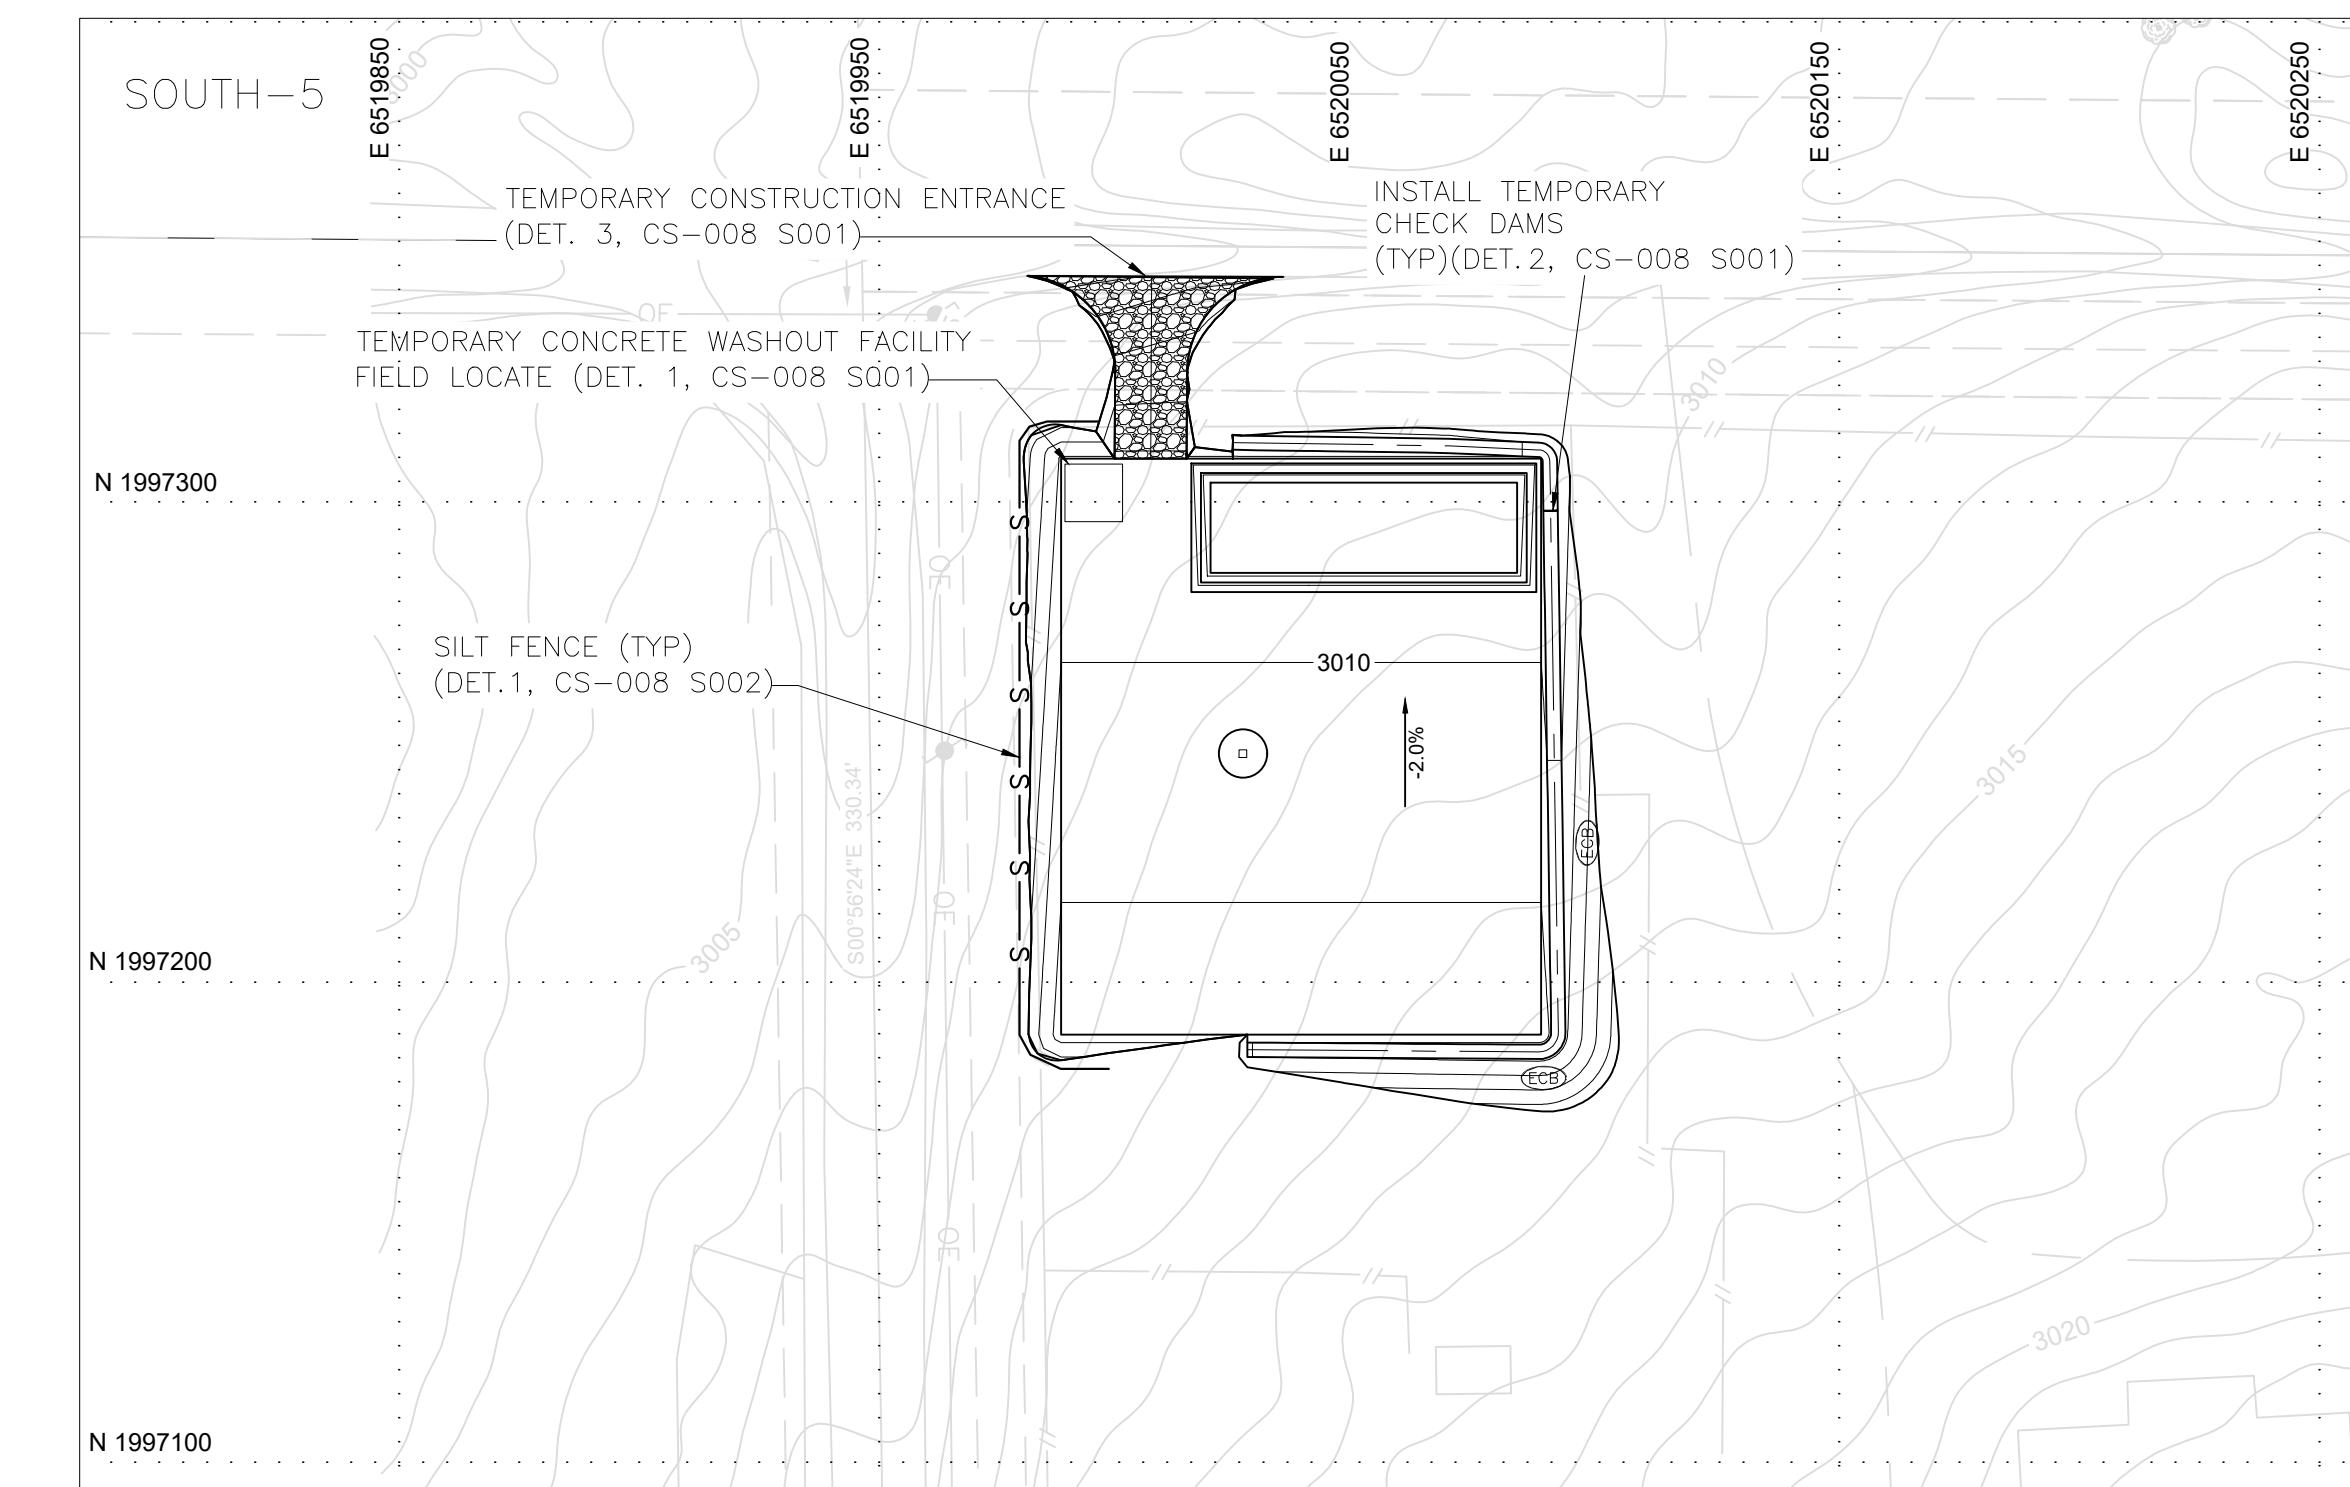
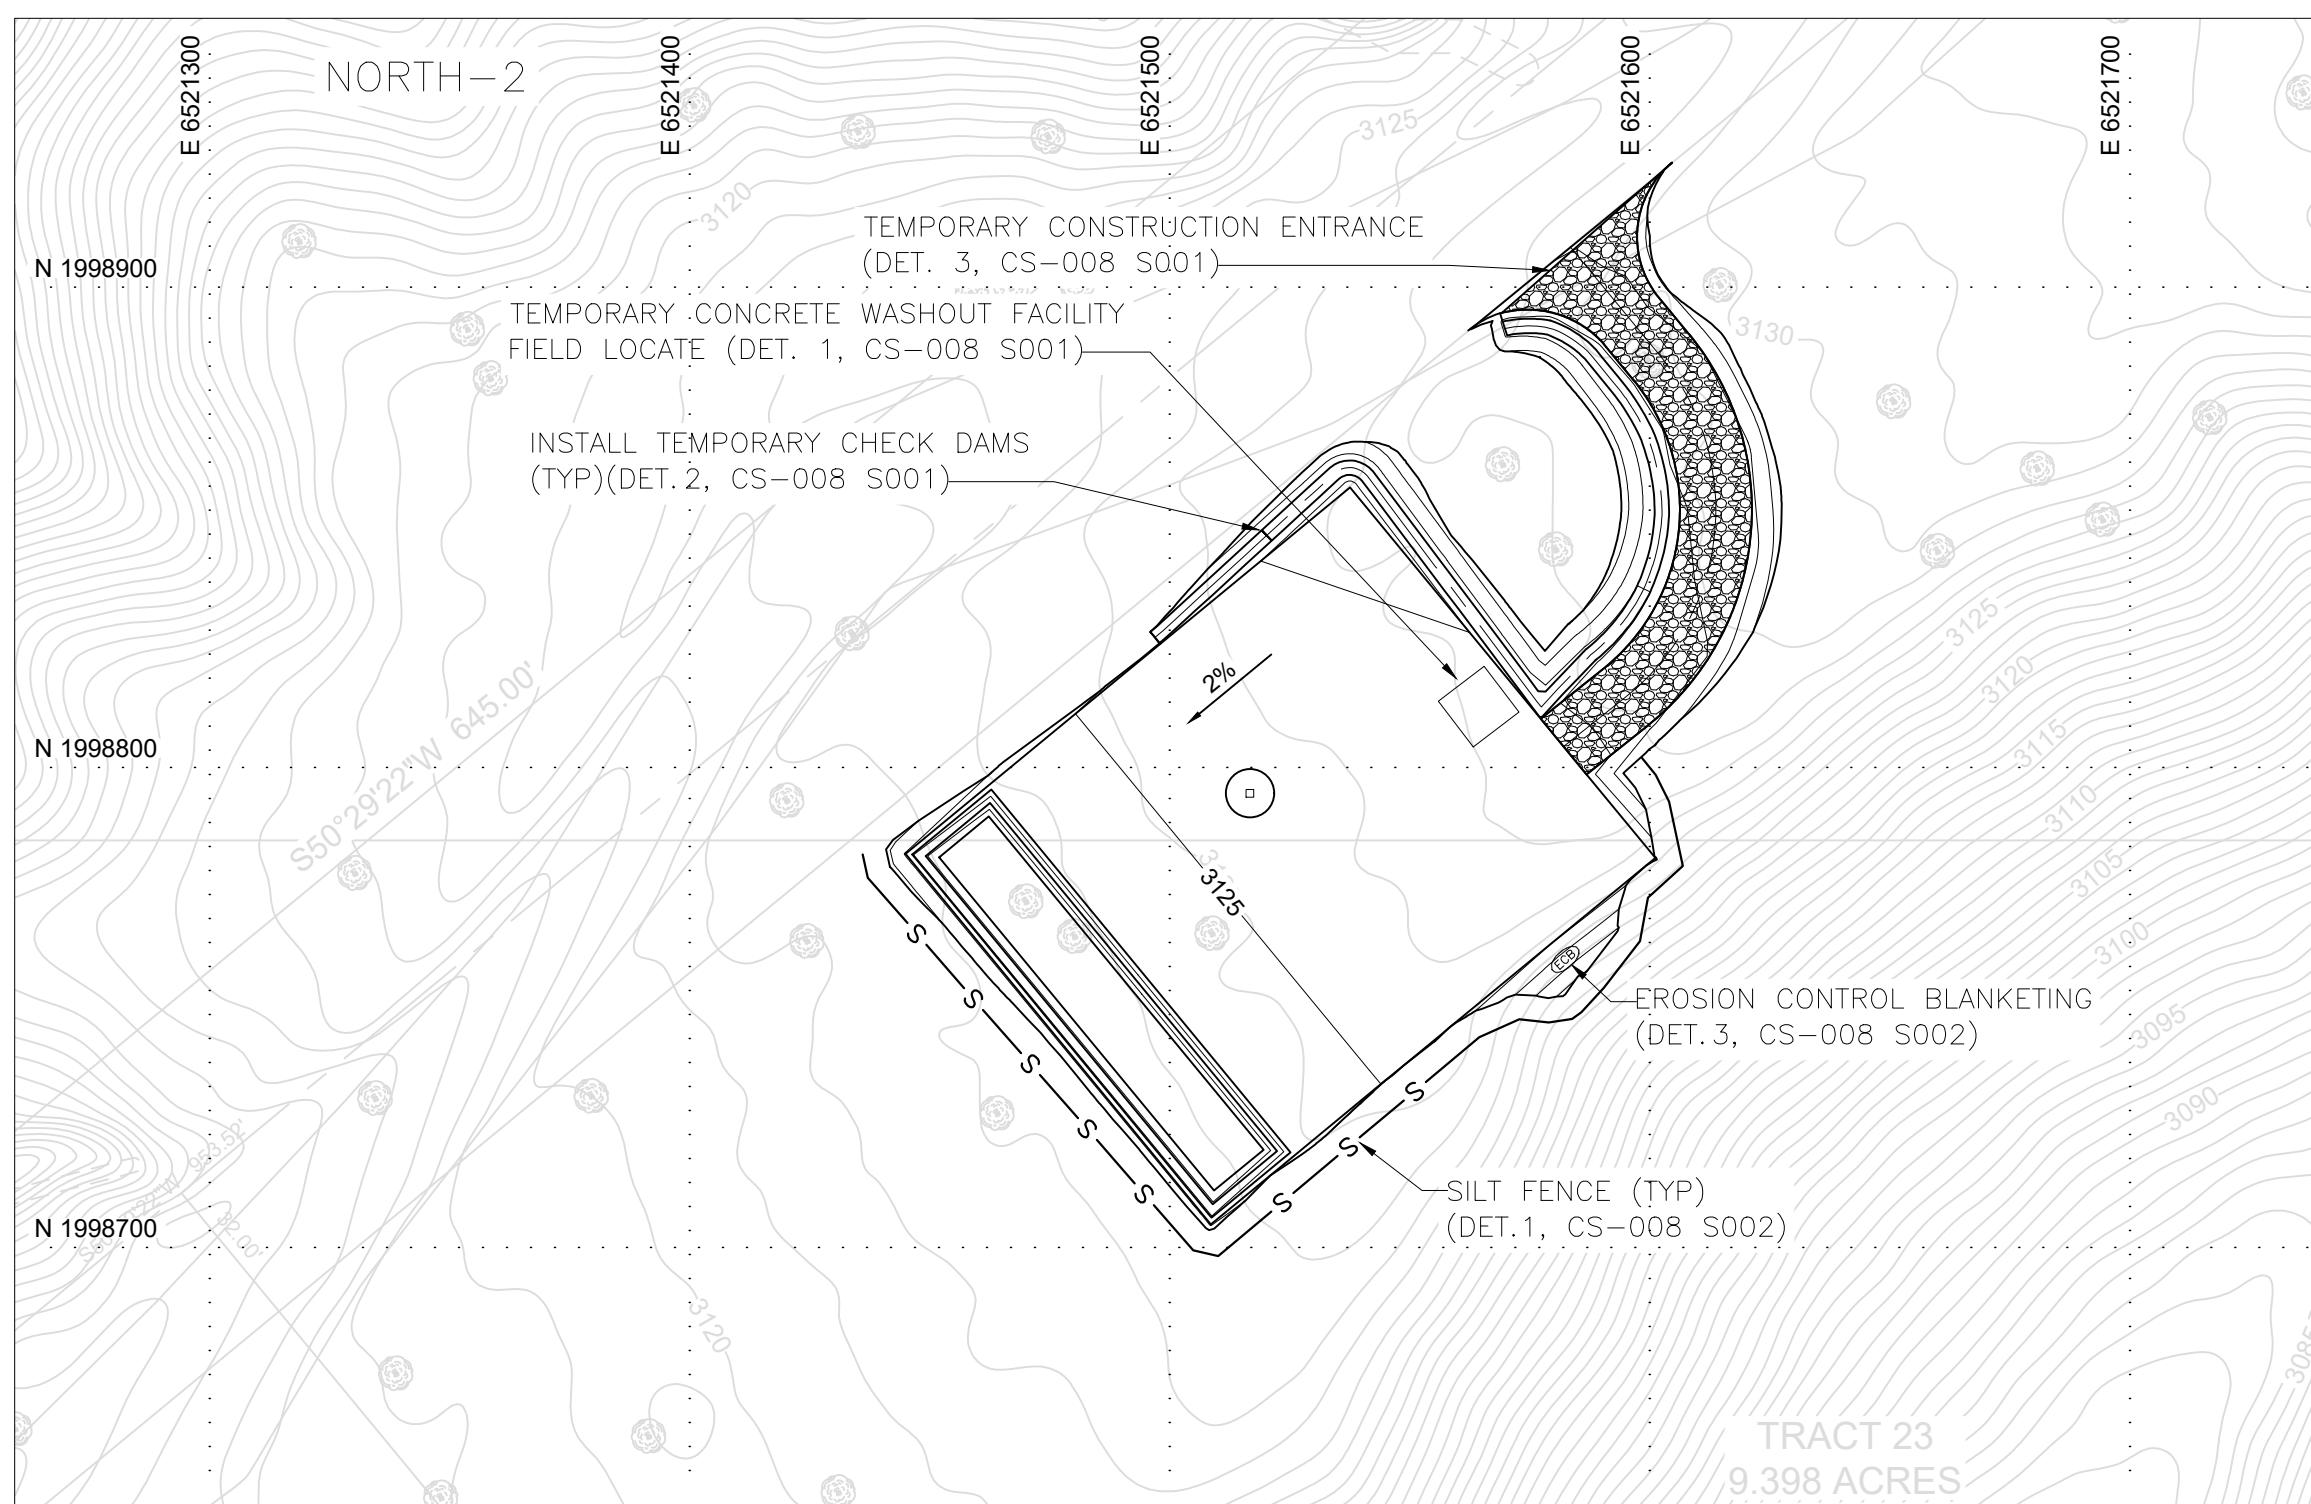
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PSR-CS-005 S002	0C
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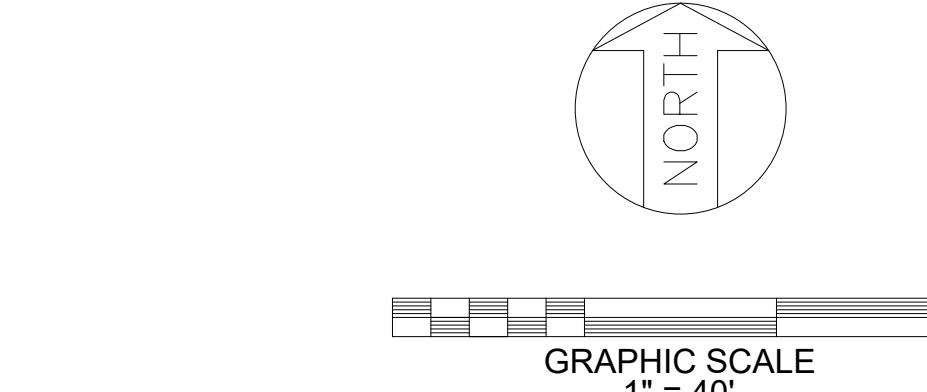
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ASPHALT PAVEMENT SECTION DETAIL 1 SCALE: N.T.S.																				
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INfiltration TRENCH DETAIL 4 SCALE: N.T.S.																				
																				
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1. ALL MATERIAL FOR PAVEMENTS AND SURFACING SHALL BE FURNISHED AND INSTALLED PER THE CALTRANS STANDARD SPECIFICATIONS MANUAL. 2. GEOTEXTILE SHALL BE 8 OZ/SY NON-WOVEN FABRIC, US FABRICS, INC. OR APPROVED EQUAL. INSTALL PER MANUFACTURER'S RECOMMENDATIONS.																				
REFERENCE DRAWINGS																				
																				
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NOTES

1. GEOTECHNICAL ENGINEERING REPORT PREPARED BY:
TERRACON CONSULTANTS INC., PROJECT NO. LA245085, DATED 05-14-2025.
2. FOR GENERAL NOTES, ABBREVIATIONS AND LEGEND SEE DRAWING PSR-CS-002.

REFERENCE DRAWINGS

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ISSUE PURPOSE: ISSUED FOR PERMIT

SPECIFICATION: -

PROJECT NO.: 15474.001

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ISSUED FOR PRELIMINARY PURPOSES
JOSHUA BICKETT
P.E. LICENSE #95825

CAD FILE NAME: PSR-CS-007 S001.DWG

PREPARED BY: CAF/JN

REVIEWED BY: JTP

APPROVED BY: --

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SARGENT & LUNDY
55 EAST MONROE STREET
CHICAGO, ILLINOIS 60603-5780

PROJECT

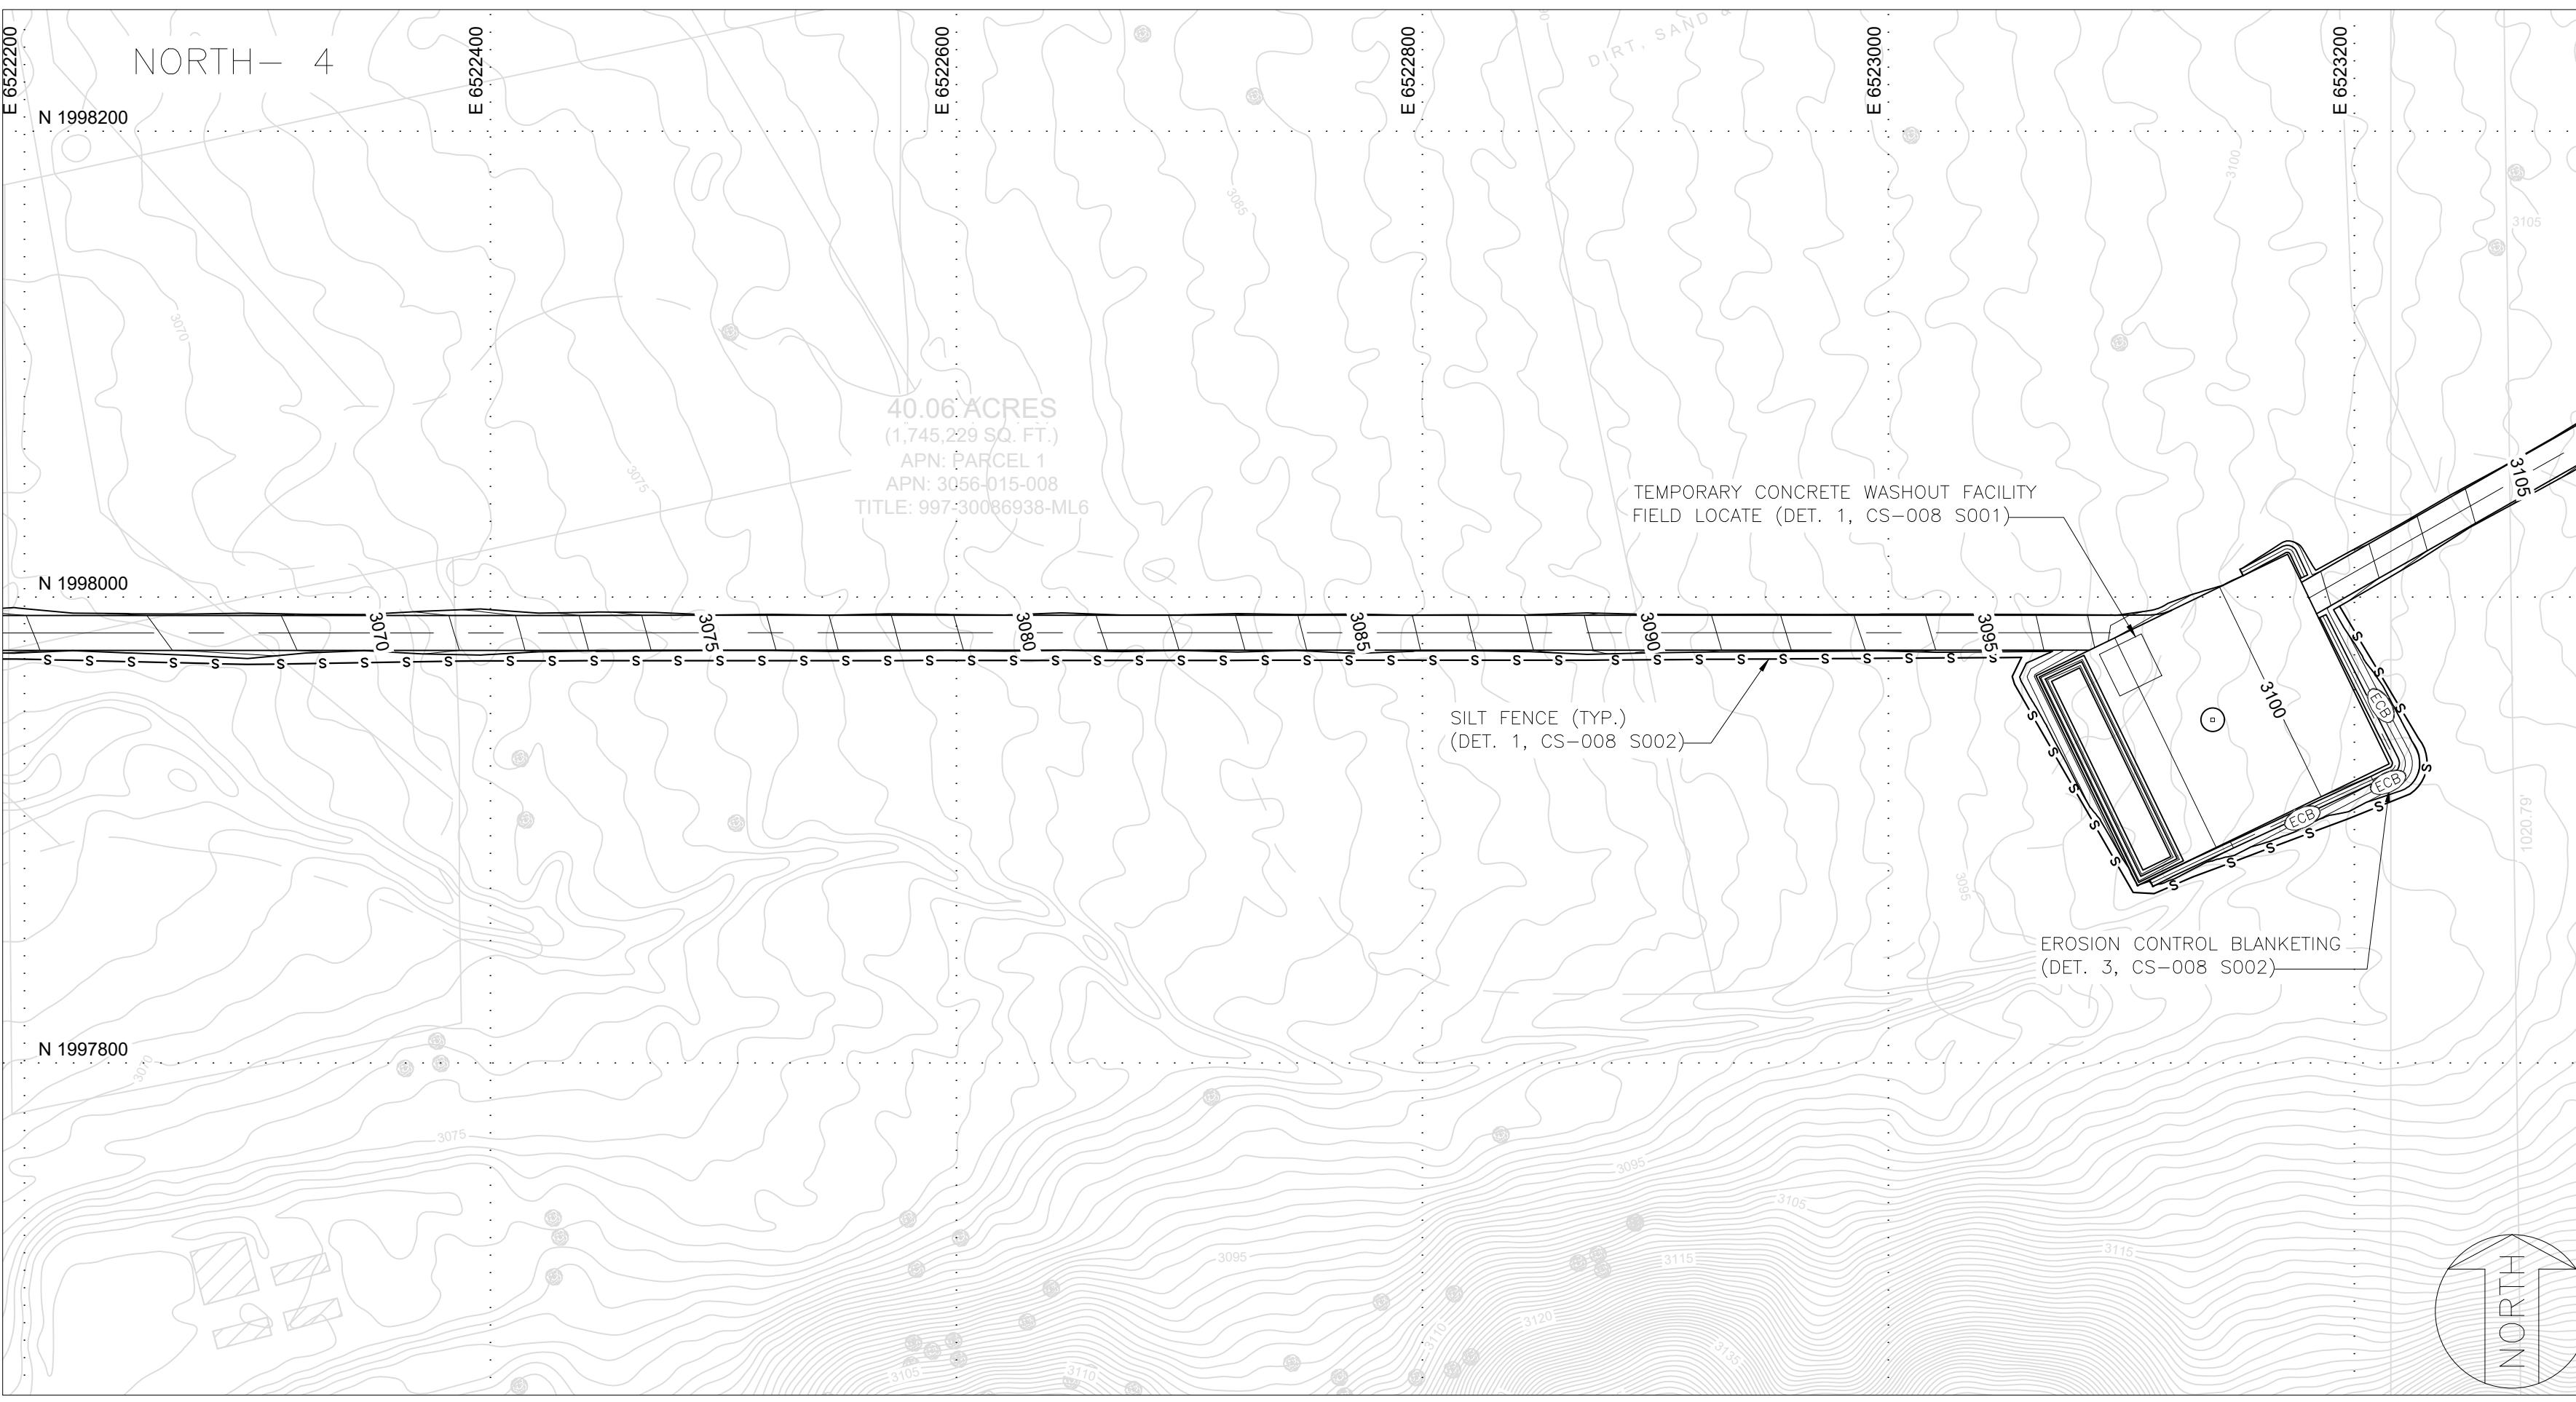
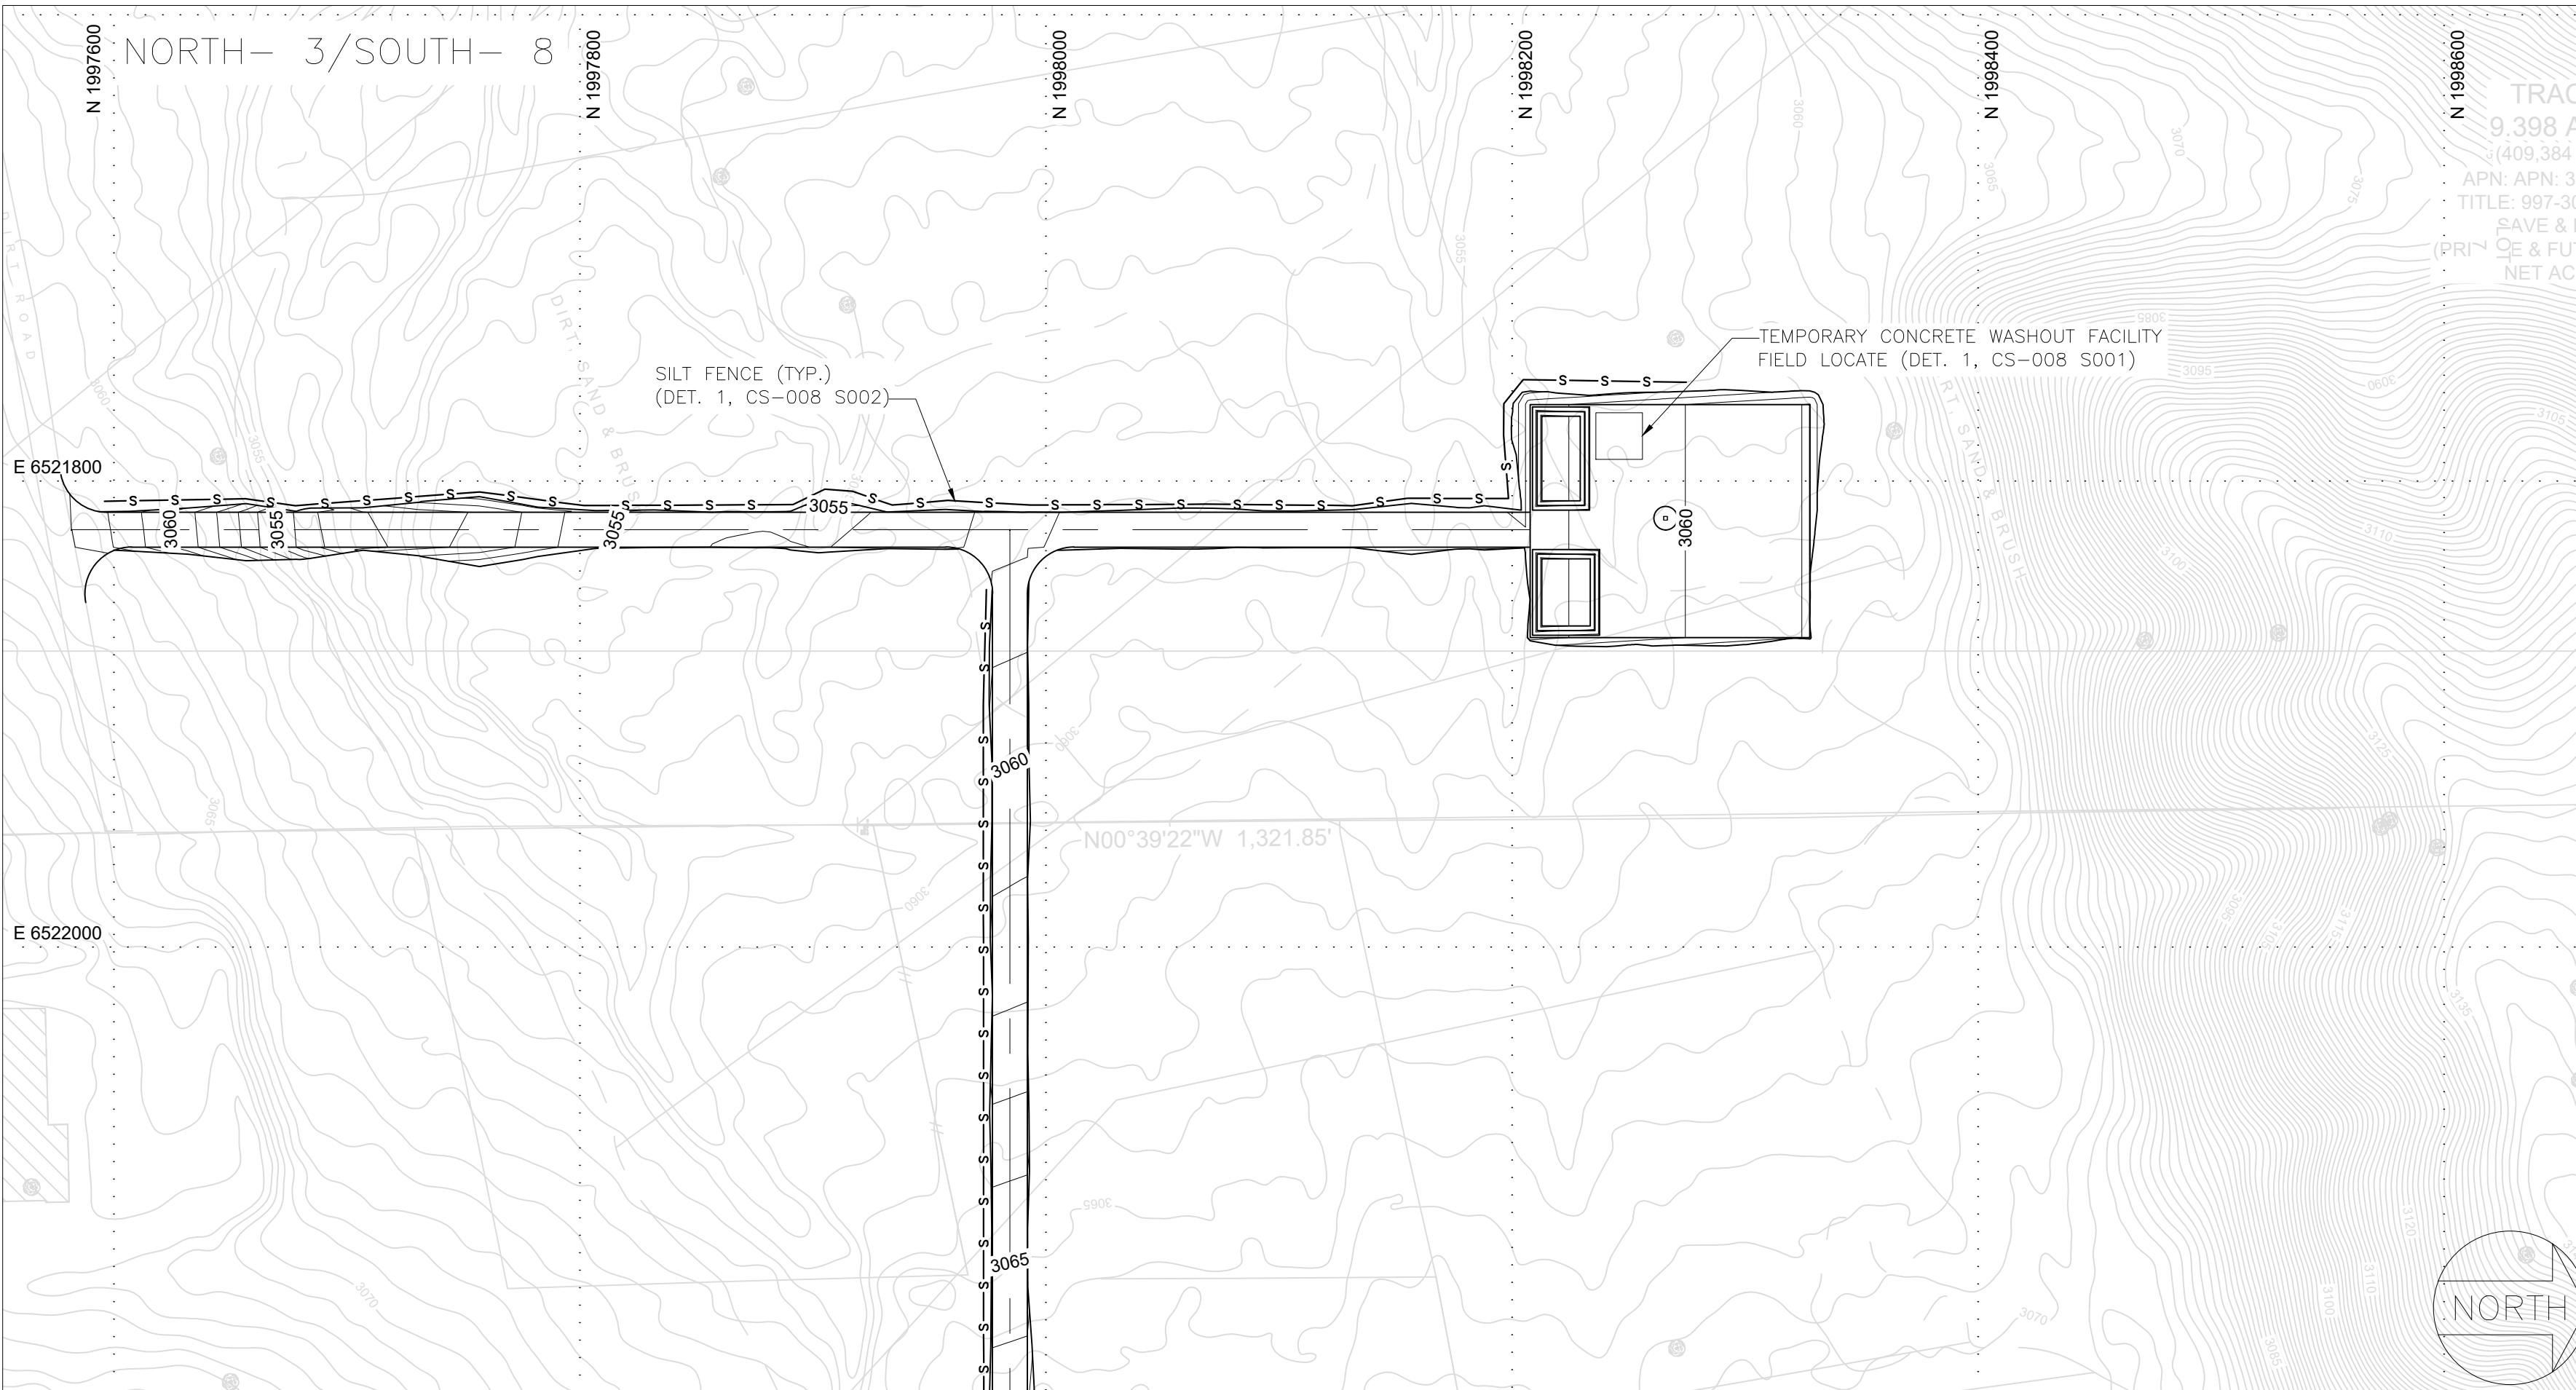
PRAIRIE SONG RELIABILITY PROJECT

DRAWING TITLE

EROSION AND SEDIMENT CONTROL PLAN

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SHEET 1 OF 1



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GRAPHIC SCALE
1" = 60'

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55 EAST MONROE STREET
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EROSION AND SEDIMENT CONTROL PLAN

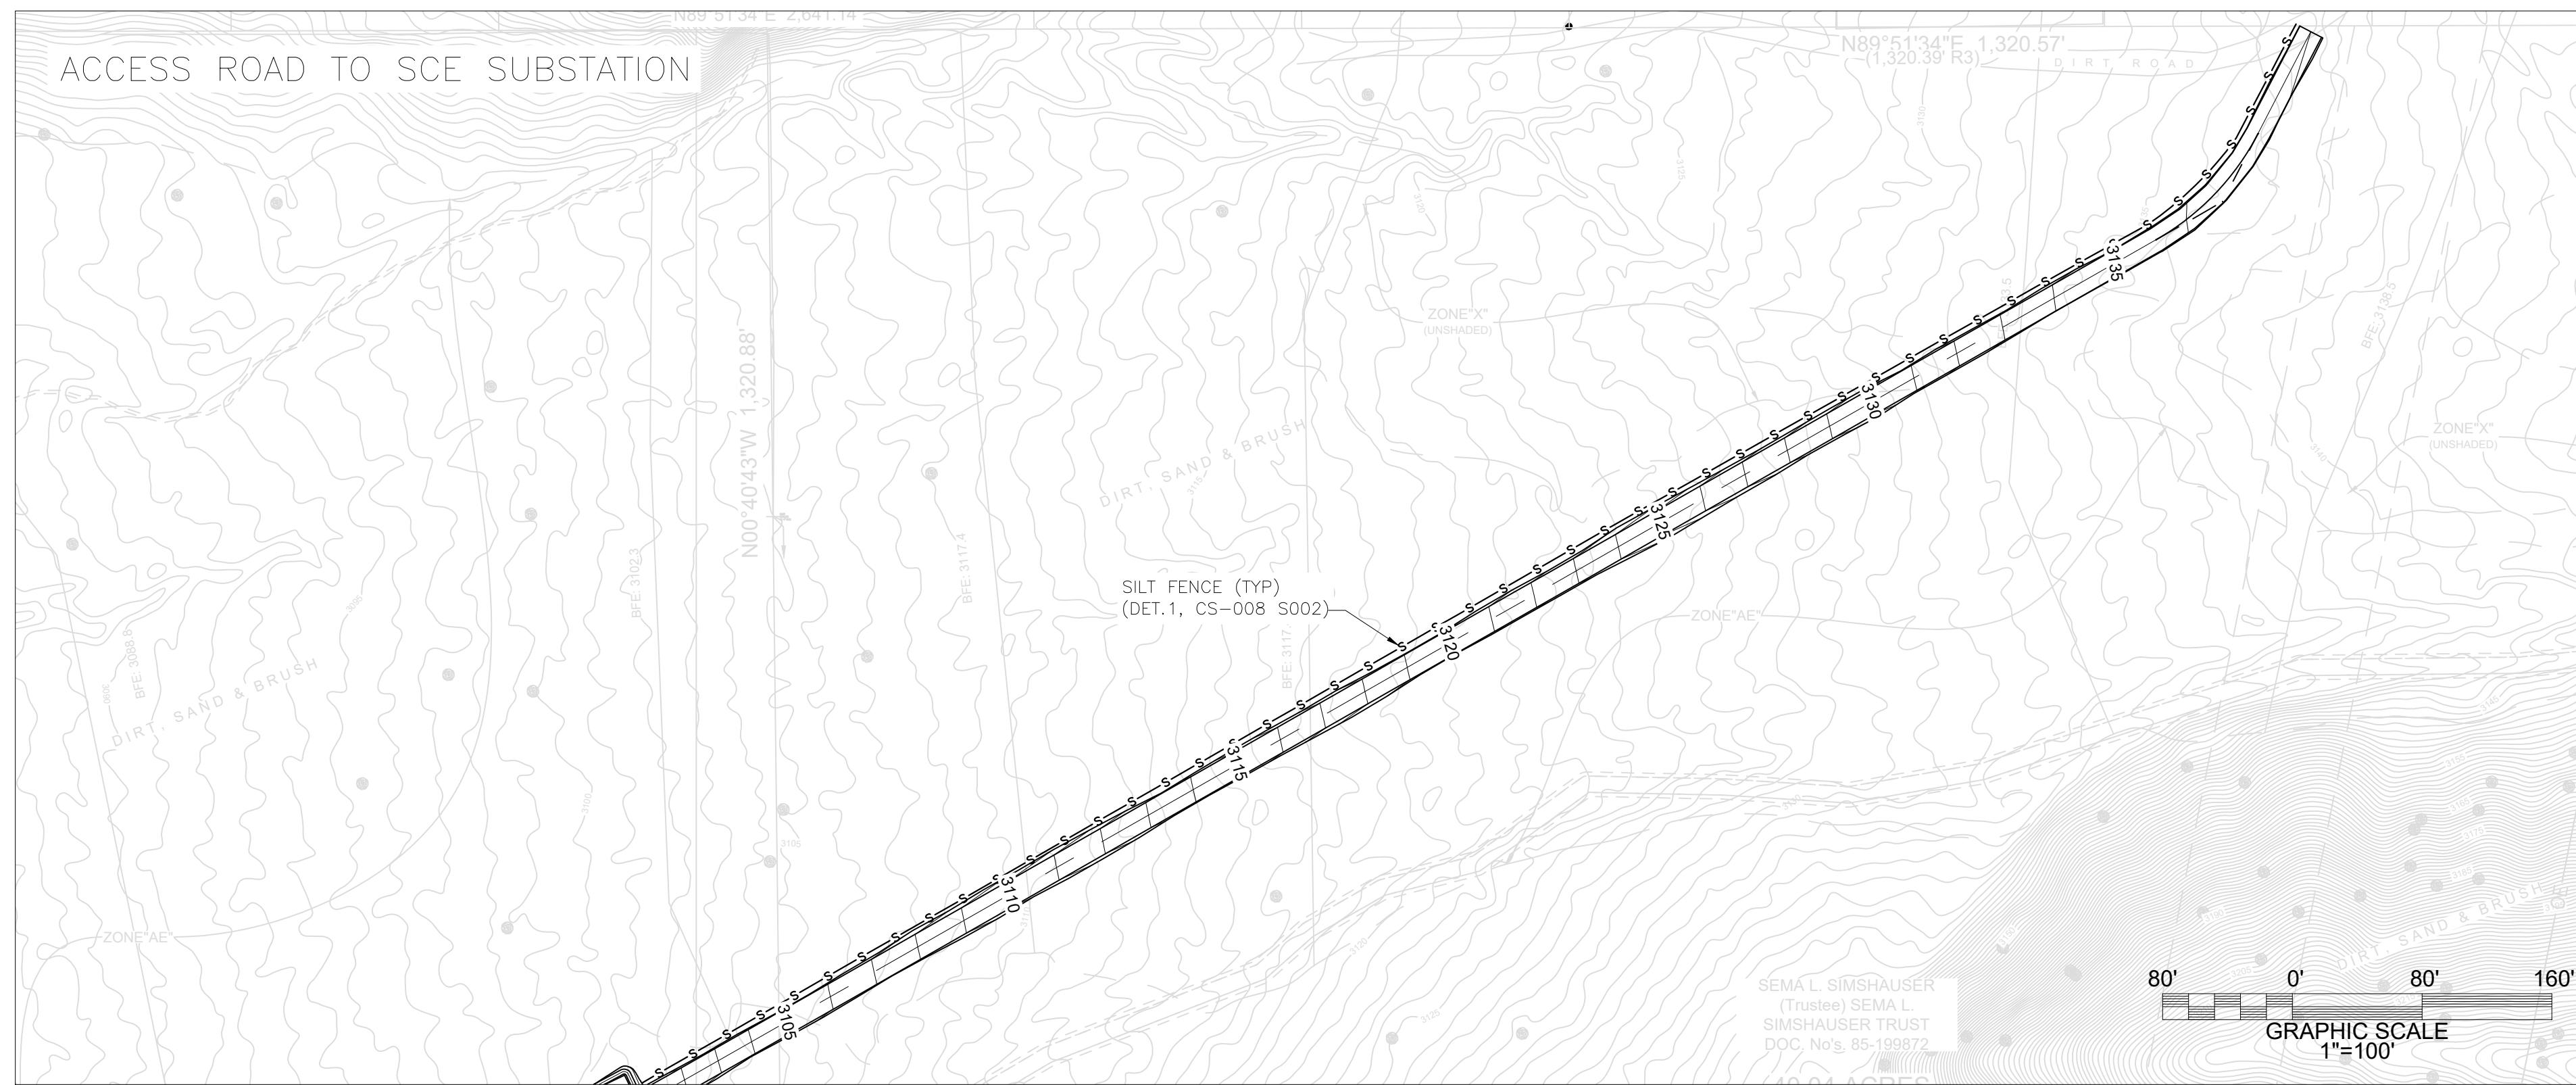
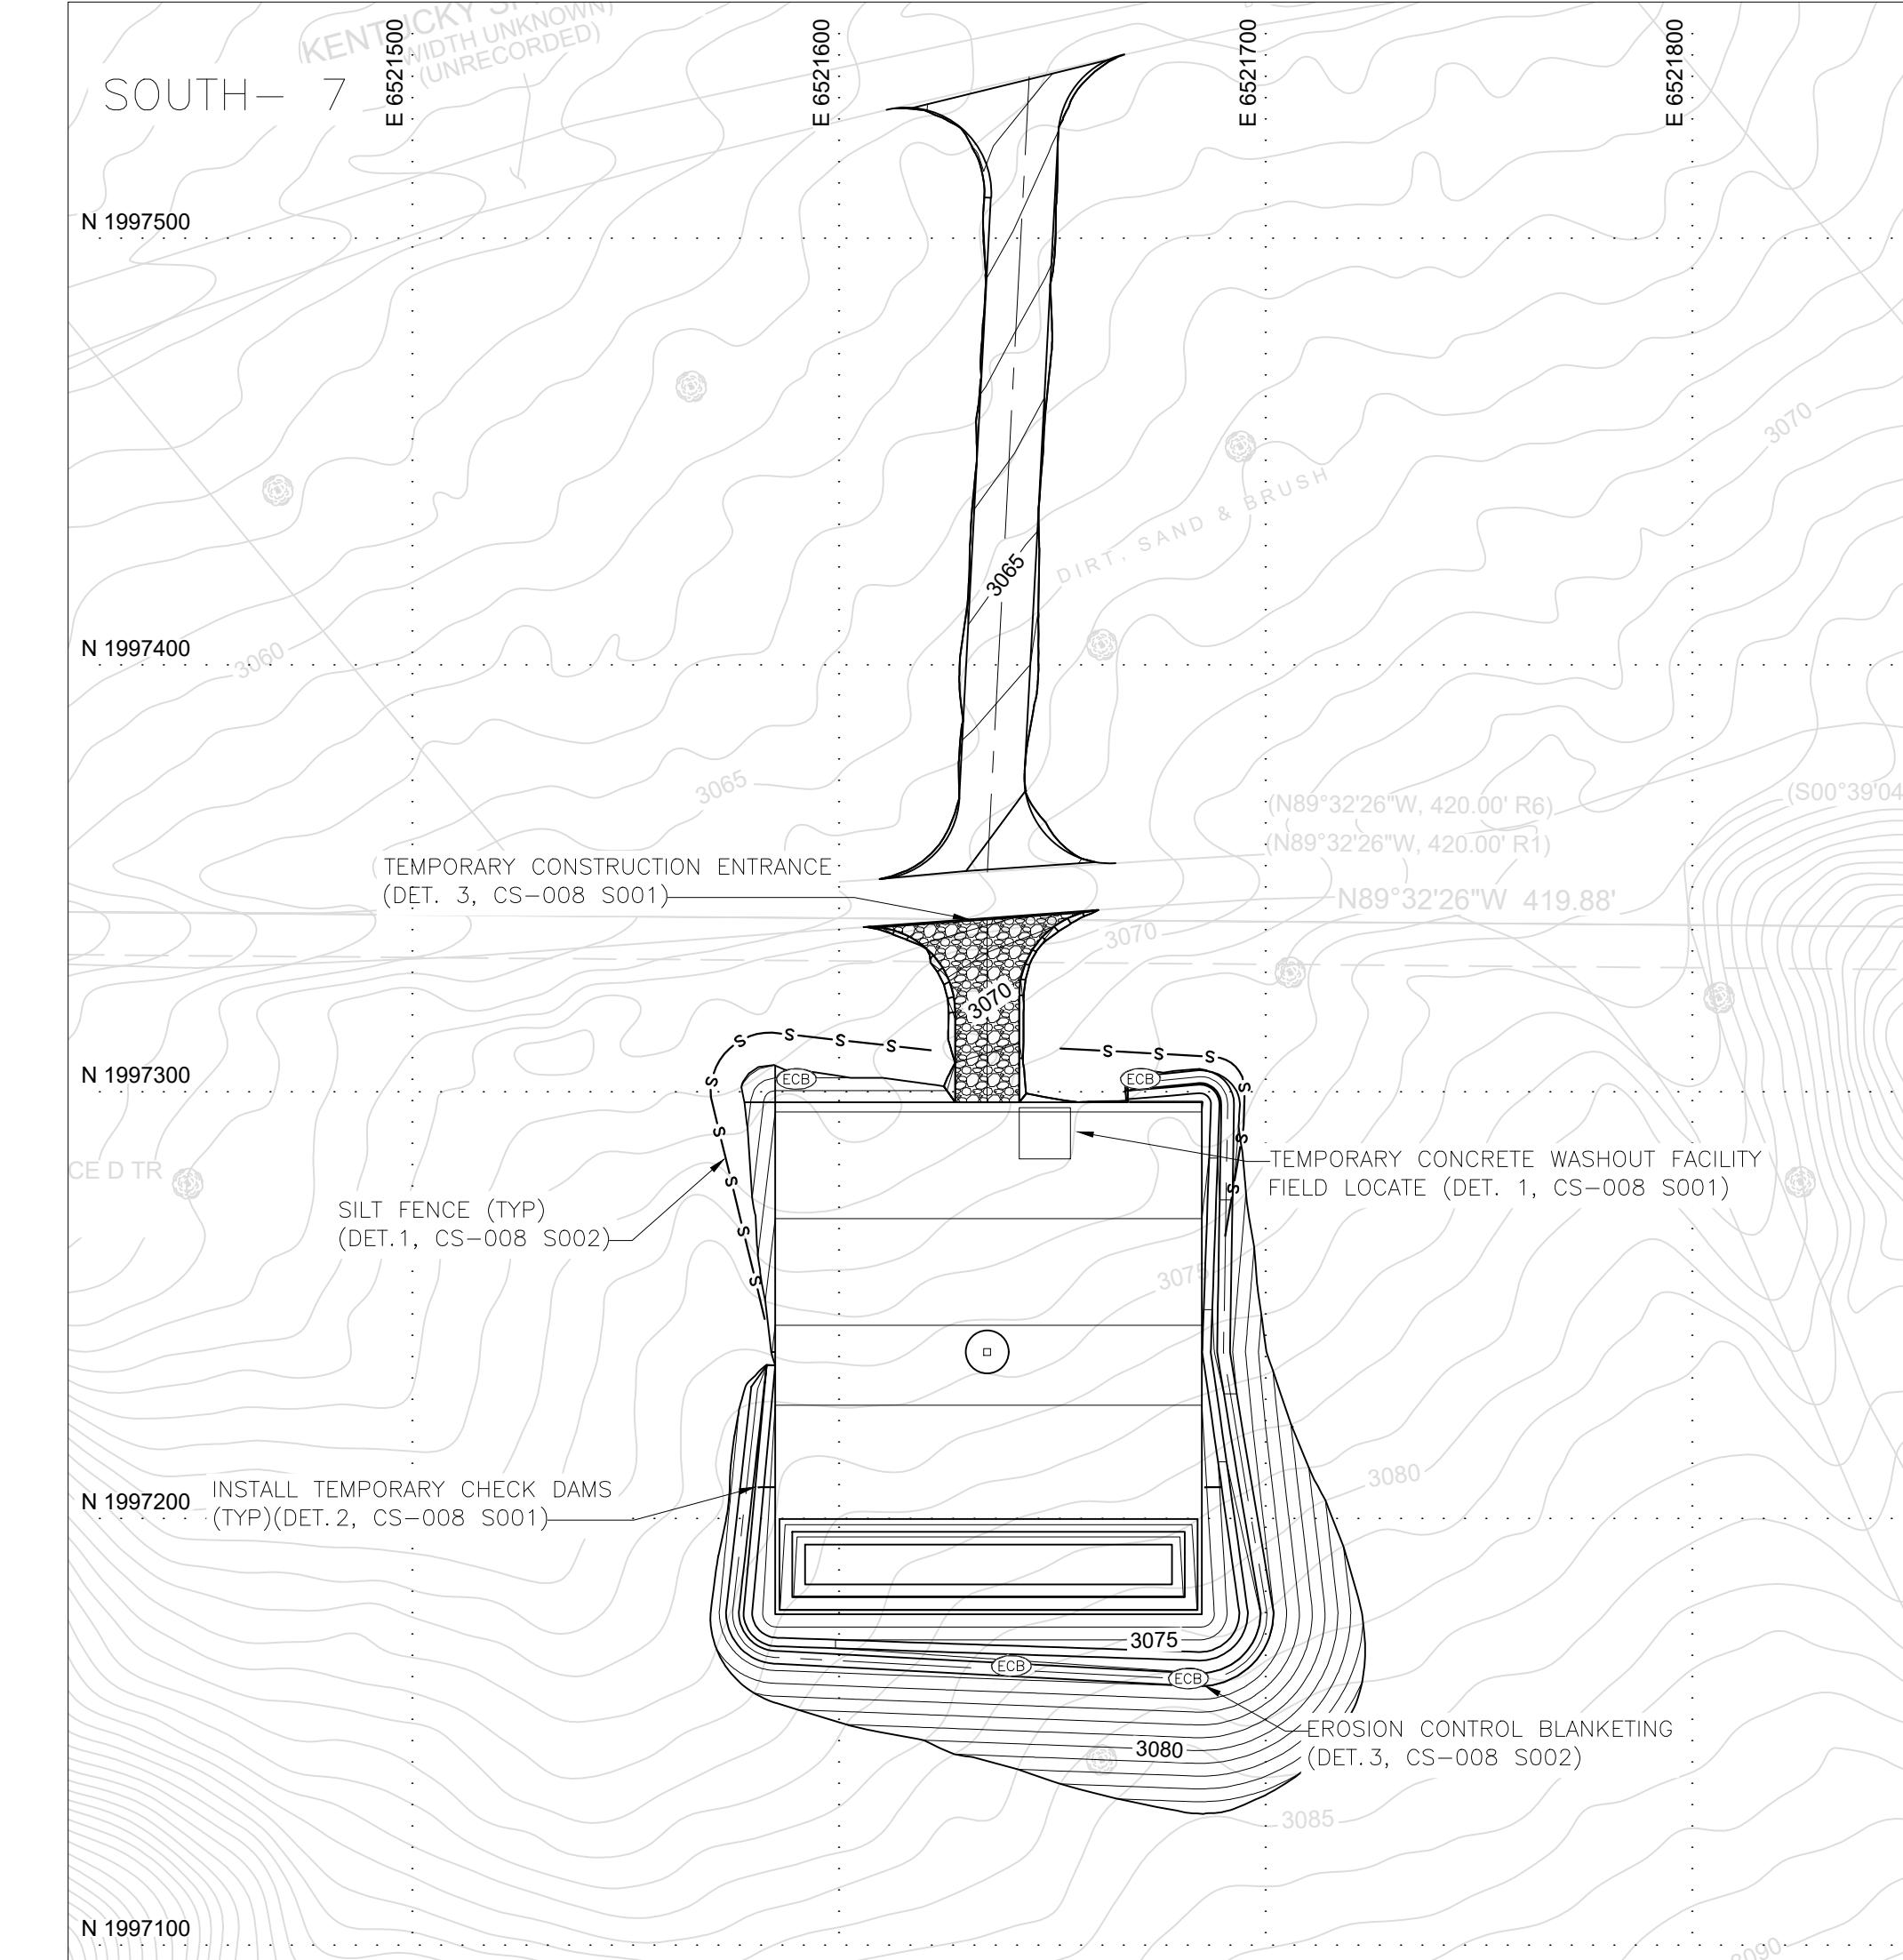
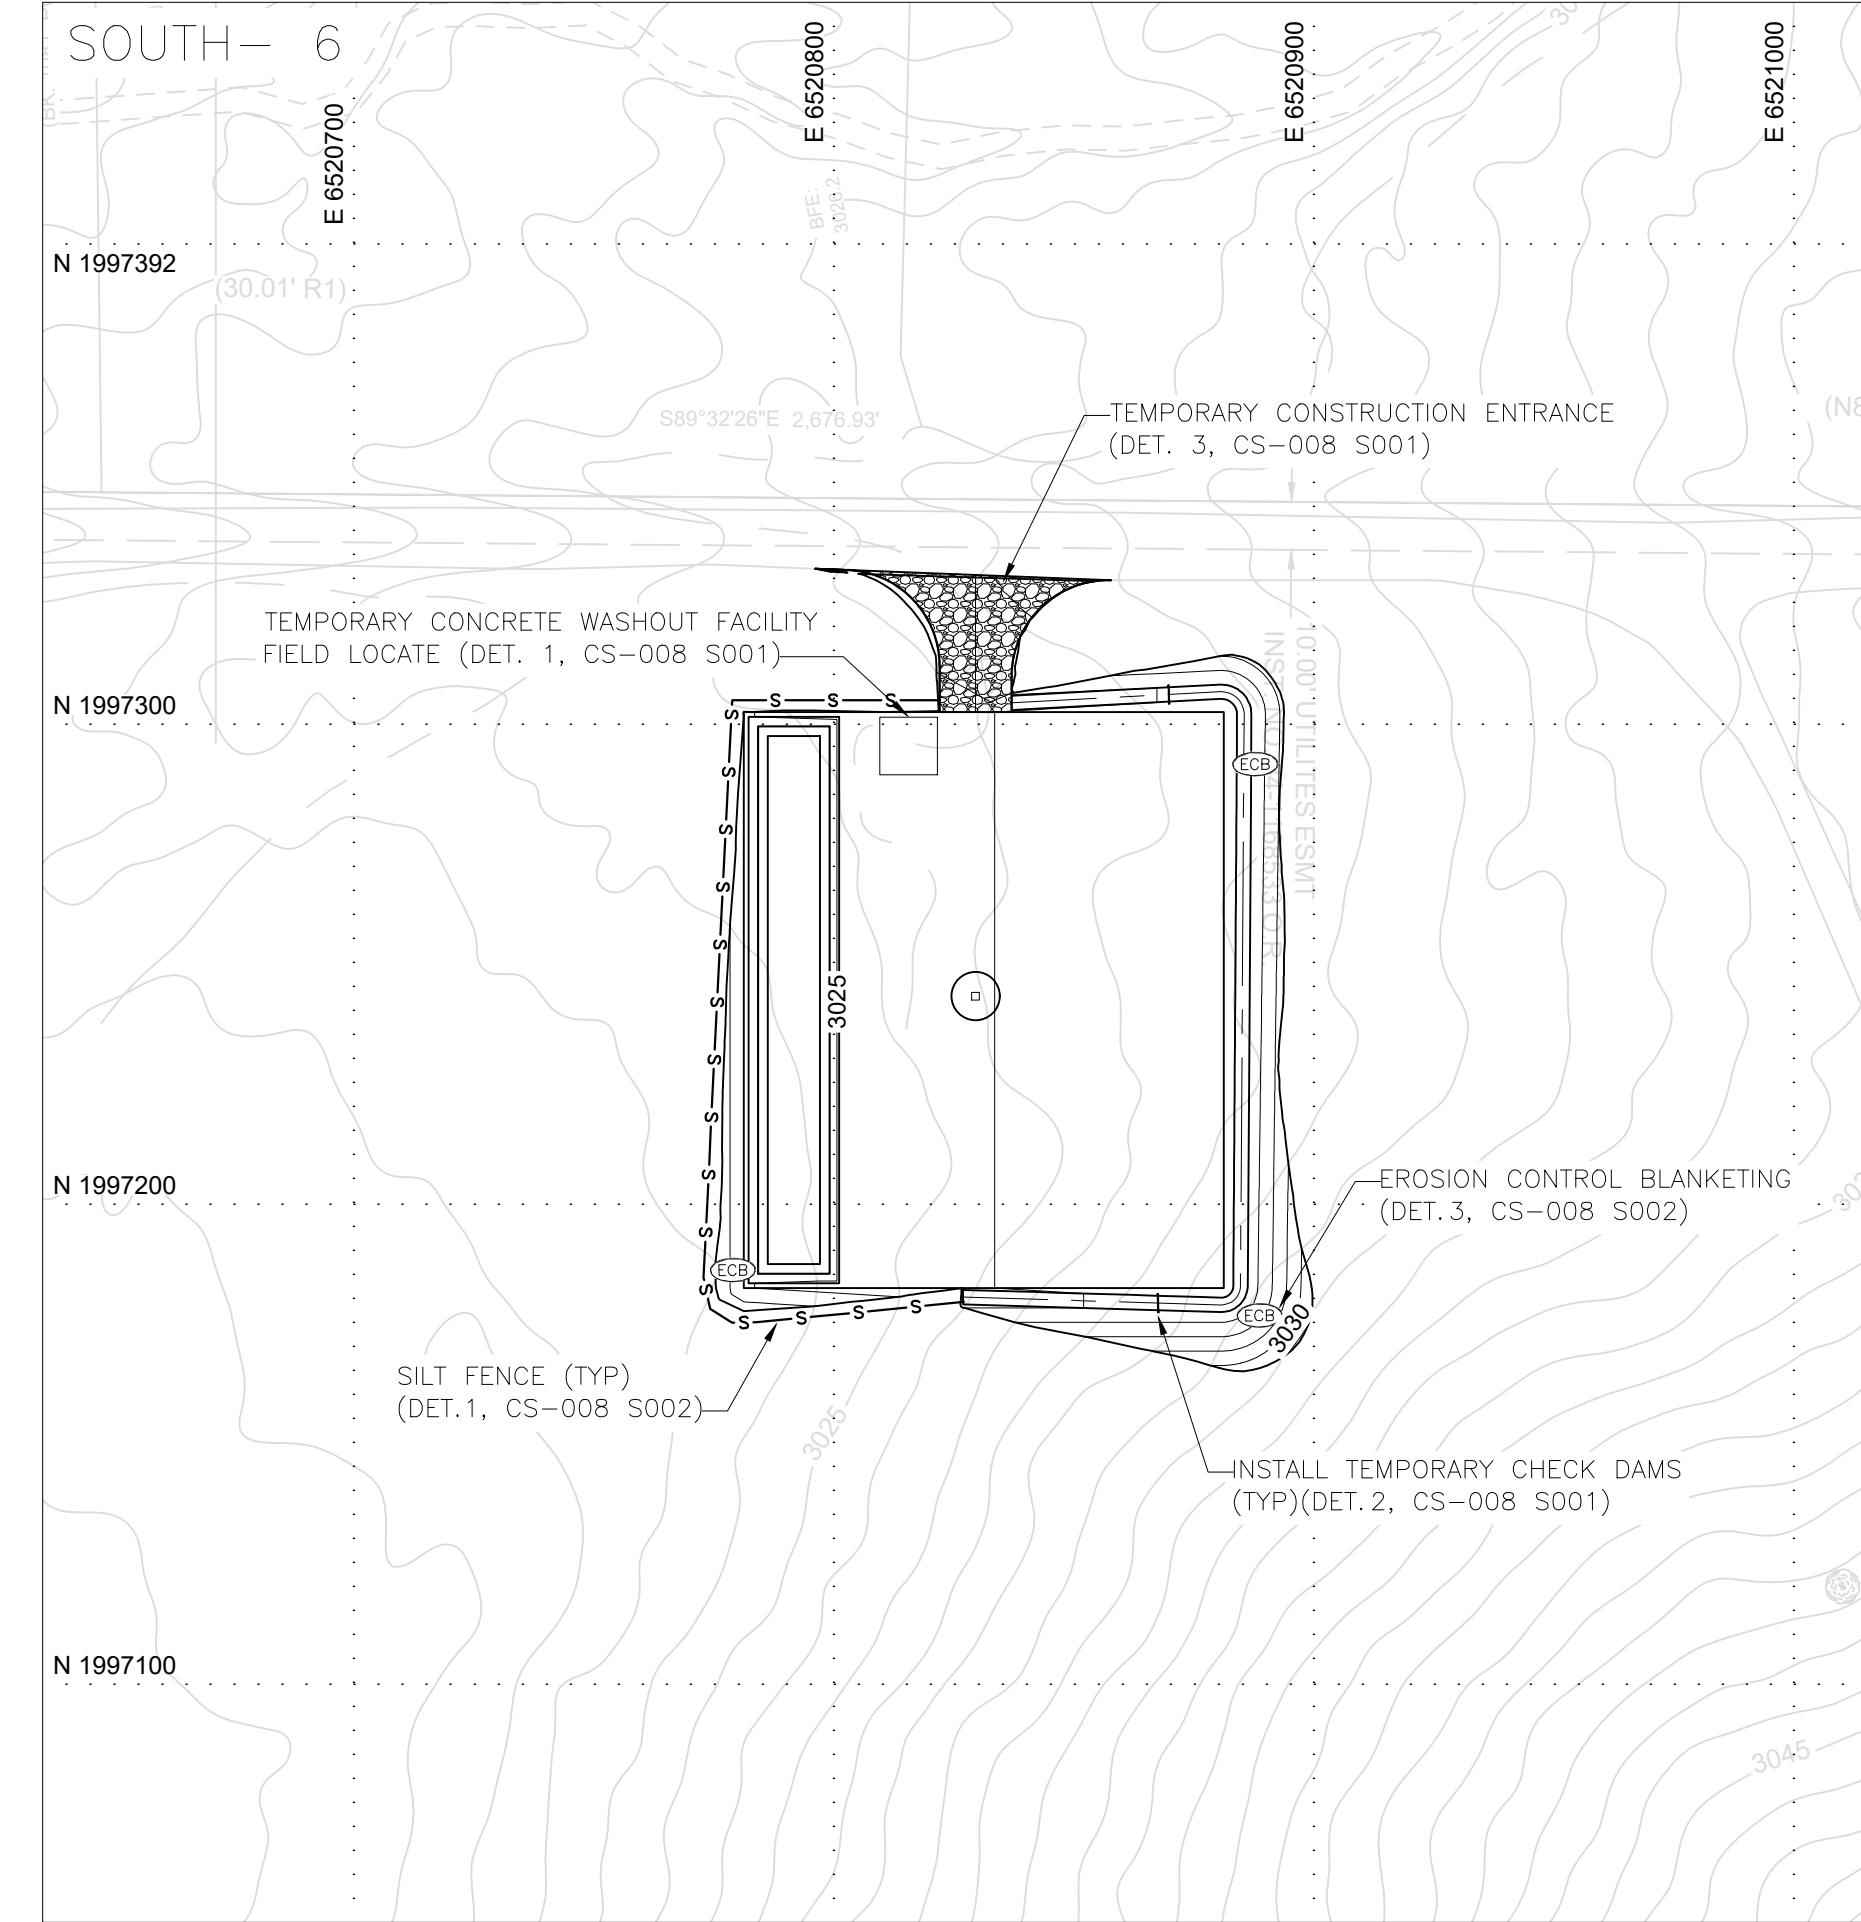
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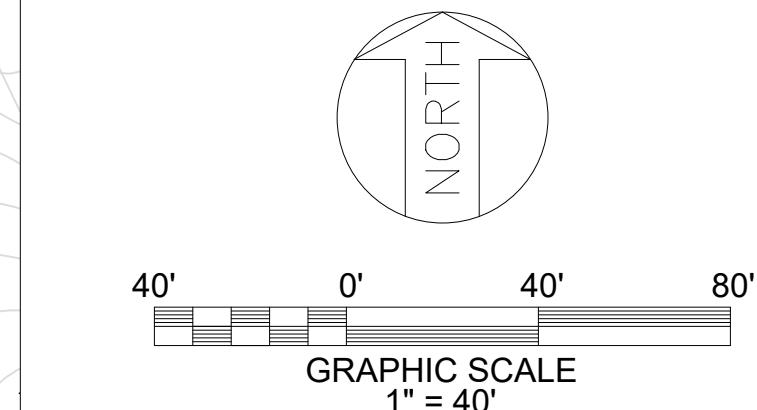
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CAD FILE NAME: PSR-CS-007 S003.DWG
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REVIEWED BY: JTP
APPROVED BY: --

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Sargent & Lundy

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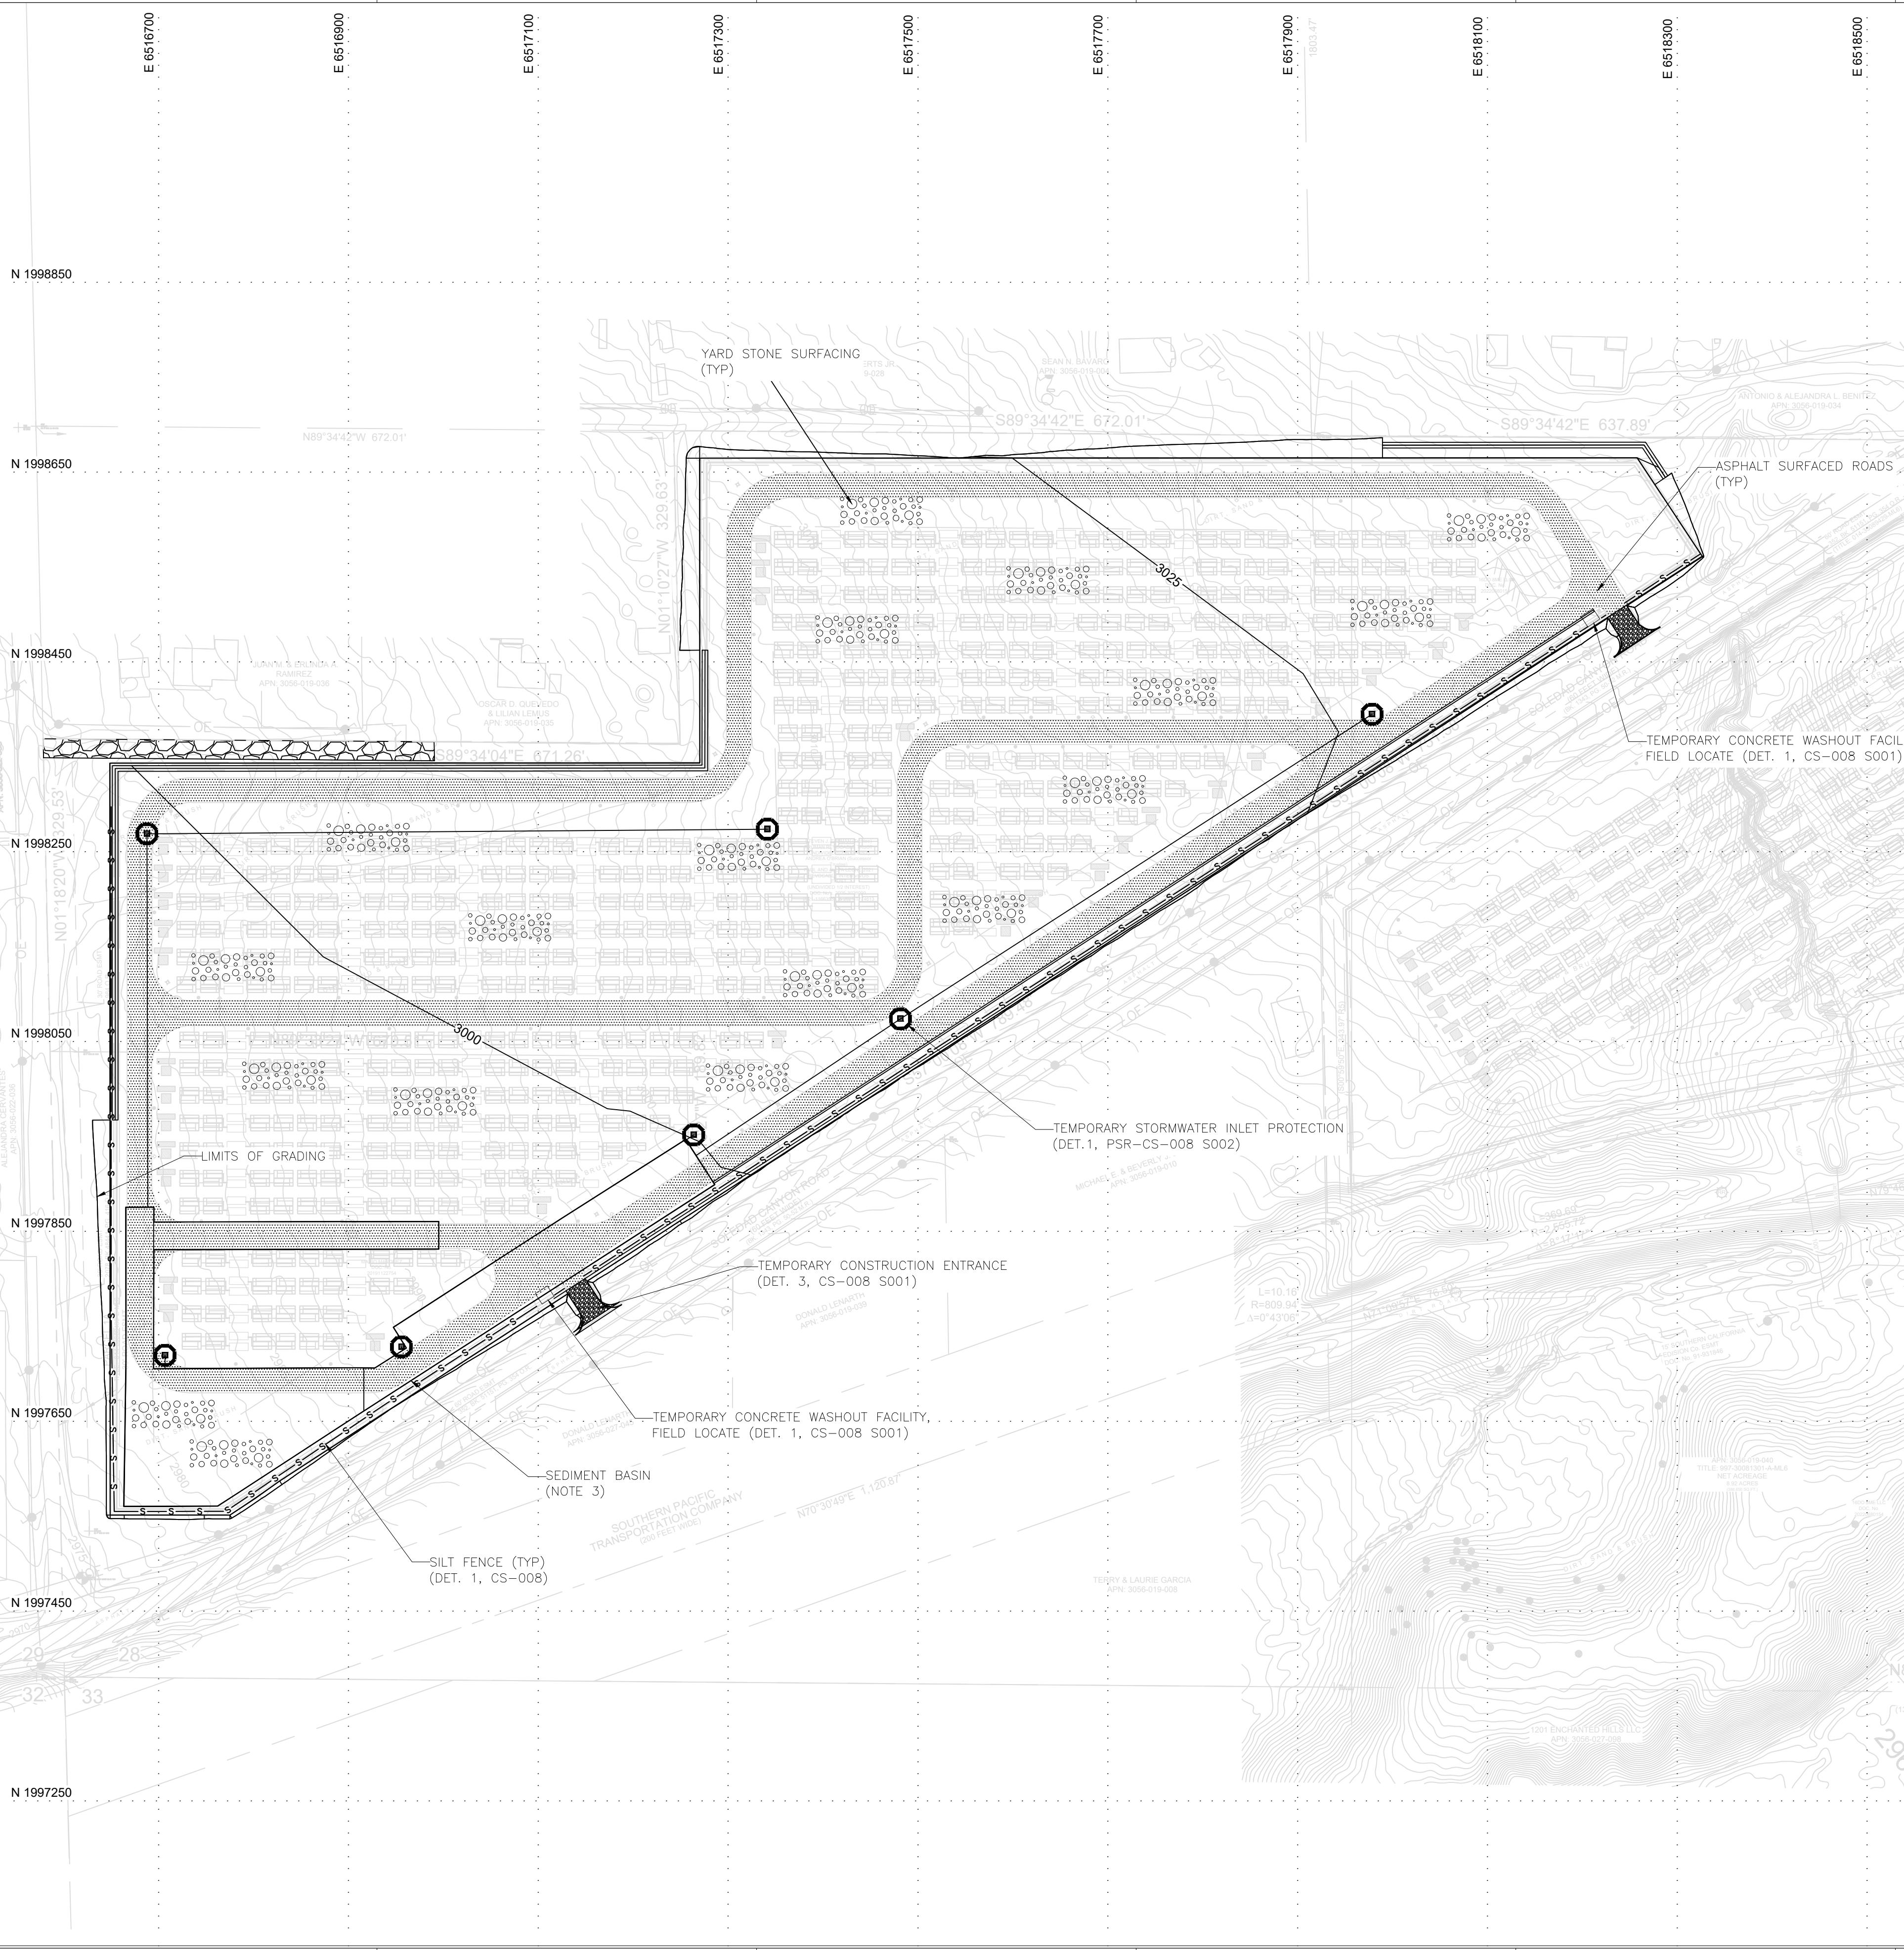
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PRAIRIE SONG RELIABILITY PROJECT

DRAWING TITLE
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DRAWING NUMBER PSR-CS-007 S003
REVISION 0C
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3. THE TEMPORARY SEDIMENT BASIN WILL BE EXCAVATED AT THE BEGINNING OF THE GRADING WORK, AND USED FOR PLACEMENT OF PERMANENT STORMWATER DRAINAGE SYSTEM CHAMBERS NEAR THE END OF CONSTRUCTION. REFER TO DRAWINGS PSR-CS-004 S011 FOR LAYOUT OF PERMANENT STORMWATER DRAINAGE SYSTEM, AND DRAWING PSR-CS-009 FOR UNDERGROUND STORMWATER DETENTION BASIN DETAILS.

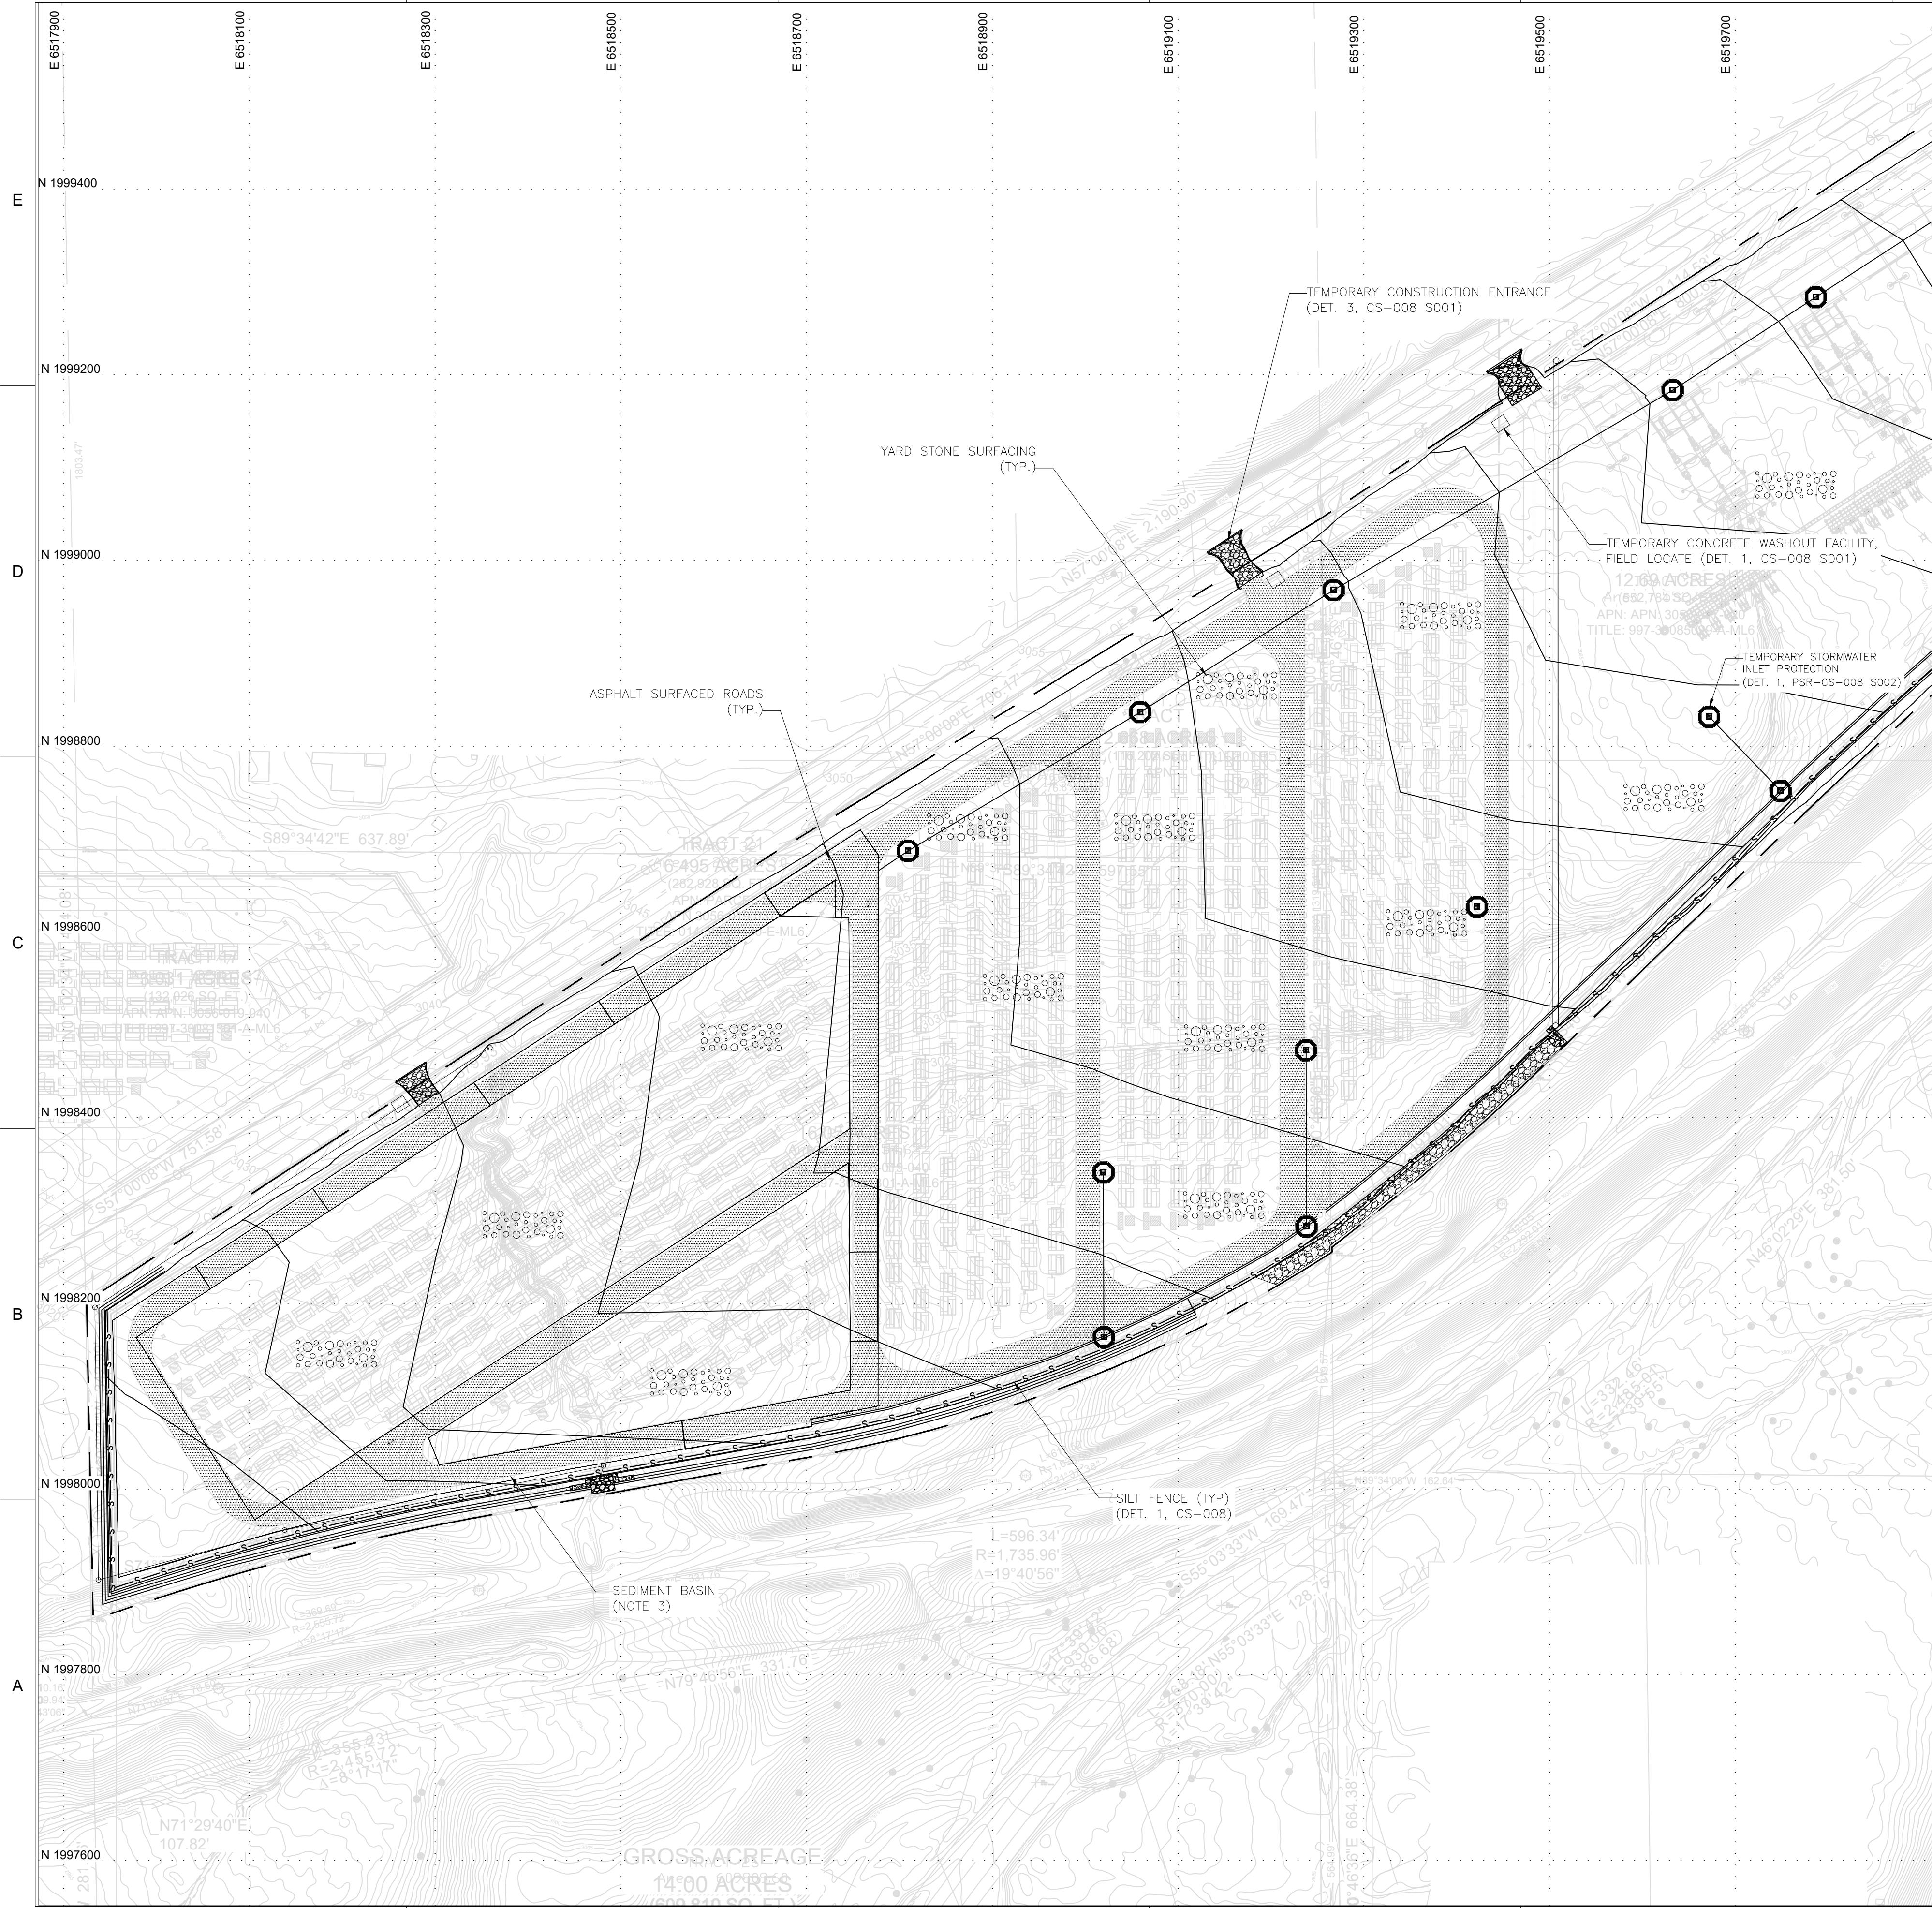
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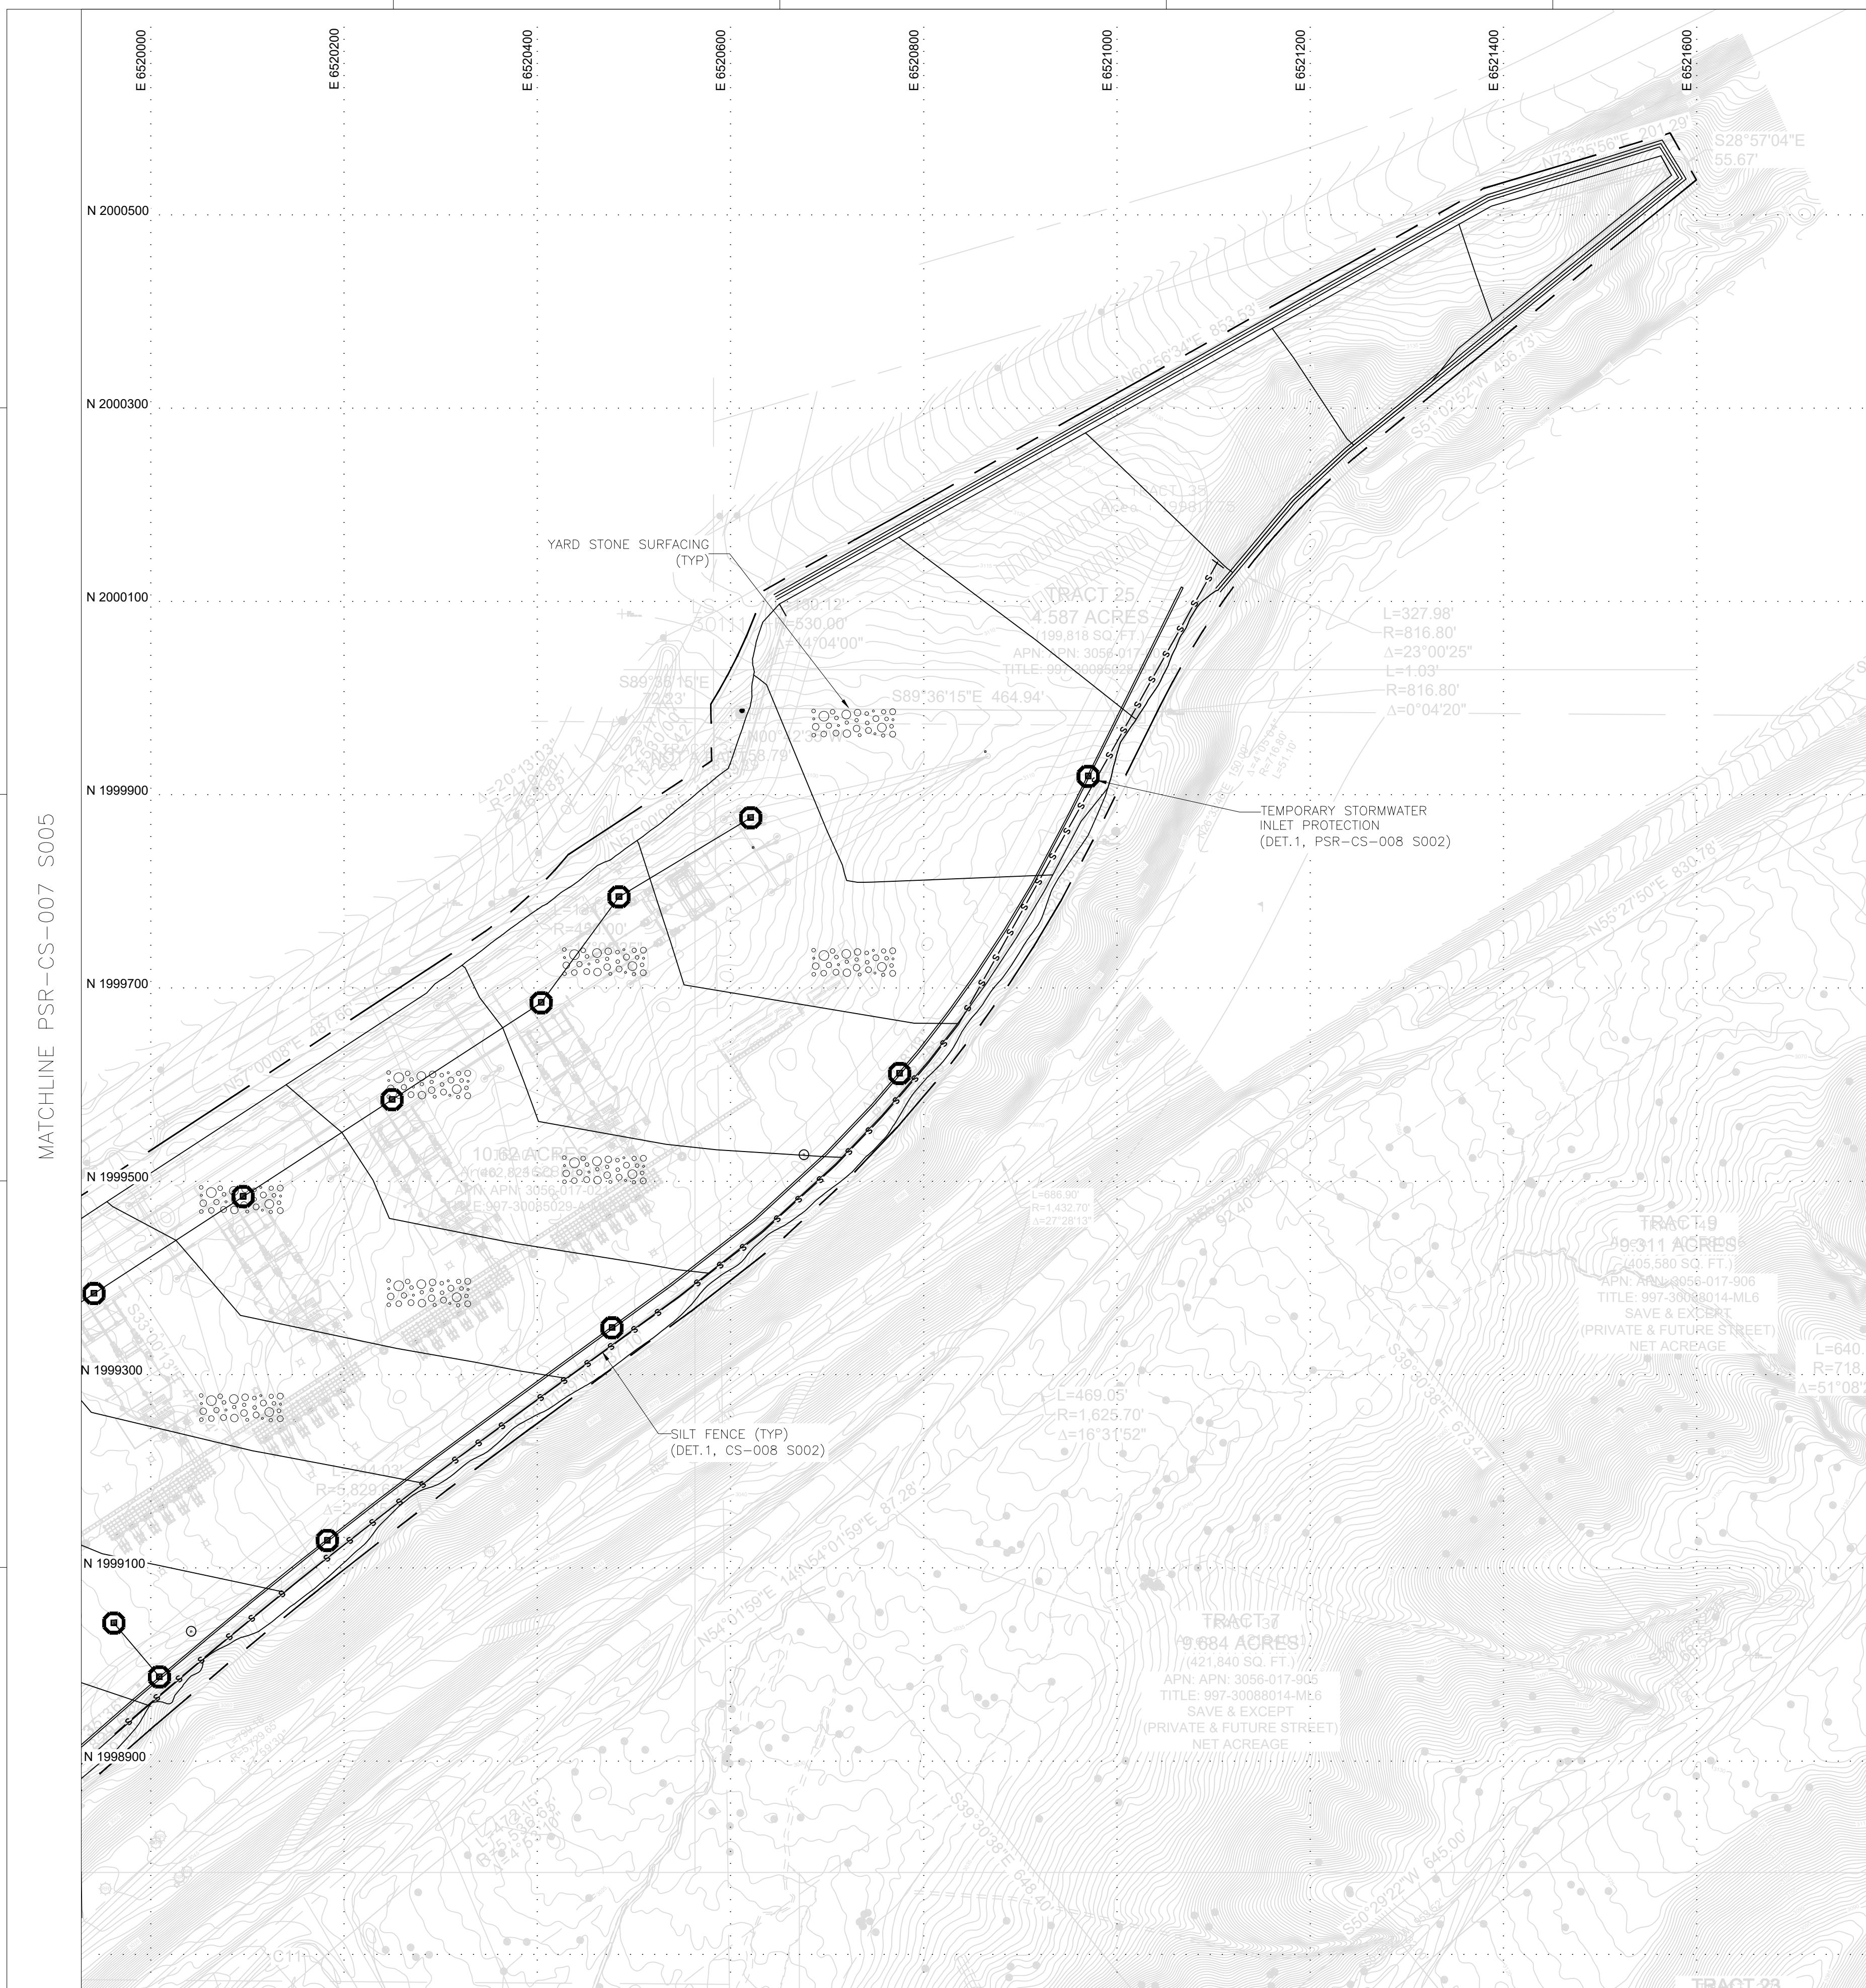
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ISSUED FOR PRELIMINARY PURPOSES JOSHUA BICKETT P.E. LICENSE #95825													
CAD FILE NAME: PSR-CS-007 S004.DWG PREPARED BY: CAF/JN REVIEWED BY: JTP APPROVED BY: --													
ANY MODIFICATION OR ADDITION TO THIS DRAWING BY AN ORGANIZATION OTHER THAN SARGENT & LUNDY, IS NOT THE RESPONSIBILITY OF SARGENT & LUNDY.													
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PROJECT													
PRAIRIE SONG RELIABILITY PROJECT													
DRAWING TITLE													
EROSION AND SEDIMENT CONTROL PLAN													
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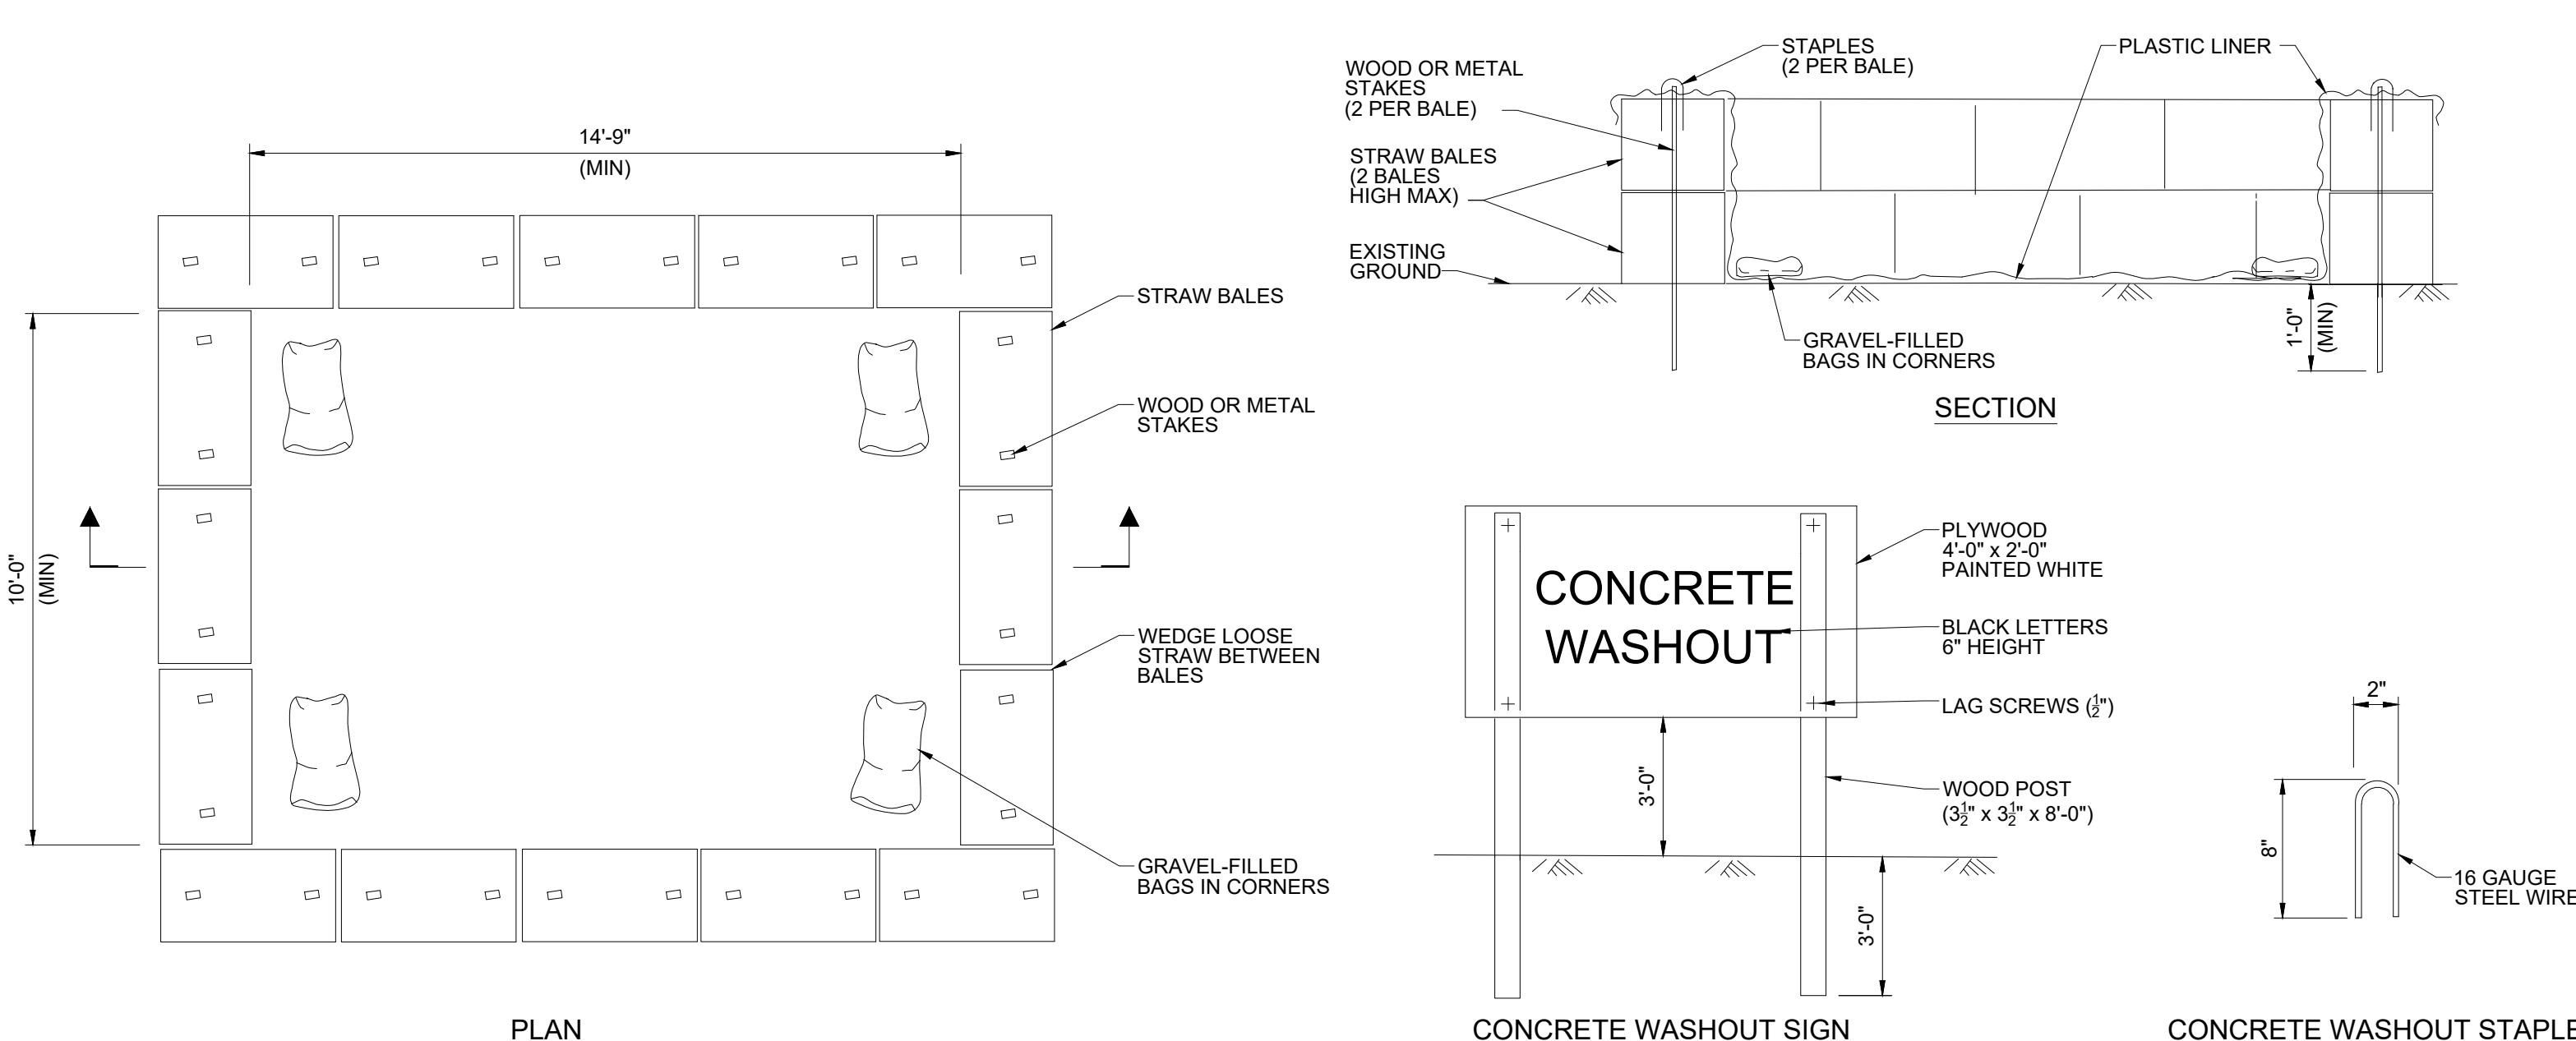
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CAD FILE NAME: PSR-CS-007 S005.DWG PREPARED BY: CAF/JN REVIEWED BY: JTP APPROVED BY: --		
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NOTES		
<ol style="list-style-type: none"> 1. GEOTECHNICAL ENGINEERING REPORT PREPARED BY: TERRACON CONSULTANTS INC., PROJECT NO. LA245085, DATED 05-14-2025. 2. FOR GENERAL NOTES, ABBREVIATIONS AND LEGEND SEE DRAWING PSR-CS-002. 3. THE TEMPORARY SEDIMENT BASIN WILL BE EXCAVATED AT THE BEGINNING OF THE GRADING WORK, AND USED FOR PLACEMENT OF PERMANENT STORMWATER DRAINAGE SYSTEM CHAMBERS NEAR THE END OF CONSTRUCTION. REFER TO DRAWINGS PSR-CS-004 S011 FOR LAYOUT OF PERMANENT STORMWATER DRAINAGE SYSTEM, AND DRAWING PSR-CS-009 FOR UNDERGROUND STORMWATER DETENTION BASIN DETAILS. 		
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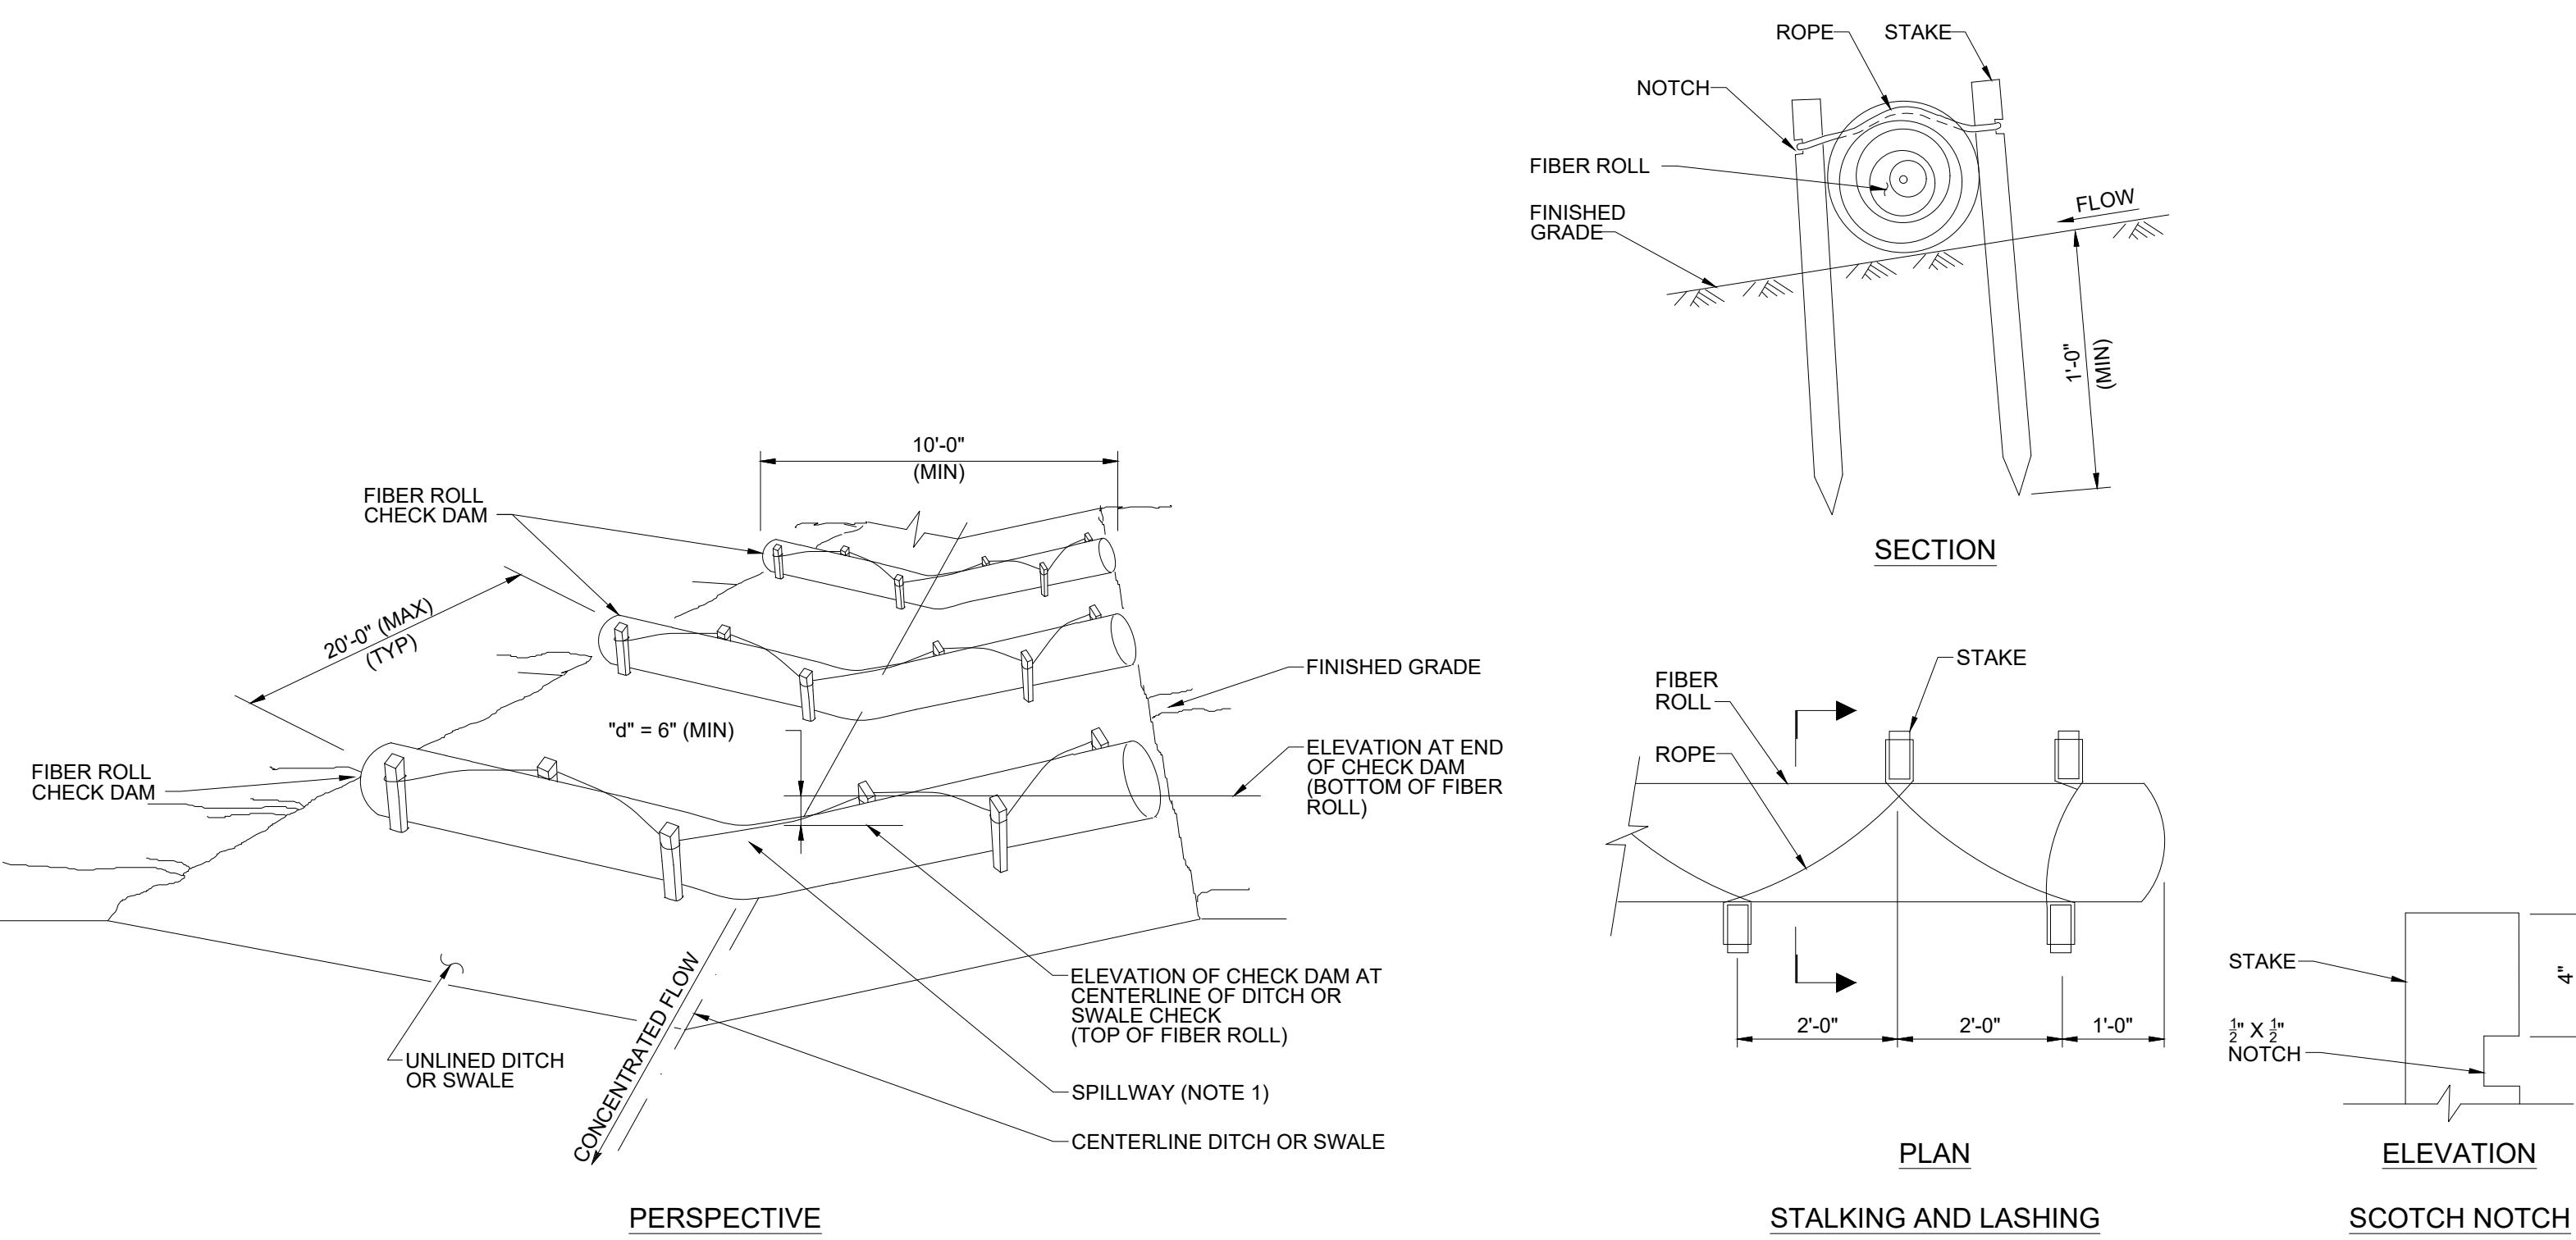
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<p>CAD FILE NAME: PSR-CS-008 S001.DWG PREPARED BY: CAF/JN REVIEWED BY: JTP APPROVED BY: --</p>		
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TEMPORARY CONCRETE WASHOUT FACILITY

DETAIL 1

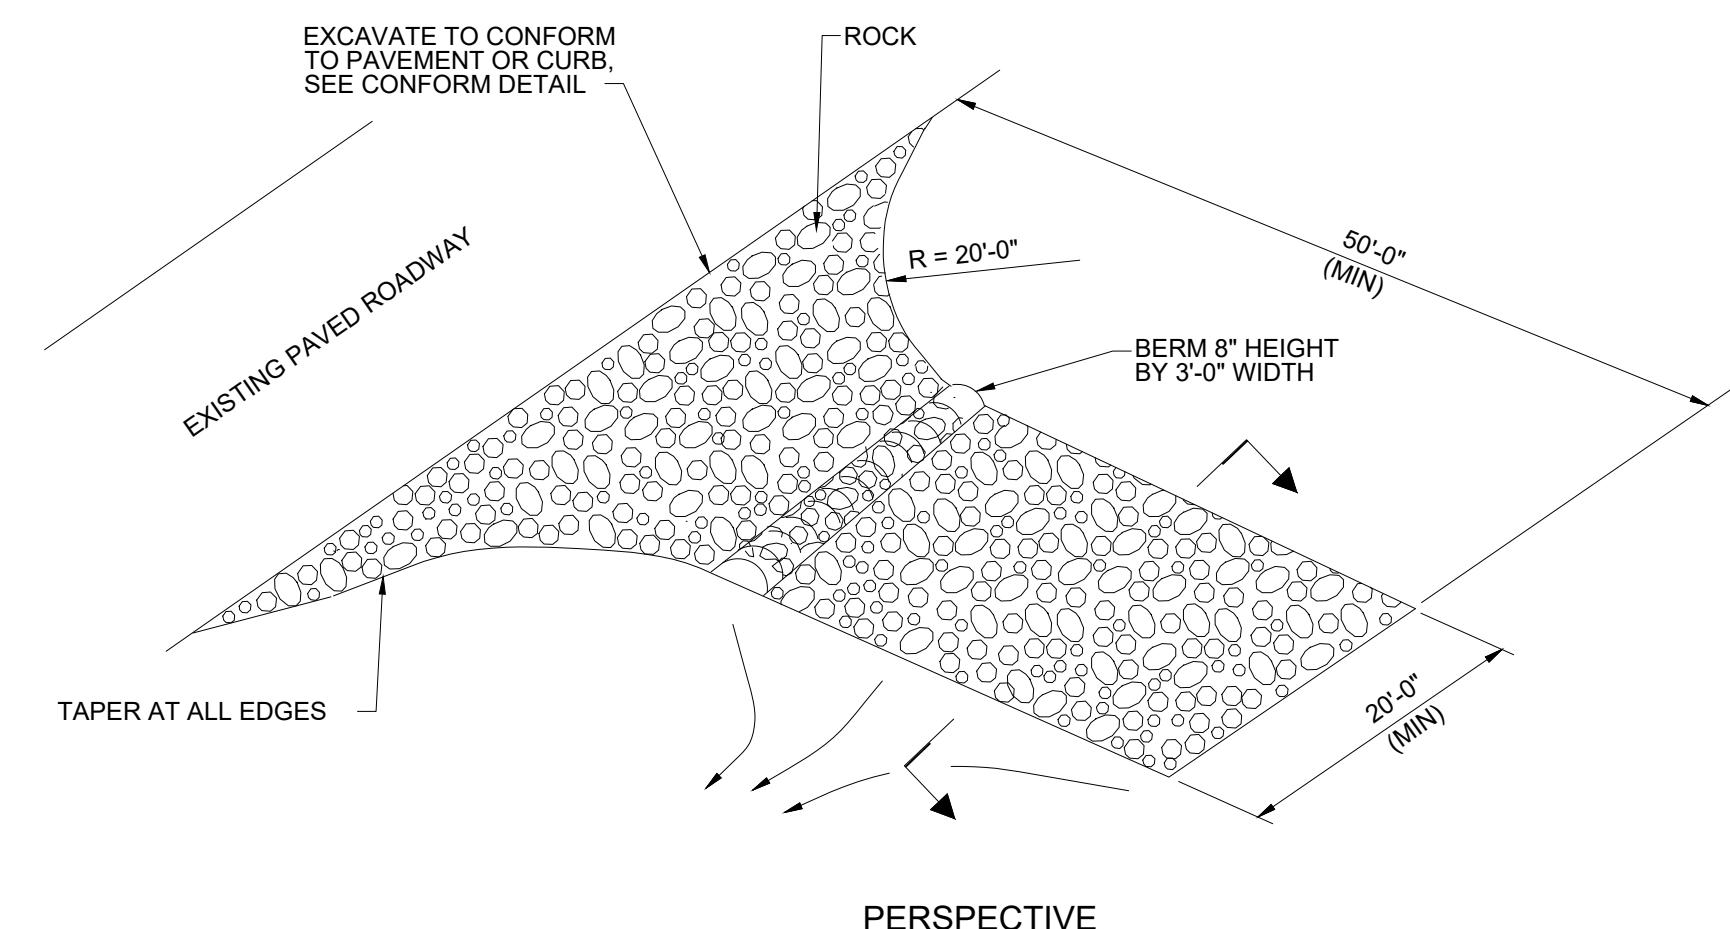
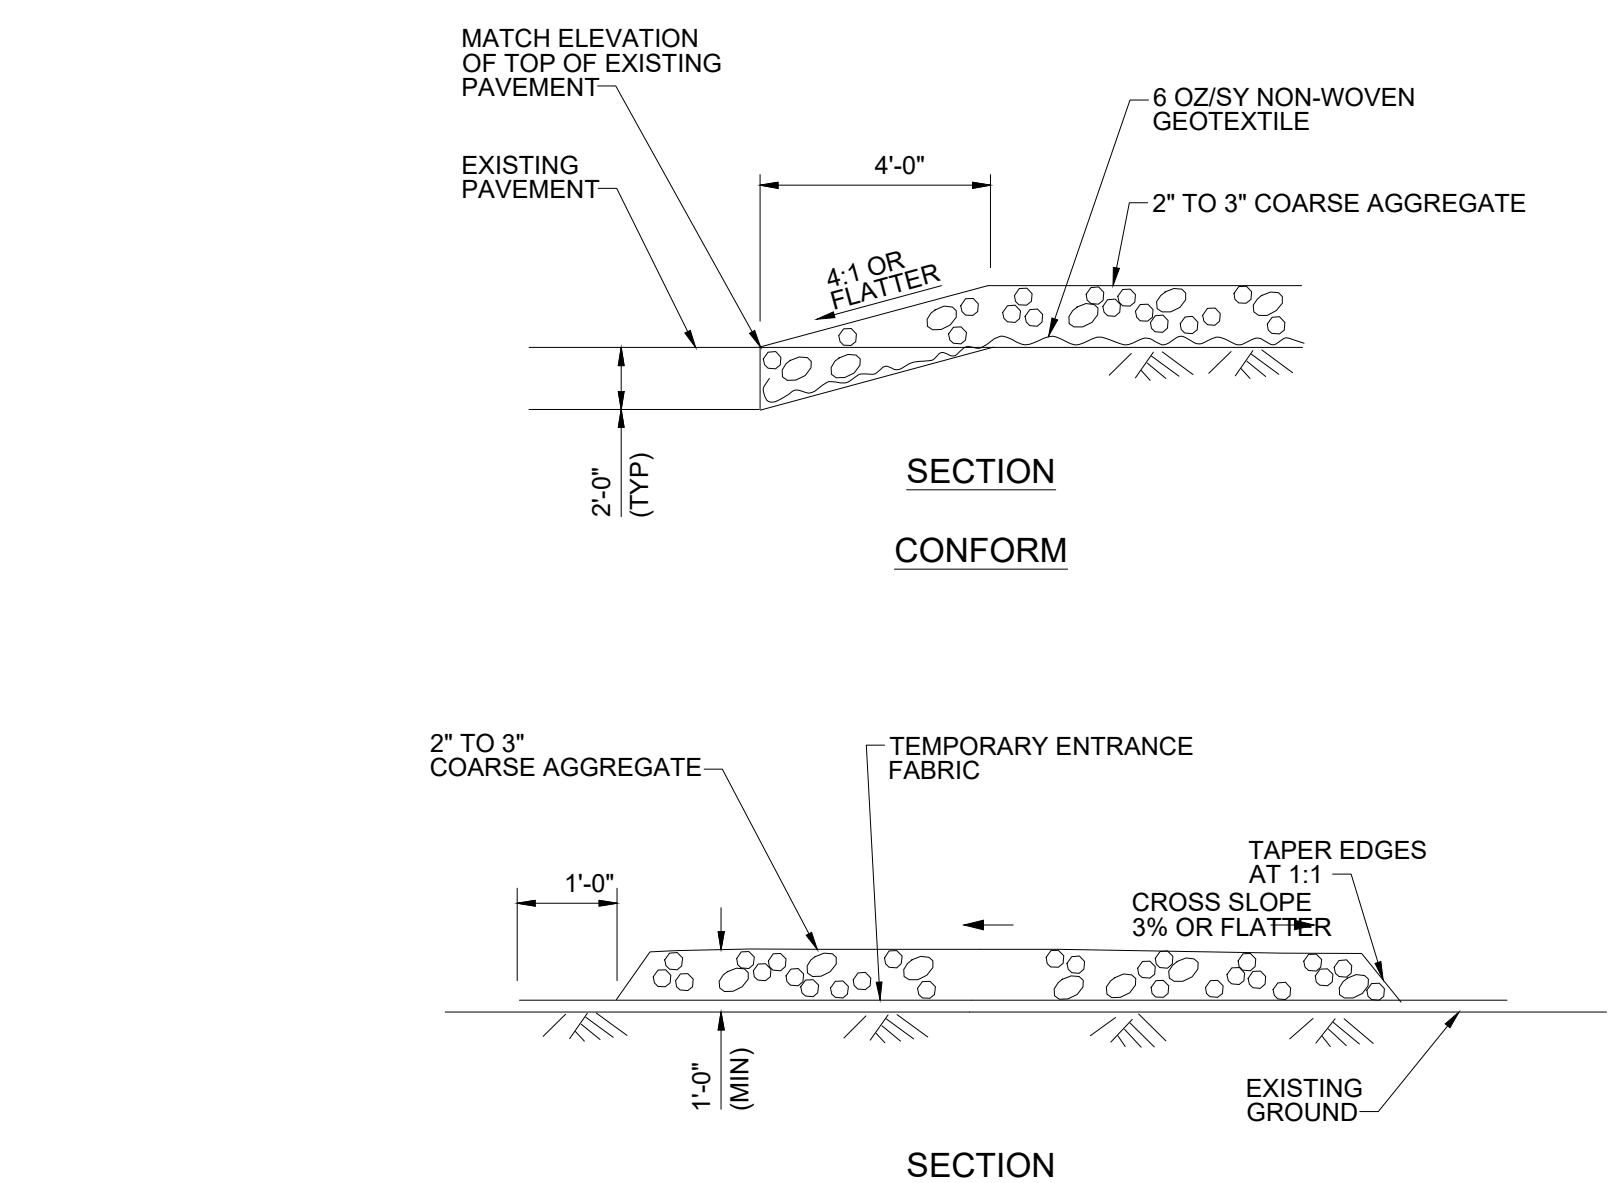


TEMPORARY CHECK DAM

DETAIL 2

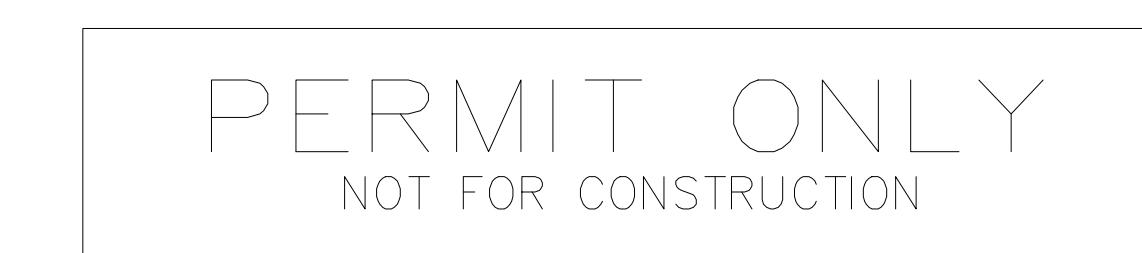
DETAIL 2 NOTES

1. SPILLWAY DEPTH "D" SHALL BE MAINTAINED TO PREVENT FLANKING OF CONCENTRATED FLOW AROUND THE ENDS OF EACH CHECK DAM



TEMPORARY CONSTRUCTION ENTRANCE

DETAIL 3



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SARGENT & LUNDY
55 EAST MONROE STREET
CHICAGO, ILLINOIS 60603 5780

BAIRIE SONG RELIABILITY PROJECT

DRAWING TITLE

EROSION AND SEDIMENT CONTROL DETAILS

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ISSUE PURPOSE: ISSUED FOR PERMIT

SPECIFICATION: -

PROJECT NO.: 14089-012

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ISSUED FOR PRELIMINARY PURPOSES
JOSHUA BICKETT
P.E. LICENSE #95825

CAD FILE NAME: PSR-CS-009.DWG

PREPARED BY: CAF/JN

REVIEWED BY: JTP

APPROVED BY: --

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SARGENT & LUNDY
55 EAST MONROE STREET
CHICAGO, ILLINOIS 60603-5780

PROJECT

PRAIRIE SONG RELIABILITY PROJECT

DRAWING TITLE

UNDERGROUND STORMWATER DETENTION BASIN DETAIL

DRAWING NUMBER

PSR-CS-009

0C

REVISION

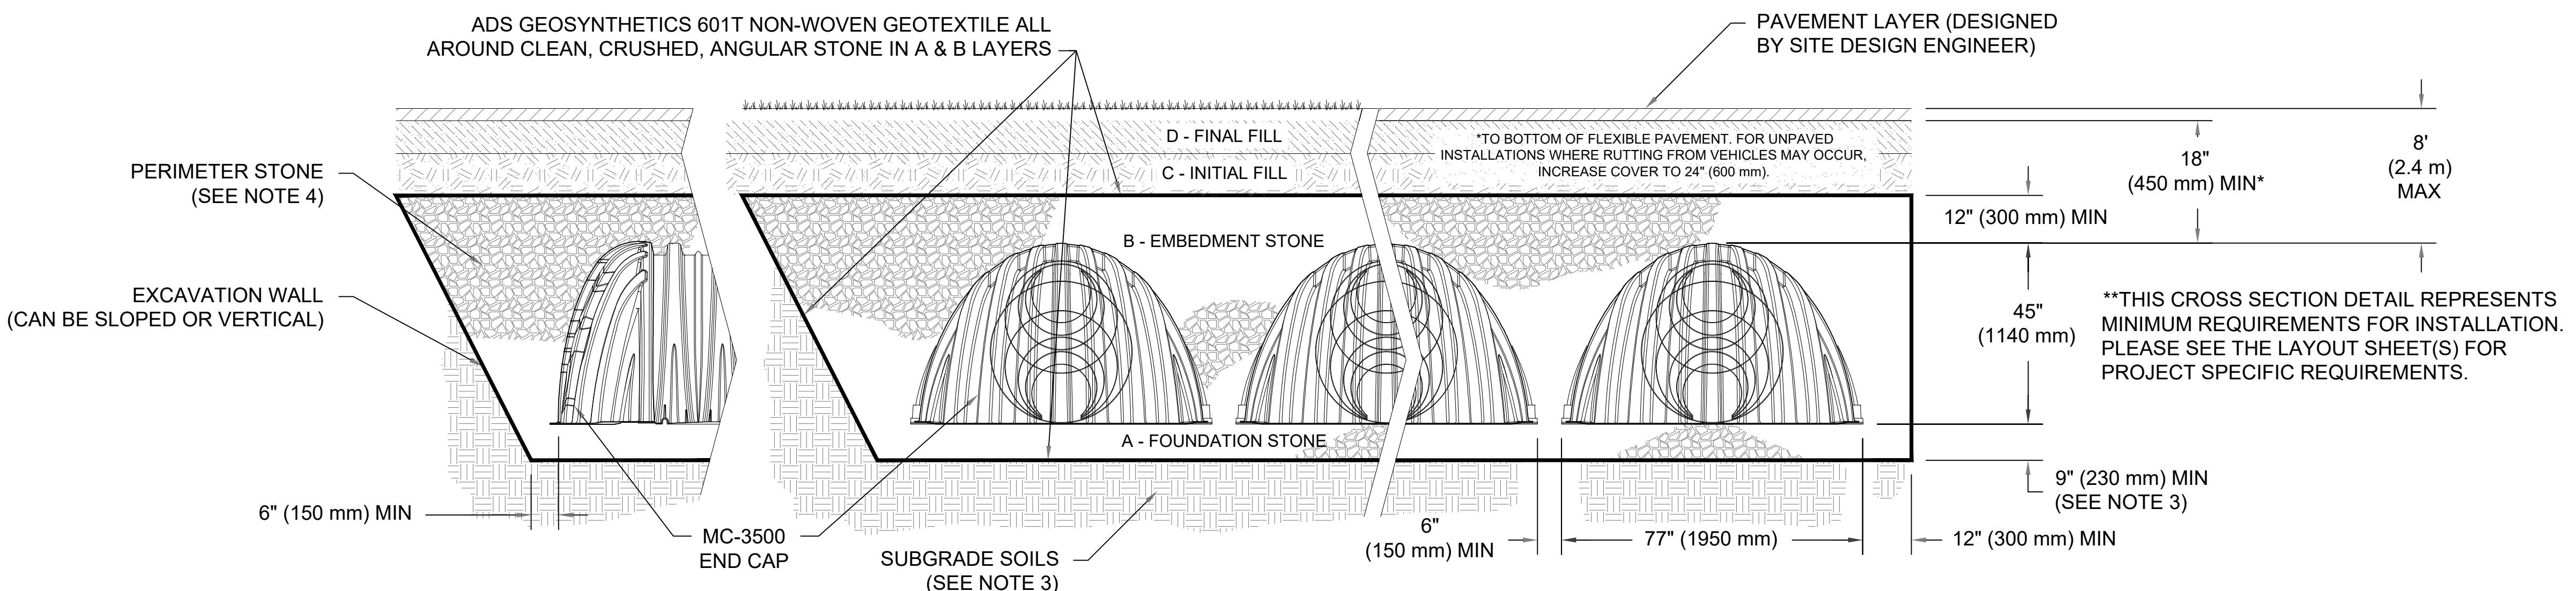
SHEET 1 OF 1

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DETAIL 1
N.T.S.

NOTES:

1. CHAMBERS SHALL MEET THE REQUIREMENTS OF ASTM F2418, "STANDARD SPECIFICATION FOR POLYPROPYLENE (PP) CORRUGATED WALL STORMWATER COLLECTION CHAMBERS" CHAMBER CLASSIFICATION 45x76 DESIGNATION SS.
2. MC-3500 CHAMBERS SHALL BE DESIGNED IN ACCORDANCE WITH ASTM F2787 "STANDARD PRACTICE FOR STRUCTURAL DESIGN OF THERMOPLASTIC CORRUGATED WALL STORMWATER COLLECTION CHAMBERS".
3. THE SITE DESIGN ENGINEER IS RESPONSIBLE FOR ASSESSING THE BEARING RESISTANCE (ALLOWABLE BEARING CAPACITY) OF THE SUBGRADE SOILS AND THE DEPTH OF THE FOUNDATION STONE WITH CONSIDERATION FOR THE RANGE OF EXPECTED SOIL MOISTURE CONDITIONS. REFERENCE STORMTECH DESIGN MANUAL FOR BEARING CAPACITY GUIDANCE.
4. PERIMETER STONE MUST BE EXTENDED HORIZONTALLY TO THE EXCAVATION WALL FOR BOTH VERTICAL AND SLOPED EXCAVATION WALLS.
5. REQUIREMENTS FOR HANDLING AND INSTALLATION:
 - 5.1. TO MAINTAIN THE WIDTH OF CHAMBERS DURING SHIPPING AND HANDLING, CHAMBERS SHALL HAVE INTEGRAL, INTERLOCKING STACKING LUGS.
 - 5.2. TO ENSURE A SECURE JOINT DURING INSTALLATION AND BACKFILL, THE HEIGHT OF THE CHAMBER JOINT SHALL NOT BE LESS THAN 3".
 - 5.3. TO ENSURE THE INTEGRITY OF THE ARCH SHAPE DURING INSTALLATION:
 - 5.3.1. THE ARCH STIFFNESS CONSTANT SHALL BE GREATER THAN OR EQUAL TO 450 LBS/FT%. THE ASC IS DEFINED IN SECTION 6.2.8 OF ASTM F2418.
 - 5.3.2. TO RESIST CHAMBER DEFORMATION DURING INSTALLATION AT ELEVATED TEMPERATURES (ABOVE 73°F / 23°C), CHAMBERS SHALL BE PRODUCED FROM REFLECTIVE GOLD OR YELLOW COLORS.
6. STONE MATERIAL FOR LAYERS "A" AND "B" SHALL BE CLEAN, CRUSHED ANGULAR STONE MEETING THE GRADATION REQUIREMENTS OF AASHTO M43, GRADATION NO. 57.
7. STONE MATERIAL FOR LAYER "C" SHALL BE CALTRANS CLASS 2 BASE MATERIAL.
8. LAYER "D" SHALL CONSIST OF EITHER CLASS 2 BASE MATERIAL OR ASPHALT PAVING PER DETAILS 1 AND 2 ON DRAWING PSR-CS-006 SH001.

PERMIT ONLY
NOT FOR CONSTRUCTION

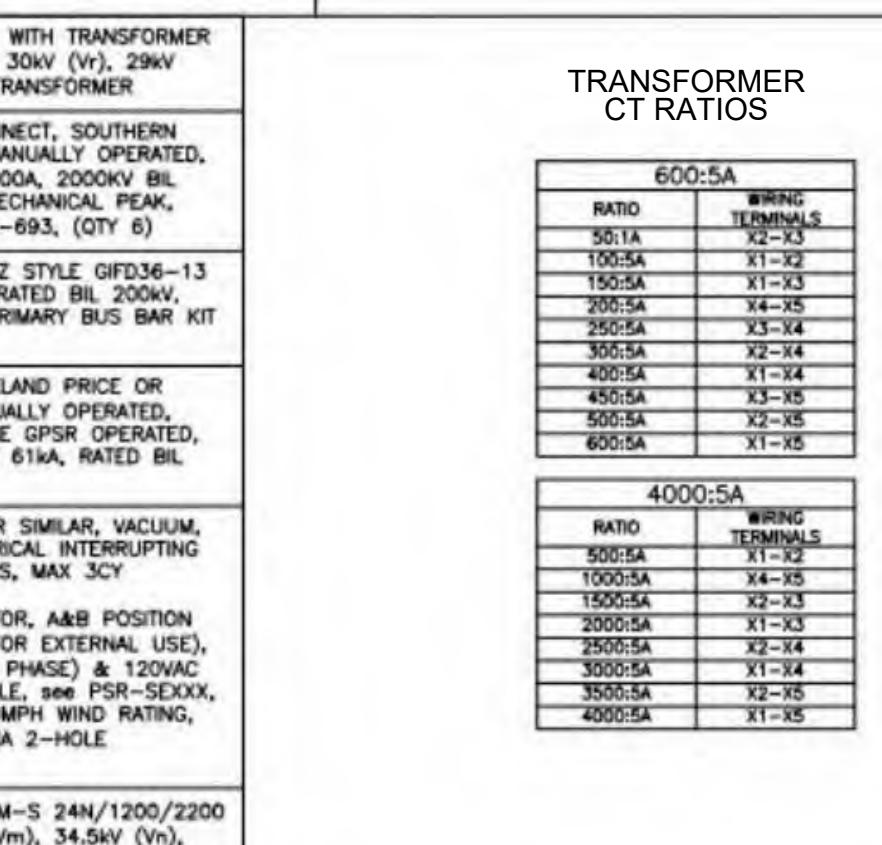
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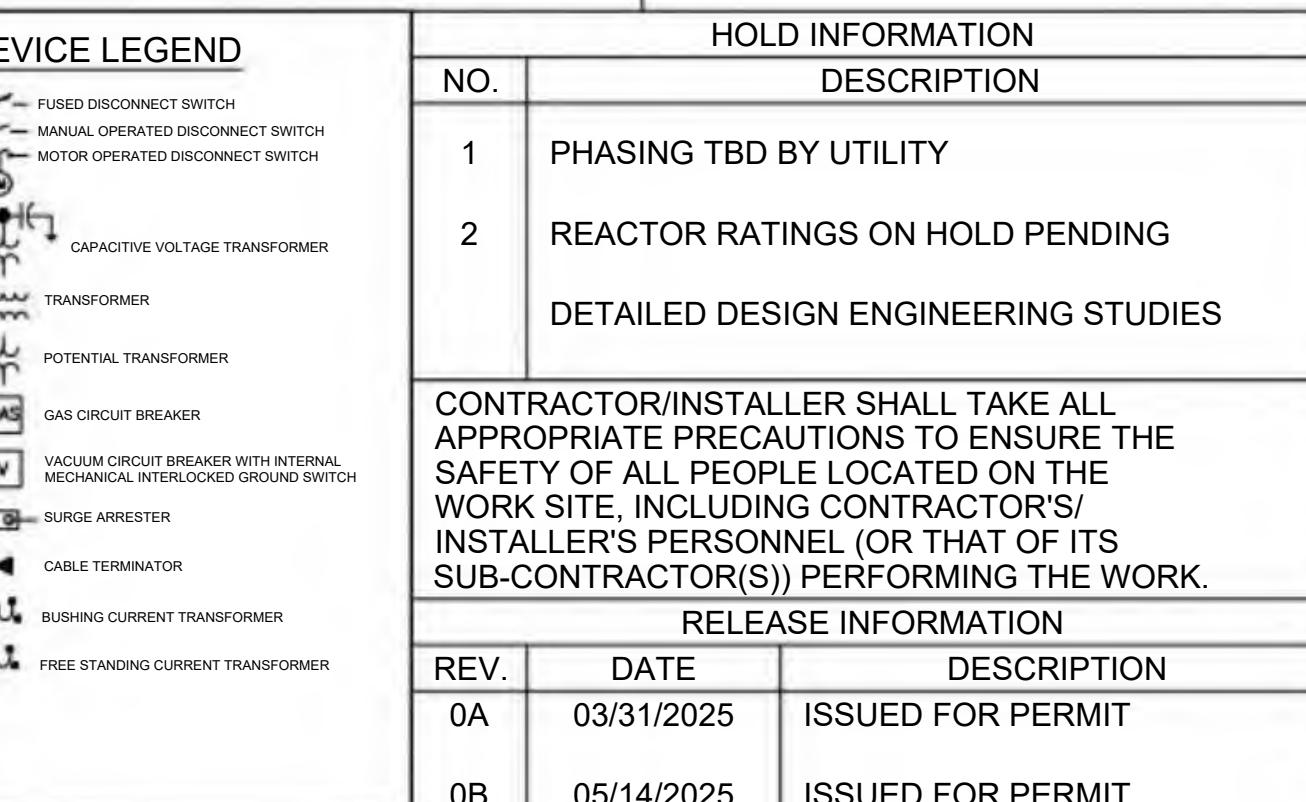
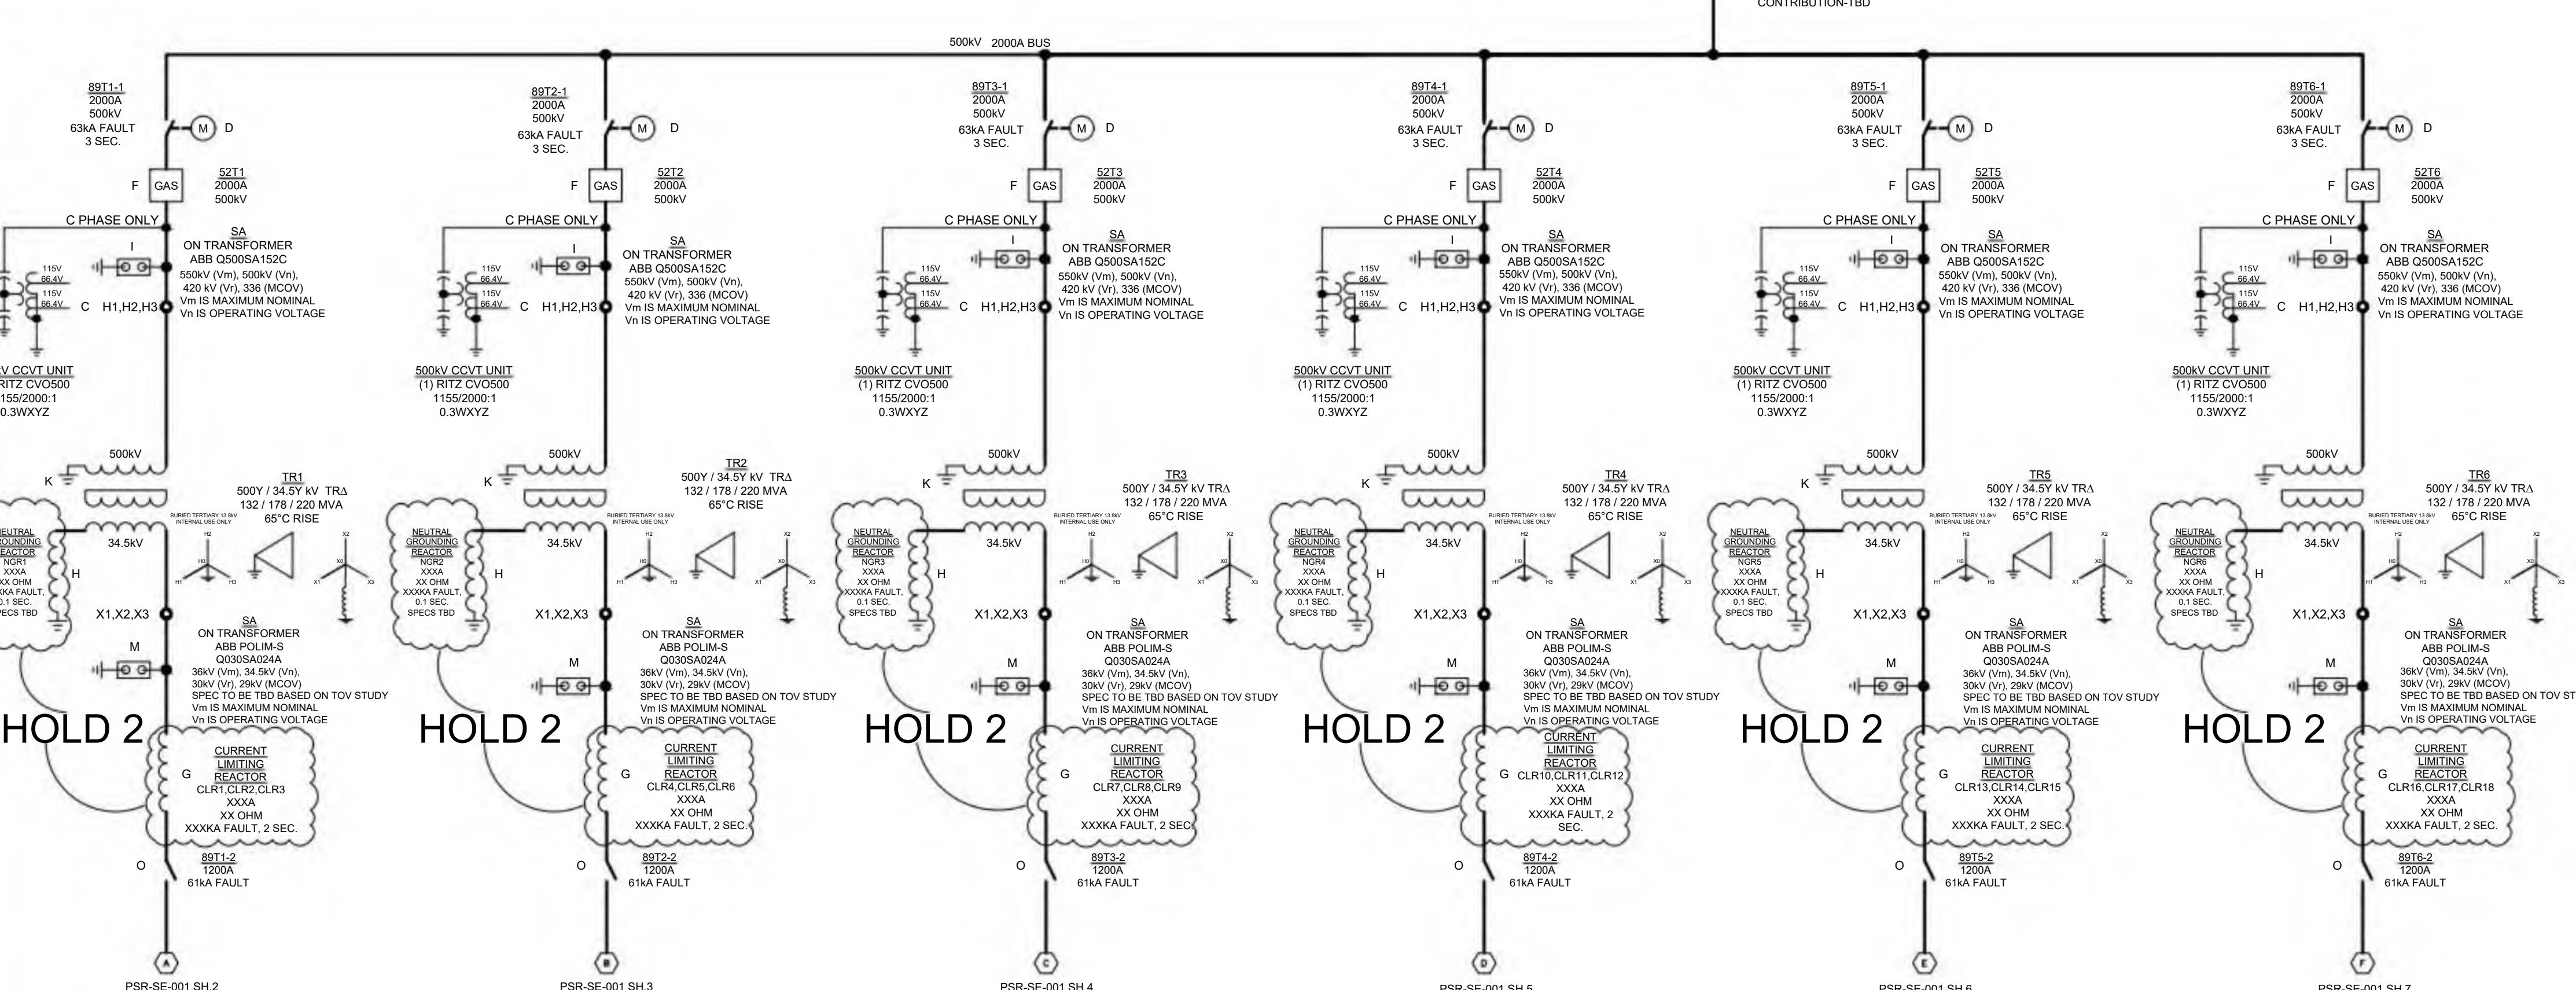
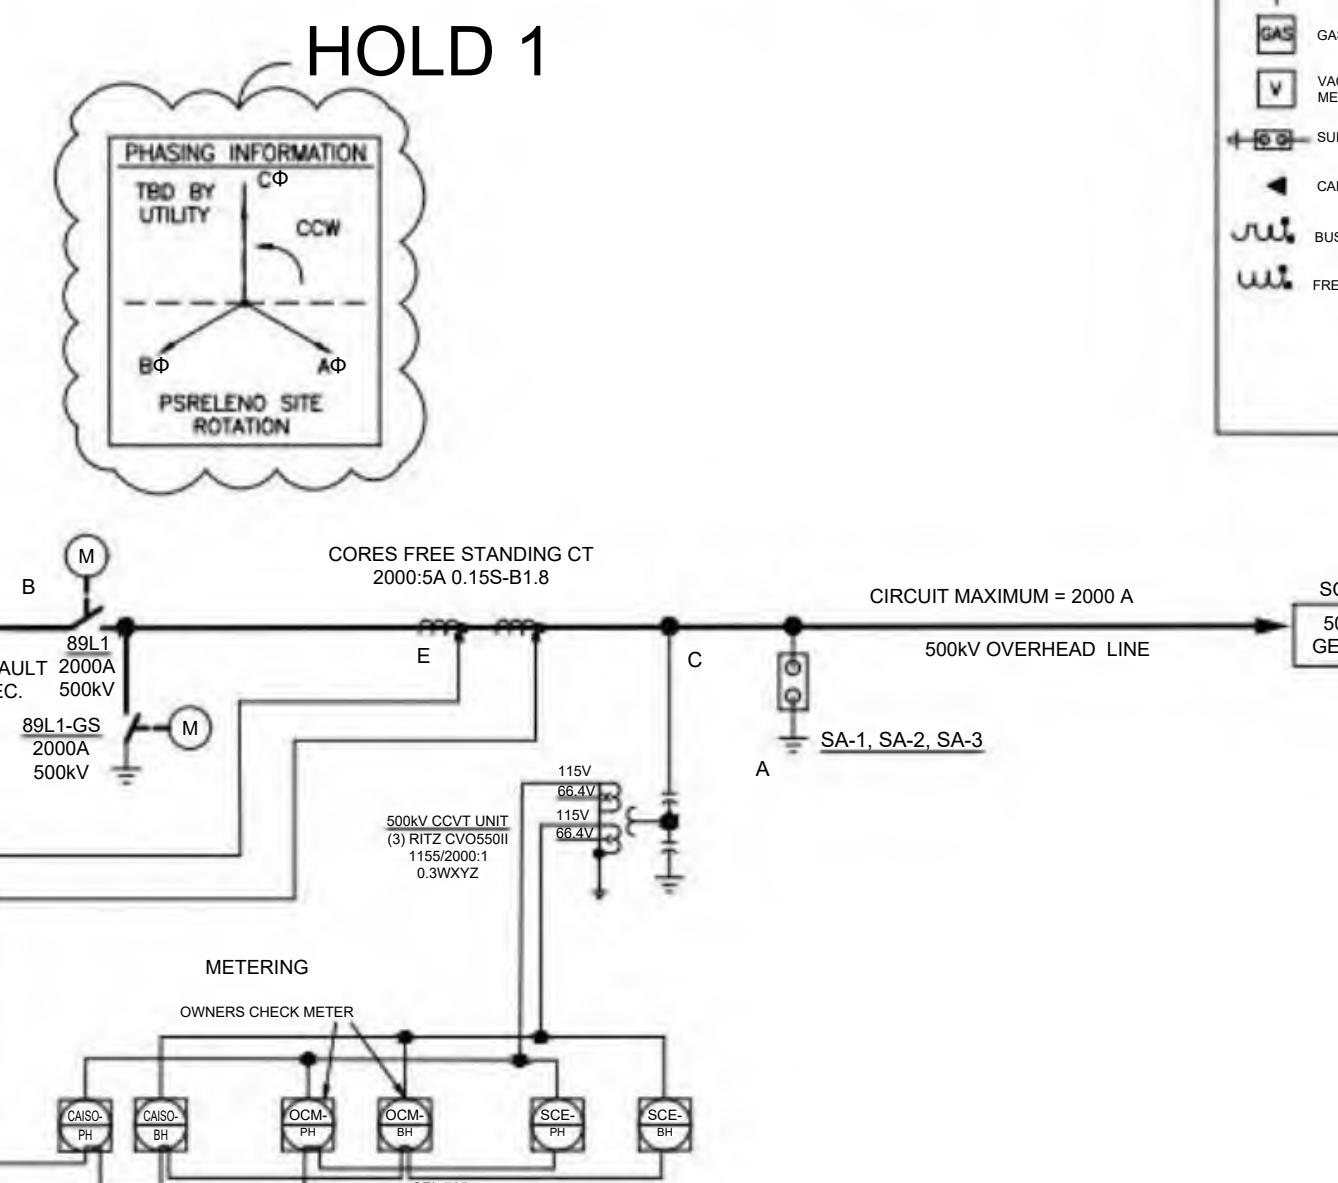
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<p>PLAN</p>																				
<p>NOTES:</p> <ol style="list-style-type: none"> 1. ALL REINFORCING TO BE DESIGNED BY THE VENDOR. 2. DRAWING REPRESENTS A TYPICAL ENERGY DISSIPATOR THAT MAY BE USED FOR THE PROJECT. ACTUAL VENDOR DIMENSIONS MAY VARY SLIGHTLY FROM THOSE SHOWN. 							<p>CAD FILE NAME: PSR-CS-009.DWG PREPARED BY: CAF/JN REVIEWED BY: JTP APPROVED BY: --</p> <p>ANY MODIFICATION OR ADDITION TO THIS DRAWING BY AN ORGANIZATION OTHER THAN SARGENT & LUNDY, IS NOT THE RESPONSIBILITY OF SARGENT & LUNDY.</p> <p>Sargent & Lundy SARGENT & LUNDY 55 EAST MONROE STREET CHICAGO, ILLINOIS 60603-5780</p>													
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<p>SECTION B-B</p>																				
<p>ENERGY DISSIPATOR DETAILS</p>							<p>DRAWING NUMBER: PSR-CS-010 REVISION: 0C SHEET 1 OF 1</p>													
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<p>PRAIRIE SONG RELIABILITY PROJECT</p>							<p>DRAWING TITLE \$FILEABBREV\$ \$TIME\$ \$DATE\$</p>													
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ITEM	LIST OF EQUIPMENT		
A	SURGE ARRESTER, ABB PECLIM P-Y OR SIMILAR, 550kV (Vm), 500kV (Vn), 420 KV (Vr), 336 MCOV, (QTY 3), WITH INSULATING BASE KIT	M	SURGE ARRESTER, SUPPLIED K, 36kV (Vm), 34.5kV (Vn), MCOV, (QTY 18) - 3 PER TRANSFORMER
B	MOTOR OPERATED DISCONNECT, SOUTHERN STATES EV2H OR SIMILAR, MOTOR OPERATED, 550kV (Vm), 3 PHASE GPSR OPERATED, PUSH BUTTON OPEN/CLOSE WITH TIME DELAY, REMOTE/LOCAL SWITCH, BREAKER INTERLOCK IN MOTOR CIRCUIT, 2000A, 125VDC MOTOR AND CONTROL CIRCUIT, RATED BIL 1800kV, 80kA FOR 3 SEC., 208kA MECHANICAL PEAK, SEISMIC QUALIFIED FOR IEEE-693 SUPPLIED W/STAND, W/MOTORIZED GROUNDING SWITCH ON UTILITY SIDE. MAIN SWITCH AND GROUNDING SWITCH ARE INTERLOCKED SO THAT BOTH CANNOT BE SIMULTANEOUSLY CLOSED. (QTY 1)	O	MANUALLY OPERATED DISCONNECT, SOUTHERN STATES EV2H OR SIMILAR, MOTOR OPERATED, 38kV (Vm), 34.5kV (Vn), 400A, 80kA FOR 3 SEC., 208kA MECHANICAL PEAK, SEISMIC QUALIFIED FOR IEEE-693
C	CCVT, RITZ CVO550EI, 550kV (Vm), OPERATED AT 500kV, X & Y SECONDARY, 289kV-115/66.4V, 0.3Z ACCURACY, 0.62Z FOR TWO WINDINGS, 1000VA (QTY 9)	P	CURRENT TRANSFORMER, RITZ CVO550EI, 550kV (Vm), 35kV, 2000:5, 0.15S-B1.6, RF XX, WITH PLUG (QTY 18)
D	MOTOR OPERATED DISCONNECT, SOUTHERN STATES EV-2H OR SIMILAR, 550kV (Vm), DC MOTOR 125 V DC, PUSH BUTTON OPEN/CLOSE WITH TIME DELAY, 3 PHASE GPSR OPERATED, REMOTE/LOCAL SWITCH, BREAKER INTERLOCK IN MOTOR CIRCUIT, 2000 A, RATED BIL 1800kV, 63kA FOR 3 SEC, 164kA MECHANICAL PEAK, SEISMIC QUALIFIED FOR IEEE-693 SUPPLIED W/STAND, (QTY 6)	R	DISCONNECT SWITCH, CLEVE 34.5kV, 1200A, THREE PHASE, RATED MOMENTARY CURRENT 200kV, (QTY 72)
E	OIL FILLED CT, GE VERNONA OSKF550 OR SIMILAR 550kV (Vm), TWO (2) CT CORES 2000:5A FOR METERING 0.15S-B1.6 (HI ACCURACY EXTENDED RPSRE) BURDEN OF 45VA, CT RF 2 (QTY 3)	S	CIRCUIT BREAKER, MYERS OR SIMILAR, 38kV, MIN 1200 A, SYMMETRIC CURRENT 31.5kA, DUAL TRIP, INTERRUPT TIME, 125VDC CONTROL/CLOSING/TRIP/MOTOR INDICATORS (MIN 10 EACH FOR 240VAC AC HEATER (SINGLE RECEPTACLE, 2 CTs PER POLE) -30C TO 50C AMBIENT, 150G GROUND PADS (2) FOR NEMA CONNECTORS (QTY 36)
F	CIRCUIT BREAKER, SIEMENS SPS2, SF6 GAS INSULATED OR SIMILAR, DEAD TANK, 550kV (Vm), OPERATED AT 500kV, 2000A, - 63kA SHORT CIRCUIT BREAKING CURRENT, DUAL TRIPS, INTERRUPTING TIME 2 OR 3 CYCLES, DC CIRCUITS 125VDC, AC CIRCUITS 240V/120V, W/3 CTs PER EACH POLE - MULTI RATIO 2000:5 C800 RF 2.0, ALARMS FOR: SF6 TRIP, LOW SF6, LOSS OF AC & DC CONTROL POWER & SPRING DISCHARGE ALARM, 120VAC RECEPTACLES, GROUND BAR IN CABINET (QTY 7)	T	SURGE ARRESTER, ABB POLARIS OR SIMILAR, 34.5kV, 36kV (Vm), 30kV (Vn), 29kV MCOV, (QTY 18)
G	CURRENT LIMITING REACTOR, TRENCH OR SIMILAR XXXA, XXX OHM, XXXKA THERMAL FOR 2 SEC., XXXKA MECHANICAL PEAK, QTY (18)		
H	NEUTRAL GROUNDING REACTOR, TRENCH OR SIMILAR, XXXA, XXX OHM REACTANCE, XXXKA THERMAL FOR 0.1 SEC., XXXKA MECHANICAL PEAK, QTY (6)		
I	SURGE ARRESTER, ABB OR SIMILAR, SUPPLIED W/TRANSFORMER ITEM K, 550kV (Vm), 500kV (Vn), 420 KV (Vr), 336 MCOV, (QTY 18) - 3 PER TRANSFORMER		
K	TRANSFORMER, WEG, GE PROLEC OR SIMILAR, 500/34.5kV, TERTIARY 13.8kV INTERNAL USE ONLY, 132/178/220 MVA, ONAN/ONAF/ONAF, SPECIFIED Z=10.5% @ 132 MVA, OLTC HV +/-10% W/ 16 STEPS ON EACH SIDE (QTY 6)		
L	POTENTIAL TRANSFORMER, RITZ STYLE VEF36-10A OR SIMILAR, 34.5kV, RATED BIL 200kV, 0.3WXY ACCURACY, MIN 0.8VA BURDEN, 175/300:1 & 175/300:1, X & Y (QTY 18)		



NOTES:

- 1) ITEMS L,P,Q,R,S,T, & U ARE SHOWN ON SHEETS 2,3,4,5,6,7
- 2) VOLTAGES SHOWN FOR DEVICES ARE MAXIMUM RATING UNLESS STATED OTHERWISE
- 3) SECONDARY VOLTAGES ARE CALCULATED BASED ON NOMINAL PHASE TO PHASE VOLTAGE



HOLD INFORMATION	
DESCRIPTION	
PHASING TBD BY UTILITY	
REACTOR RATINGS ON HOLD PENDING	
DETAILED DESIGN ENGINEERING STUDIES	
CONTRACTOR/INSTALLER SHALL TAKE ALL APPROPRIATE PRECAUTIONS TO ENSURE THE SAFETY OF ALL PEOPLE LOCATED ON THE WORK SITE, INCLUDING CONTRACTOR'S/INSTALLER'S PERSONNEL (OR THAT OF ITS CONTRACTOR(S)) PERFORMING THE WORK.	
RELEASE INFORMATION	
DATE	DESCRIPTION
03/31/2025	ISSUED FOR PERMIT
05/14/2025	ISSUED FOR PERMIT

Table 1. Summary of the main characteristics of the four groups of patients.

THE PURPOSE: ISS

IFICATION:

ECT NO.: 15474.001

I EBY CERTIFY THAT THIS ENGINEERING
UMENT WAS PREPARED BY ME OR UNDER
RECT PERSONAL SUPERVISION AND
I AM A DULY LICENSED PROFESSIONAL
NEER UNDER THE LAWS OF THE STATE
CALIFORNIA.

ISSUED FOR PRELIMINARY PURPOSES
GREG MAGSAYSAY
P.E. NO.E17455

FILE NAME: PSR-SE-001_S001.DWG
CREATED BY: ME

ARED BY: ME
Ewed BY: GM
oved BY: GM
MODIFICATION OR ADDITION TO THIS
VING BY AN ORGANIZATION OTHER THAN
ENT & LUNDY, IS NOT THE

SARGENT & LUNDY
55 EAST MONROE STREET
CHICAGO, ILLINOIS 60602-5720

PROJECT

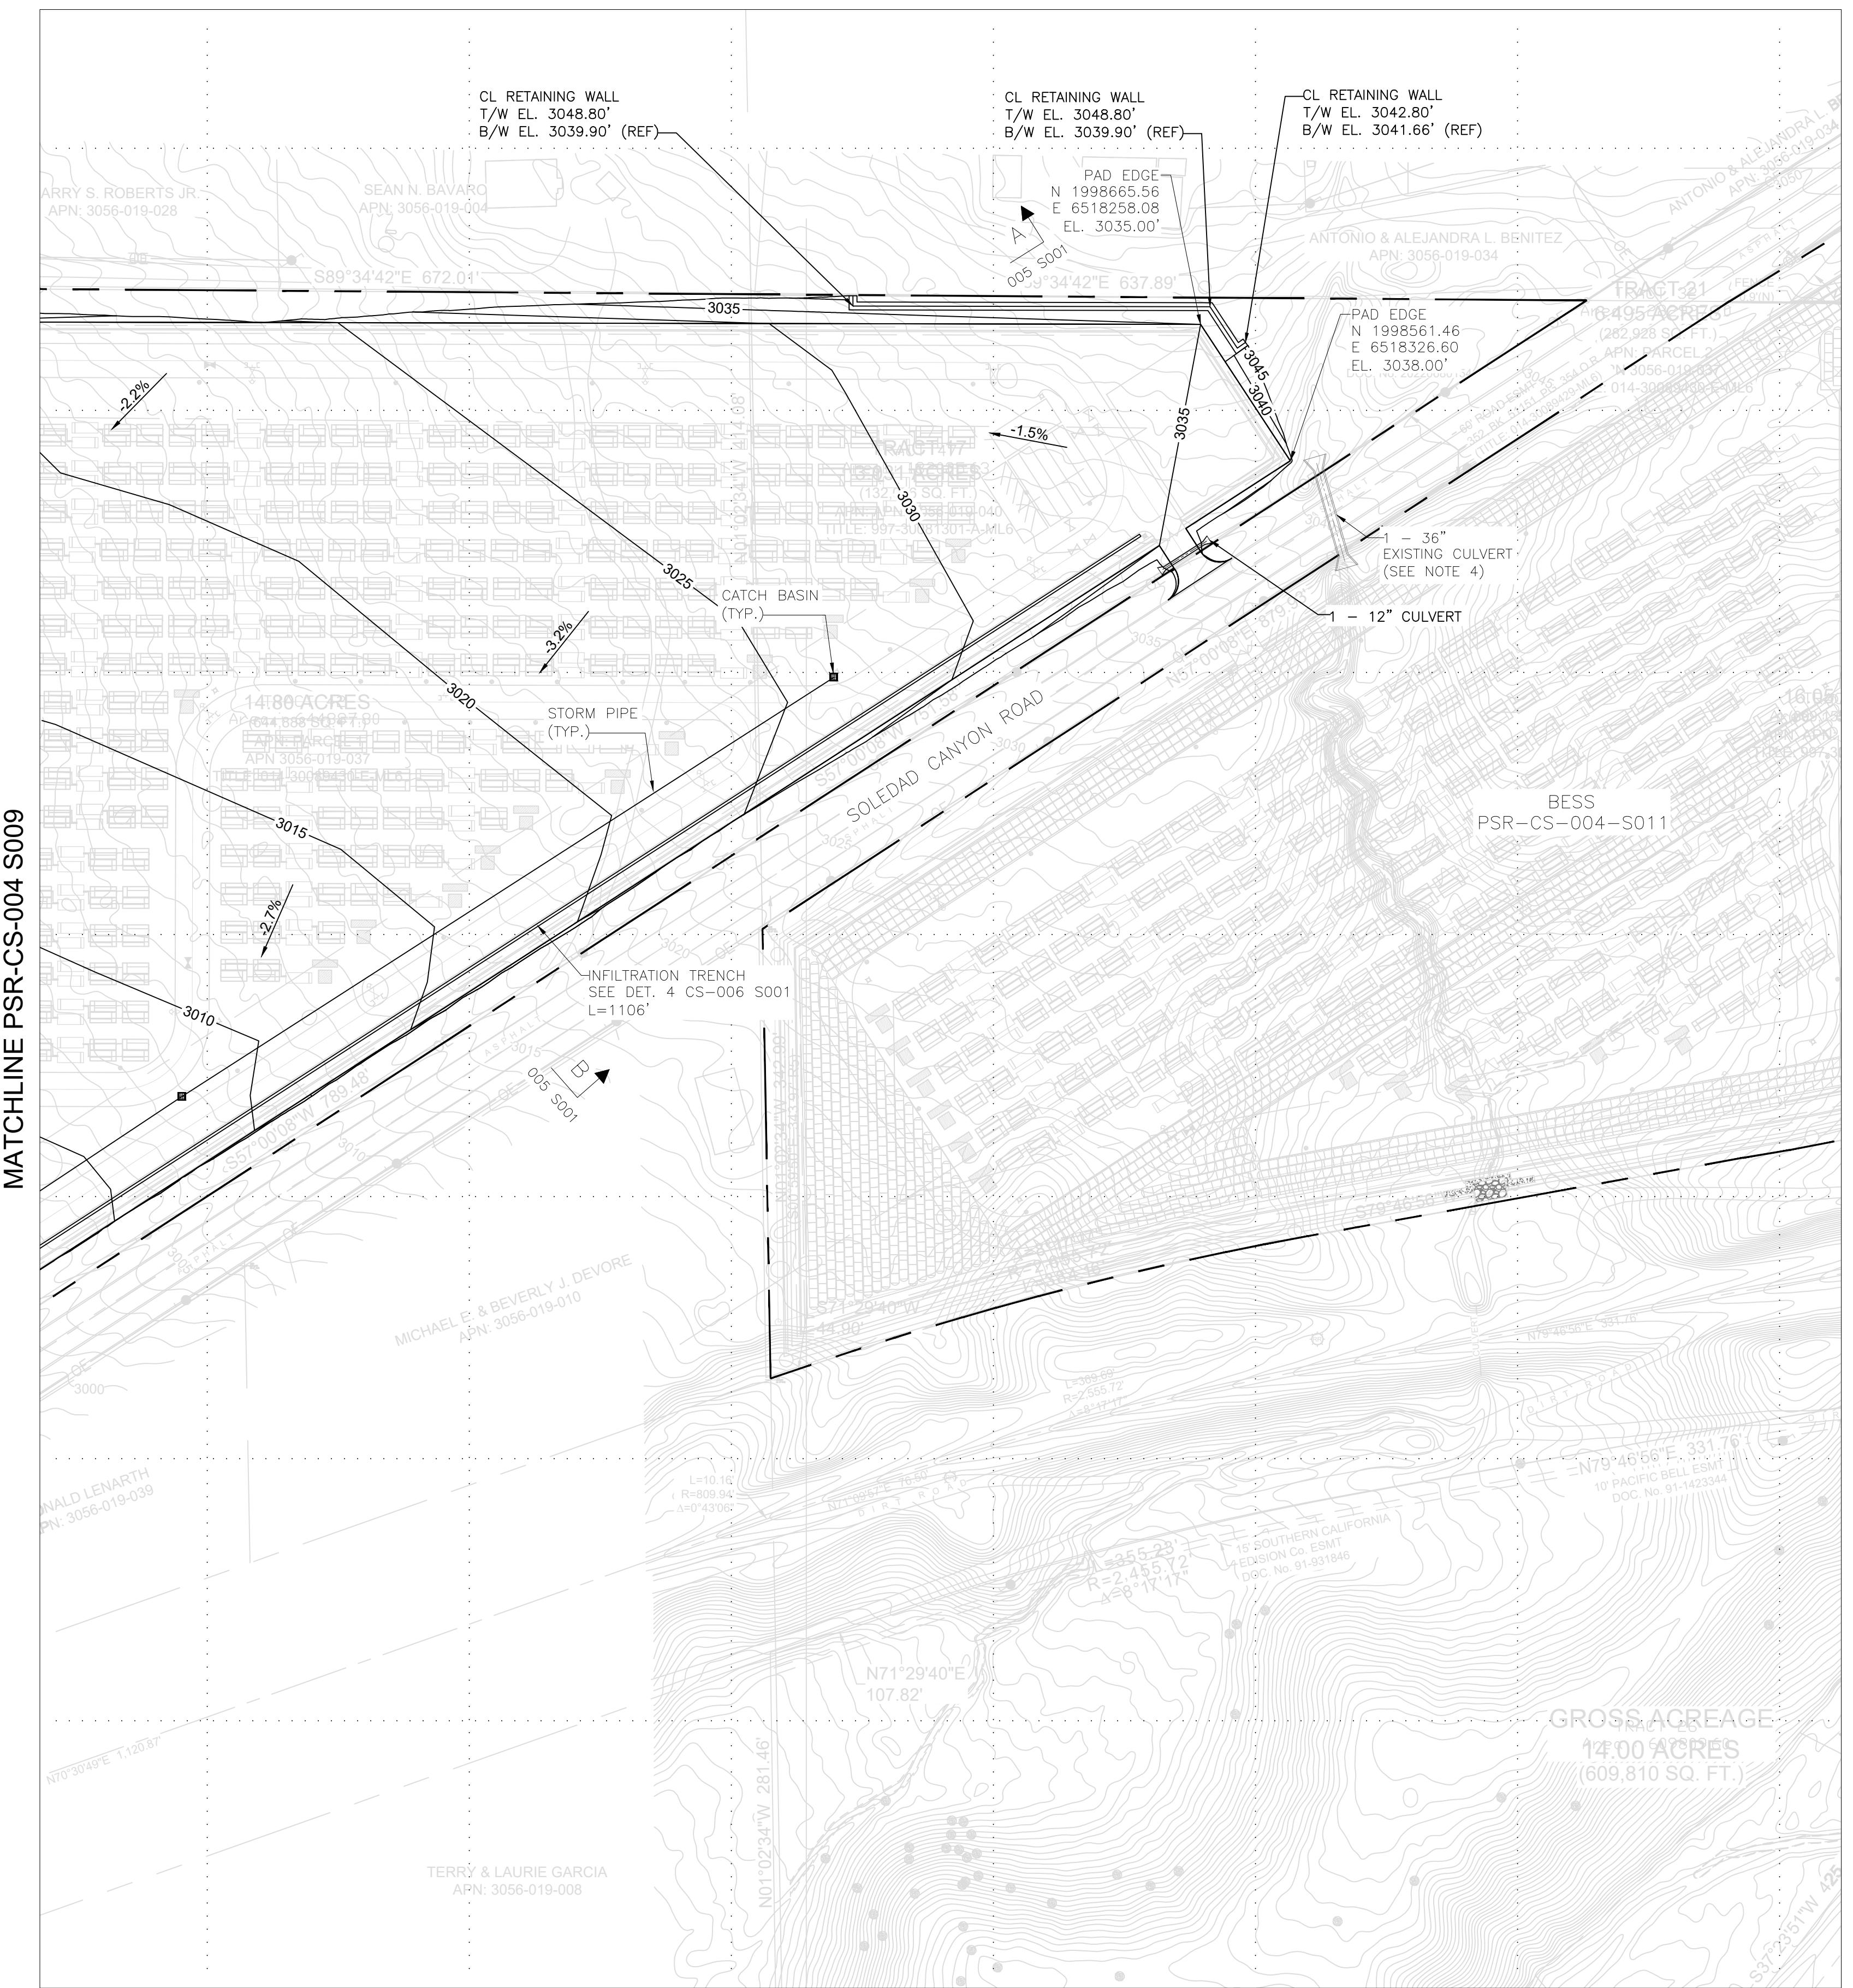
PRAIRIE SONG

RELIABILITY PROJECT

DRAWING TITLE

SINGLE LINE

DRAWING NUMBER	REVISION
PSR-SE-001	0B
HEET 1 OF 8	



PERMIT ONLY
NOT FOR CONSTRUCTION

VICINITY MAP



NOTES

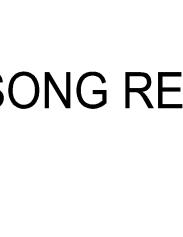
1. GEOTECHNICAL ENGINEERING REPORT PREPARED BY:
TERRACON CONSULTANTS INC., PROJECT NO. LA245085, DATED 05-14-2025.
2. FOR GENERAL NOTES, ABBREVIATIONS AND LEGEND SEE DRAWING PSR-CS-002.
3. ESTIMATED QUANTITIES: * SEE NOTES ON DRAWING PSR-CS-004 S009
4. EXISTING CULVERT WILL BE MAINTAINED THROUGHOUT CONSTRUCTION. THE
DOWNSTREAM END OF THE CULVERT WILL BE CONNECTED TO A NEW MANHOLE TO
PROVIDE CONTINUATION OF STORM WATER CONVEYANCE DOWNSTREAM OF THE
BESS FACILITY.

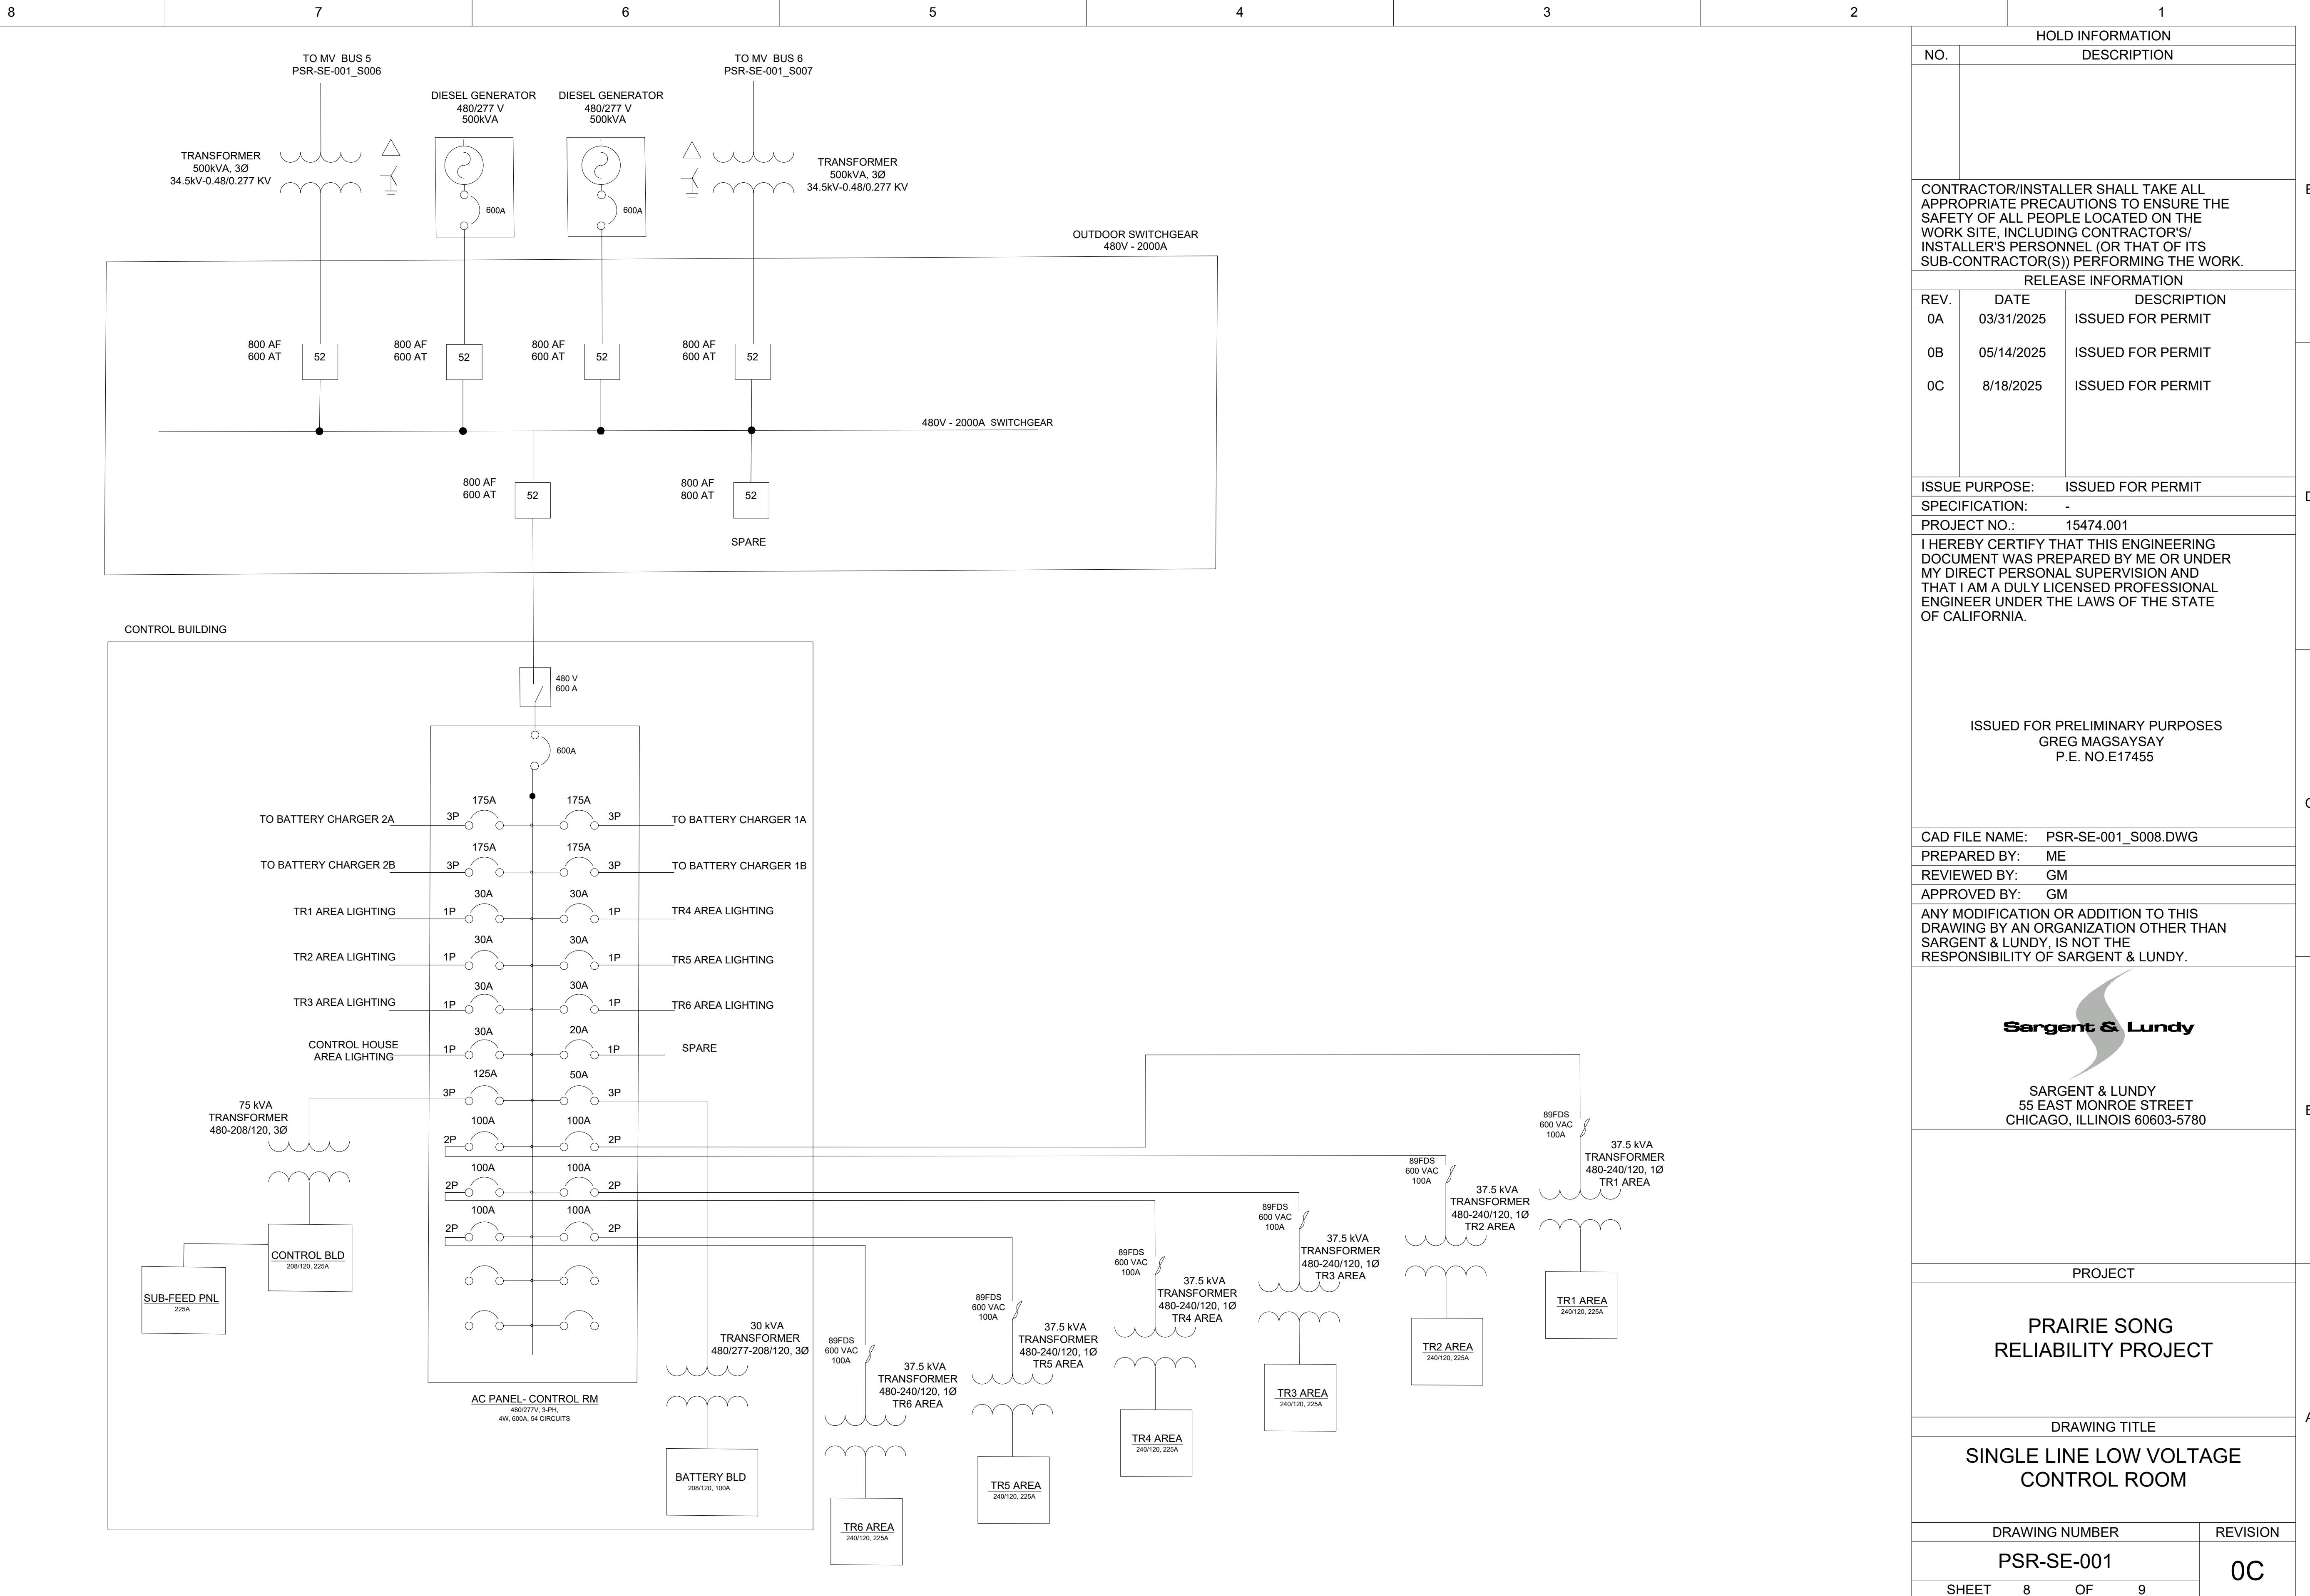
REFERENCE DRAWINGS

UNDERGROUND OR EMBEDDED UTILITIES MAY BE LOCATED WITHIN OR ADJACENT TO THE AREA IN WHICH EXCAVATION, DEMOLITION, FOUNDATION, OR MODIFICATION WORK IS TO BE PERFORMED.

REFERENCES RELATING TO THE UNDERGROUND OR EMBEDDED UTILITIES ARE PROVIDED TO ASSIST THE CONTRACTOR/INSTALLER IN THE FIELD LOCATING THOSE UTILITIES AND OTHER POSSIBLE UNDERGROUND OR EMBEDDED INTERFERENCES WITH THE WORK

THE CONTRACTOR/INSTALLER SHALL EXERCISE DUE CAUTION DURING ALL EXCAVATION/FOUNDATION/DEMOLITION WORK.

HOLD INFORMATION		
O.	DESCRIPTION	
CONTRACTOR/INSTALLER SHALL TAKE ALL APPROPRIATE PRECAUTIONS TO ENSURE THE SAFETY OF ALL PEOPLE LOCATED ON THE WORK SITE, INCLUDING CONTRACTOR'S/INSTALLER'S PERSONNEL (OR THAT OF ITS SUB-CONTRACTOR(S)) PERFORMING THE WORK.		
RELEASE INFORMATION		
REV.	DATE	DESCRIPTION
A	2/14/2025	ISSUED FOR 30%
B	3/31/2025	ISSUED FOR PERMIT
C	5/16/2025	ISSUED FOR PERMIT
D	8/15/2025	ISSUED FOR PERMIT
ISSUE PURPOSE:		ISSUED FOR PERMIT
SPECIFICATION:		-
PROJECT NO.:		15474.001
I HEREBY CERTIFY THAT THIS ENGINEERING DOCUMENT WAS PREPARED BY ME OR UNDER MY DIRECT PERSONAL SUPERVISION AND THAT I AM A DULY LICENSED PROFESSIONAL ENGINEER UNDER THE LAWS OF THE STATE OF CALIFORNIA.		
ISSUED FOR PRELIMINARY PURPOSES JOSHUA BICKETT P.E. LICENSE #95825		
DRAW FILE NAME: PSR-CS-004 S010.DWG		
PREPARED BY: CAF/JN		
REVIEWED BY: JTP		
APPROVED BY: --		
ANY MODIFICATION OR ADDITION TO THIS DRAWING BY AN ORGANIZATION OTHER THAN SARGENT & LUNDY, IS NOT THE RESPONSIBILITY OF SARGENT & LUNDY.		
 Sargent & Lundy 55 EAST MONROE STREET CHICAGO, ILLINOIS 60603-5780		
PROJECT		
DRAWING TITLE		
RESS GRADING AND DRAINAGE PLAN		
DRAWING NUMBER	REVISION	
PSR-CS-004 S010	0D	
SHEET 1 OF 1		



HOLD INFORMATION

NO.	DESCRIPTION
CONTRACTOR/INSTALLER SHALL TAKE ALL APPROPRIATE PRECAUTIONS TO ENSURE THE SAFETY OF ALL PEOPLE LOCATED ON THE WORK SITE, INCLUDING CONTRACTOR'S/ INSTALLER'S PERSONNEL (OR THAT OF ITS SUB-CONTRACTOR(S)) PERFORMING THE WORK.	

RELEASE INFORMATION

REV.	DATE	DESCRIPTION
0A	03/31/2025	ISSUED FOR PERMIT
0B	05/14/2025	ISSUED FOR PERMIT
0C	08/18/2025	ISSUED FOR PERMIT

ISSUE PURPOSE: ISSUED FOR PERMIT

SPECIFICATION:	-
PROJECT NO.:	15474.001

I HEREBY CERTIFY THAT THIS ENGINEERING DOCUMENT WAS PREPARED BY ME OR UNDER MY DIRECT PERSONAL SUPERVISION AND THAT I AM A DULY LICENSED PROFESSIONAL ENGINEER UNDER THE LAWS OF THE STATE OF CALIFORNIA.

ISSUED FOR PRELIMINARY PURPOSES
GREG MAGSAYSAY
P.E. NO.E17455

CAD FILE NAME: PSR-SE-001_S009.DWG

PREPARED BY:	ME
REVIEWED BY:	GM
APPROVED BY:	GM

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SARGENT & LUNDY
55 EAST MONROE STREET
CHICAGO, ILLINOIS 60603-5780

PROJECT
PRAIRIE SONG
RELIABILITY PROJECT

DRAWING TITLE
SINGLE LINE LOW VOLTAGE
O&M BUILDING

DRAWING NUMBER	REVISION
PSR-SE-001	0C
SHEET 9 OF 9	

